New Santa Rita Residence

Santa Rita 2 SW of 5th, Carmel, CA, 93923

GENERAL NOTES

- EXAMINATION OF THE SITE AND PORTIONS THEREOF WHICH WILL AFFECT THIS WORK SHALL BE MADE IMMEDIATELY BY THE CONTRACTOR, WHO SHALL COMPARE IT WITH THE DRAWINGS AND SATISFY HIMSELF TO CONDITIONS UNDER WHICH WORK IS TO BE PERFORMED. HE SHALL AT SUCH TIME ASCERTAIN AND CHECK LOCATIONS OF THE EXISTING STRUCTURES AND EQUIPMENT WHICH MAY AFFECT
- THE ARCHITECT SHALL NOT BE RESPONSIBLE FOR CONSTRUCTION MEANS AND METHODS, ACTS OR OMISSIONS OF THE CONTRACTOR OR SUBCONTRACTOR, OR FAILURE ON ANY OF THEM TO CARRY OUT WORK IN ACCORDANCE WITH CONSTRUCTION DOCUMENTS. ANY DEFECT DISCOVERED IN CONSTRUCTION DOCUMENTS SHALL BE BROUGHT TO THE ATTENTION OF THE ARCHITECT BY WRITTEN NOTICE BEFORE PROCEEDING WITH WORK.
- ALL CONSTRUCTION WORK, MECHANICAL, PLUMBING, ELECTRICAL, ETC., AS MAY BE REQUIRED, SHALL CONFORM TO THE LATEST EDITION OF THE CALIFORNIA RESIDENTIAL CODE AND THE LATEST EDITION OF ALL GOVERNING CODES AND REGULATIONS AS ADOPTED BY THE CITY OF CARMEL. ALL WORK SHALL BE DONE IN A THOROUGH, WORKMANLIKE MANNER AND EQUAL TO THE BEST STANDARDS OF THE PRACTICE
- DETAILS NOTED AS 'TYPICAL' SHALL APPLY IN ALL LIKE CONDITIONS UNLESS SPECIFICALLY SHOWN OR NOTED OTHERWISE. WHERE NO SPECIFIC DETAIL IS SHOWN, THE FRAMING OR CONSTRUCTION SHALL BE IDENTICAL OR SIMILAR TO THAT INDICATED FOR LIKE CASES OF CONSTRUCTION OF THIS PROJECT.
- DIMENSIONS, DETAILS, NOTES, AND/OR SYMBOLS THAT APPLY TO ONE UNIT, APPLY TO ALL UNITS IN LIKE SITUATIONS UNLESS NOTED OTHERWISE.
- ALL DIMENSIONS ON CONSTRUCTIONS DRAWINGS ARE TO FACE OF STUD (F.O.S.), OR FACE OF CONCRETE (F.O.C.), UNLESS OTHERWISE NOTED. WRITTEN DIMENSIONS ON THESE DRAWINGS SHALL HAVE PRECEDENCE OVER SCALED DIMENSIONS. CONTRACTOR SHALL VERIFY AND BE RESPONSIBLE FOR ALL DIMENSIONS AND CONDITIONS ON THE JOB. THE ARCHITECT MUST BE NOTIFIED OF ANY VARIATIONS FROM THE DIMENSIONS AND CONDITIONS SHOWN BY THESE DRAWINGS.
- THE STRUCTURE IS DESIGNED AS A STABLE UNIT AFTER ALL COMPONENTS ARE IN PLACE. THE CONTRACTOR SHALL PROVIDE ALL SHORING AND BRACING NECESSARY TO ENSURE THE STABILITY OF ANY AND ALL PARTS OF THE BUILDING DURING CONSTRUCTION.

• WORK WHICH IS OBVIOUSLY REQUIRED TO BE PERFORMED IN ORDER TO PROVIDE

- A COMPLETELY OPERABLE INSTALLATION WITHIN THE LIMITS AND SCOPE OF WORK, BUT WHICH MAY NOT BE SPECIFICALLY INCLUDED IN THE PLANS, SHALL BE PERFORMED BY CONTRACTOR

 THE CONTRACTOR IS RESPONSIBLE TO VERIFY LOCATION OF ALL SITE UTILITIES
- AND TO COORDINATE AND AVOID CONFLICT IN THE LOCATIONS OF NEW UNDERGROUND AND SITE UTILITIES.

 THE CONTRACTOR SHALL SUBMIT SHOP DRAWINGS FOR FABRICATED ITEMS, CUT SHEETS OF ALL FIXTURES AND EQUIPMENT, AND SAMPLES OF ALL FINISHES

CALLED FOR BY THE ARCHITECT AND OWNER FOR APPROVAL PRIOR TO

- CONSTRUCTION AND/OR INSTALLATION.

 CONTRACTOR SHALL PERSONALLY SUPERVISE AND DIRECT THE WORK OR SHALL KEEP A COMPETENT EMPLOYEE, AUTHORIZED TO RECEIVE INSTRUCTIONS AND ACT ON THE CONTRACTOR'S BEHALF, CONTINUOUSLY ON SITE DURING WORKING
- ALL WORK SHALL BE GUARANTEED AGAINST DEFECTS IN DESIGN, INSTALLATION AND MATERIAL FOR A MINIMUM PERIOD OF ONE YEAR FROM DATE OF COMPLETION.
- CONTRACTOR SHALL PROTECT OWNER'S AREA, NEW AND/OR EXISTING MATERIALS AND FINISHES FROM DAMAGE WHICH MAY OCCUR FROM CONSTRUCTION, DEMOLITION, DUST, WATER, ETC., AND SHALL PROVIDE AND MAINTAIN TEMPORARY BARRICADES, CLOSURE WALLS, ETC., AS REQUIRED TO PROTECT THE PUBLIC AND OWNER DURING THE PERIOD OF CONSTRUCTION. DAMAGE TO NEW AND EXISTING MATERIALS, FINISHES, STRUCTURES, AND EQUIPMENT SHALL BE REPAIRED OR REPLACED. CONTRACTOR SHALL COORDINATE TEMPORARY BARRICADES WITH OWNER PRIOR TO COMMENCEMENT OF WORK AS NECESSARY.
- THE CONTRACTOR SHALL REMOVE ALL RUBBISH AND WASTE MATERIALS OF ALL SUBCONTRACTORS AND TRADES ON A REGULAR BASIS, AND SHALL EXERCISE STRICT CONTROL OVER JOB CLEANING TO PREVENT ANY DIRT, DEBRIS OR DUST FROM AFFECTING, IN ANY WAY, FINISHED AREAS IN OR OUTSIDE THE JOB SITE.
- ALL HOSES USED IN CONNECTION WITH ANY CONSTRUCTION ACTIVITIES SHALL BE EQUIPPED WITH A NOZZLE SHUT-OFF. WHEN AN AUTOMATIC SHUT-OFF NOZZLE CAN BE PURCHASED OR OTHERWISE OBTAINED FOR THE SIZE OR TYPE OF HOSE IN USE, THE NOZZLE SHALL BE AN AUTOMATIC SHUT-OFF NOZZLE.
- NO POTABLE WATER MAY BE USED FOR COMPACTION OR DUST CONTROL PURPOSES IN CONSTRUCTION ACTIVITIES WHERE THERE IS A REASONABLY AVAILABLE SOURCE OF RECLAIMED OR OTHER SUB-POTABLE WATER APPROVED BY THE CITY OF CARMEL AND APPROPRIATE FOR SUCH USE.
- THE USE OF SOLDERS CONTAINING LEAD IN MAKING JOINTS ON PRIVATE OR PUBLIC WATER SUPPLY SYSTEMS IS PROHIBITED.
- PROVIDE NON-REMOVABLE BACKFLOW DEVICES AT ALL HOSE BIBS.
- SEWER BACK WATER VALVE AND SEWER RELIEF VENT IS REQUIRED

EROSION CONTROL NOTES

1. BETWEEN OCTOBER 15TH AND APRIL 15TH DISTURBED SURFACES NOT INVOLVED IN THE IMMEDIATE OPERATIONS MUST BE PROTECTED BY MULCHING AND/OR OTHER EFFECTIVE MEANS OF SOILS PROTECTION.

2. RUN-OFF FROM THE SITE SHALL BE DETAINED OR FILTERED BY BERMS. VEGETATED FILTER STRIPS AND/OR CATCH BASINS TO PREVENT THE ESCAPE OF SEDIMENT FROM THE DISTURBED AREA OR SITE. THESE DRAINAGE CONTROL MEASURES MUST BE MAINTAINED BY THE CONTRACTOR AS NECESSARY TO ACHIEVE THEIR PURPOSE THROUGHOUT THE LIFE OF THE PROJECT.

FIRE NOTES

GYP. BD.

GYPSUM BOARD

1. THE BUILDING SHALL BE FULLY PROTECTED WITH AUTOMATIC FIRE SPRINKLER SYSTEM(S). INSTALLATION SHALL BE IN ACCORDANCE WITH THE APPLICABLE NFPA STANDARD. A MINIMUM OF FOUR (4) SETS OF PLANS FOR FIRE SPRINKLER SYSTEMS MUST BE SUBMITTED BY A CALIFORNIA LICENSED C-16 CONTRACTOR AND APPROVED PRIOR TO INSTALLATION. THIS REQUIREMENT IS NOT INTENDED TO DELAY ISSUANCE OF A BUILDING PERMIT.

2. ALL NEW STRUCTURES, AND ALL EXISTING STRUCTURES RECEIVING NEW ROOFING OVER 50 PERCENT OR MORE OF THE EXISTING ROOF SURFACE WITHIN A ONE—YEAR PERIOD, SHALL REQUIRE A MINIMUM OF ICBO CLASS A ROOF CONSTRUCTION.



SANTA RITA STREET ELEVATION

	AE	BBREVIATIONS
ANCHOR BOLT ABOVE	HDR.	HEADER
ALTERNATE	HGR. HDWD.	HANGER HARDWOOD
ALUMINUM	HORIZ.	HORIZONTAL
APPROXIMATE	INT.	INTERIOR
ARCHITECT	INSUL.	INSULATION
ASPHALT	JST.	JOIST
AUTOMATIC	K	KIPS (1,000 LBS.)
BOARD	L.V.L.	LEVEL
BLOCKING	MAX.	MAXIMUM
BUILDING	M.B.	MACHINE BOLT
BEAM	MIN.	MINIMUM
BOTTOM	M.I.W.	MALLEABLE IRON WASHER
BETWEEN	(N)	NEW
CONTRACTION JOINT CLEAR	N.I.C.	NOT IN CONCRACT
COLUMN	N.T.S. O/	NOT TO SCALE OVER
CONCRETE		OVER ON CENTER
CONCRETE BLOCK	O.C. P.E.N.	PLY EDGE NAILING
CONNECTION	PL.	PLATE
CONSTRUCTION	P.T.D.F.	PRESSURE TREATED DOUGLAS FIR
CONTINUOUS	PLYWD.	PLYWOOD
CENTER	REINF.	REINFORCED
COUNTERSINK	REQ'D	REQUIRED
DOUGLAS FIR	REV.	REVERSED
DOUBLE	S.A.D.	SEE ARCH. DRAWING
DIAMETER DRAWING	S.B.	SOLID BLOCKING
EACH	S.F.	SQUARE FOOT
EDGE NAILING	S.O.G.	SLAB ON GRADE
ELEVATION	SCHED. SHT.	SCHEDULE SHEET
ELEVATION	SHTG.	SHEET SHEATHING
EQUAL	SIM.	SIMILIAR
EXISTING	SPEC.	SPECIFCATIONS
EXPANSION	STD.	STANDARD
EXTERIOR	T.&G.	TONGUE & GROOVE
FIRE EXTINGUISHER	T.N.	TOE NAIL
FINISH GRADE	T.O.C.	TOP OF CONCRETE
FLOOR	T.O.P.	TOP OF PLATE
FIELD NAILING	T.O.W.	TOP OF WALL
FOUNDATION	T.S.	TUBE STEEL
FACE OF MASONRY FEET	TYP.	TYPICAL
FOOTING	U.O.N.	UNLESS OTHERWISE NOTED
GAUGE	VERT.	VERTICAL WITH
GALVANIZED	W/ W/O	WITH
GALVINIZED IRON	W.W.M.	WELDED WIRE MESH
GLUE LAMINATED	W.I.	WROUGHT IRON
GRADE		

PROJECT DATA

PROPERTY OWNER:

MS. JIE MEI

17201 SONORA RD.

OAKDALE, CA 95361

STREET ELEVATION

PROJECT ADDRESS:

TEL. (408) 497-0349

SANTA RITA 2 SW OF 5TH CARMEL, CA 93923

PROJECT DESCRIPTION/ SCOPE OF WORK:

1. NEW TWO-STORY SINGLE FAMILY RESIDENCE WITH ATTACHED GARAGE

(1,800 SF). ROOF TOP DECK (246 SF) LOCATED ABOVE SINGLE—STORY MASTER BEDROOM/ BATHROOM

LOT: 5 BLOCK: 61 010-038-002-000

LEGAL DESCRIPTION:
APN:

TYPE OF CONSTRUCTION: V-B
OCCUPANCY: R-3, U
STORIES: 2

HEIGHT LIMIT: 24' (15' AT REAR SETBACK)
GRADING: CUT (T.B.D.)
TREE REMOVAL: NONE

APPLICABLE CODES: 2016 CBC, 2016 CRC, 2016 CFC, 2016 CPC, 2016 CEC, 2016 CMC, 2016 CALIFORNIA ENERGY CODE, 2016 CALIFORNIA GREEN BUILDING CODE

4,000 S.F.

1,800 S.F.

FLOOR AREA PROPOSED:

SITE COVERAGE ALLOWED:

SITE COVERAGE PROPOSED:

396 S.F.
ADDITIONAL 4% OF LOT SIZE (160 SF) FOR DRIVEWAY
TOTAL ALLOWED - 556 S.F.

UPPER FLOOR - 312 S.F.

1,800 S.F. MAIN FLOOR - 1,245 S.F.

	AREA
ROOF DECK (IMPERVIOUS)	43 S.F.
LANDING @ BDRM 1 (IMPERVIOUS)	3 S.F.
MAIN TERRACE (PERMEABLE)	228 S.F.
COVERED PORCH (IMPERVIOUS)	44 S.F.
FRONT PATHWAY (PERMEABLE)	92 S.F.
DRIVEWAY 9'-0" (PERMEABLE)	146 S.F.
UTILITY AREA (MULCH) NOT COUNTED	36 S.F.


PERMEABLE IMPERVIOUS

TOTAL COVERAGE

466 S.F. (84%) 90 S.F. (16%)

556 S.F.

VICINITY MAP

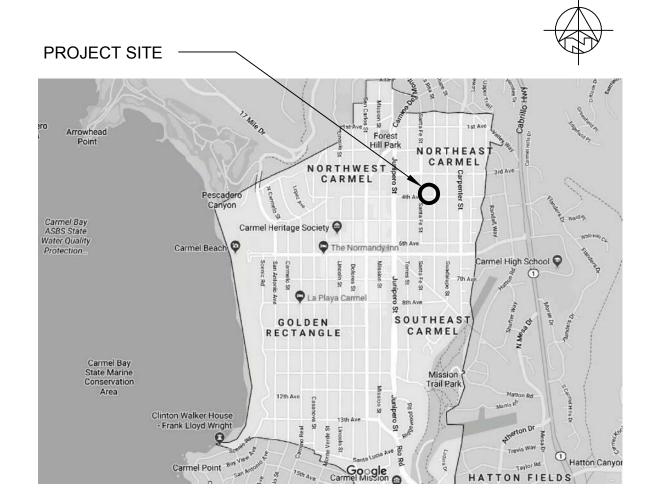

AO ARCHITECTURAL

P.O.BOX 2272 MONTEREY, CA 93942 (831) 682-1331

P.O.BOX 2272 DNTEREY, CA 93942 (831) 682-1331

ARMEL, CA,

ESIDENCE V OF 5TH

APN: 010-038-00

SW OF 5TH

REVISIONS:					
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<u>/2\</u>					
3					
4					


COVER SHEET
PROJECT INFO


DATE: 05-10-2019

FINAL DESIGN
APPROVAL

SHEET NO.

A0.0

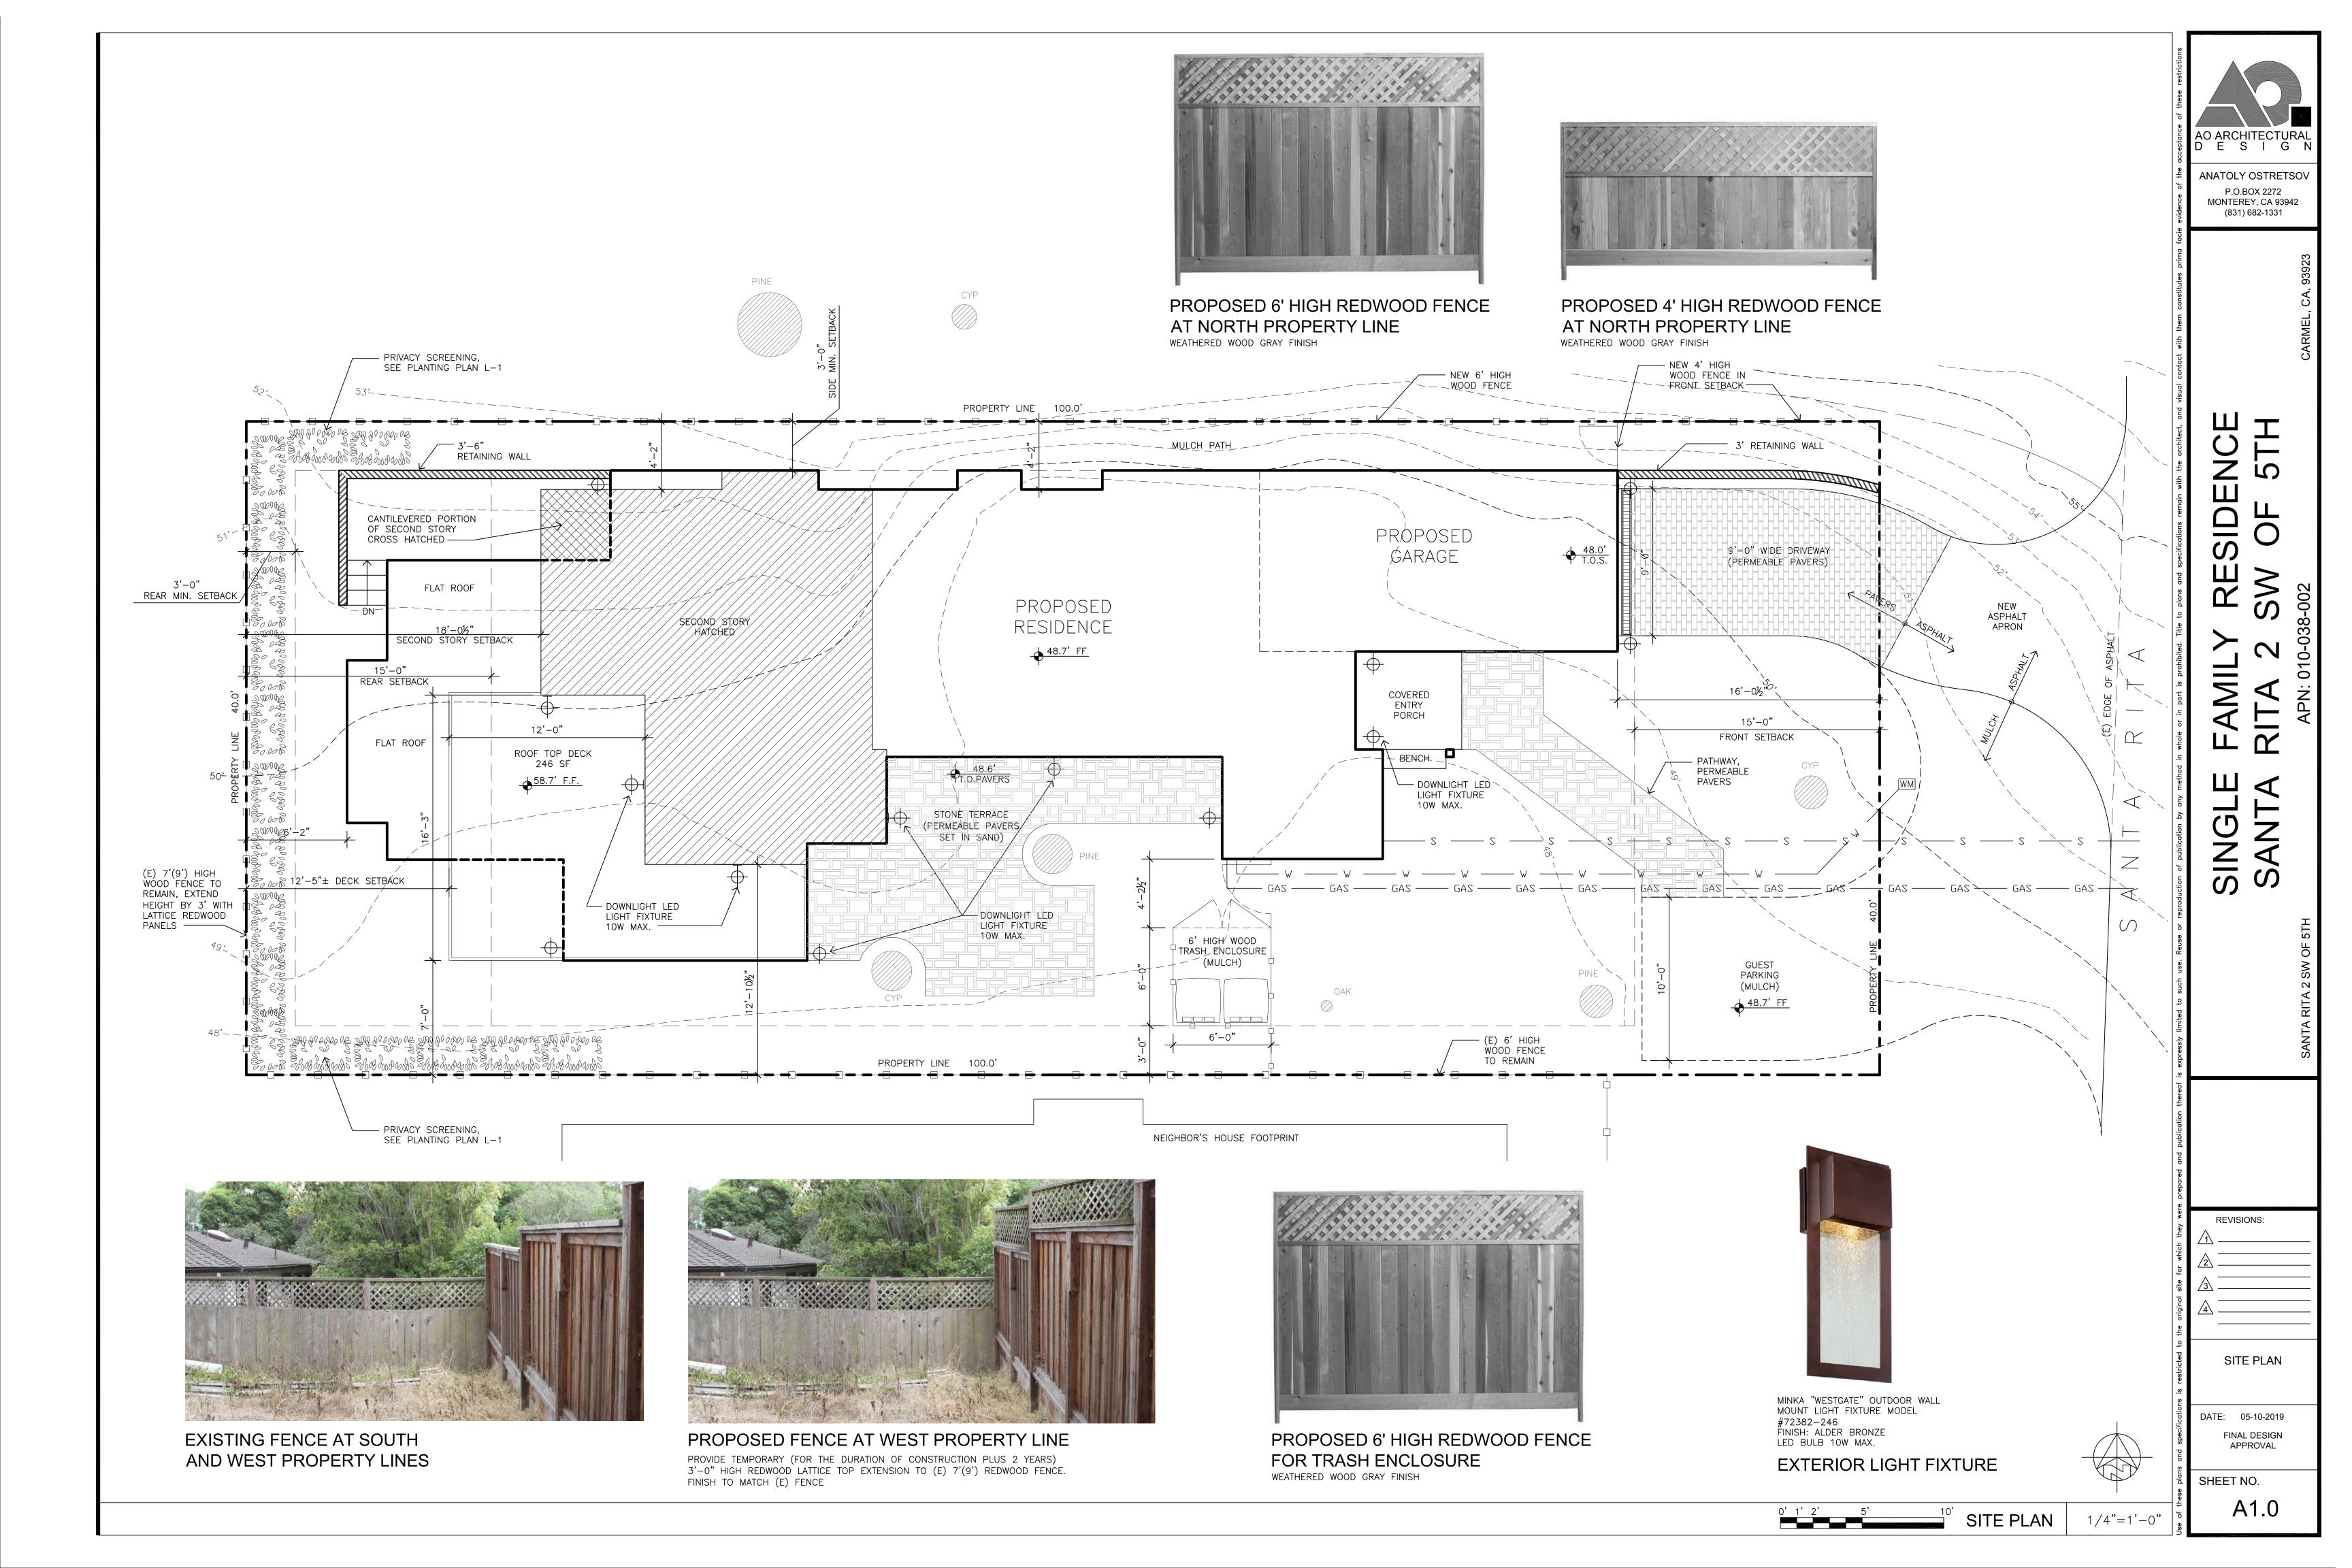

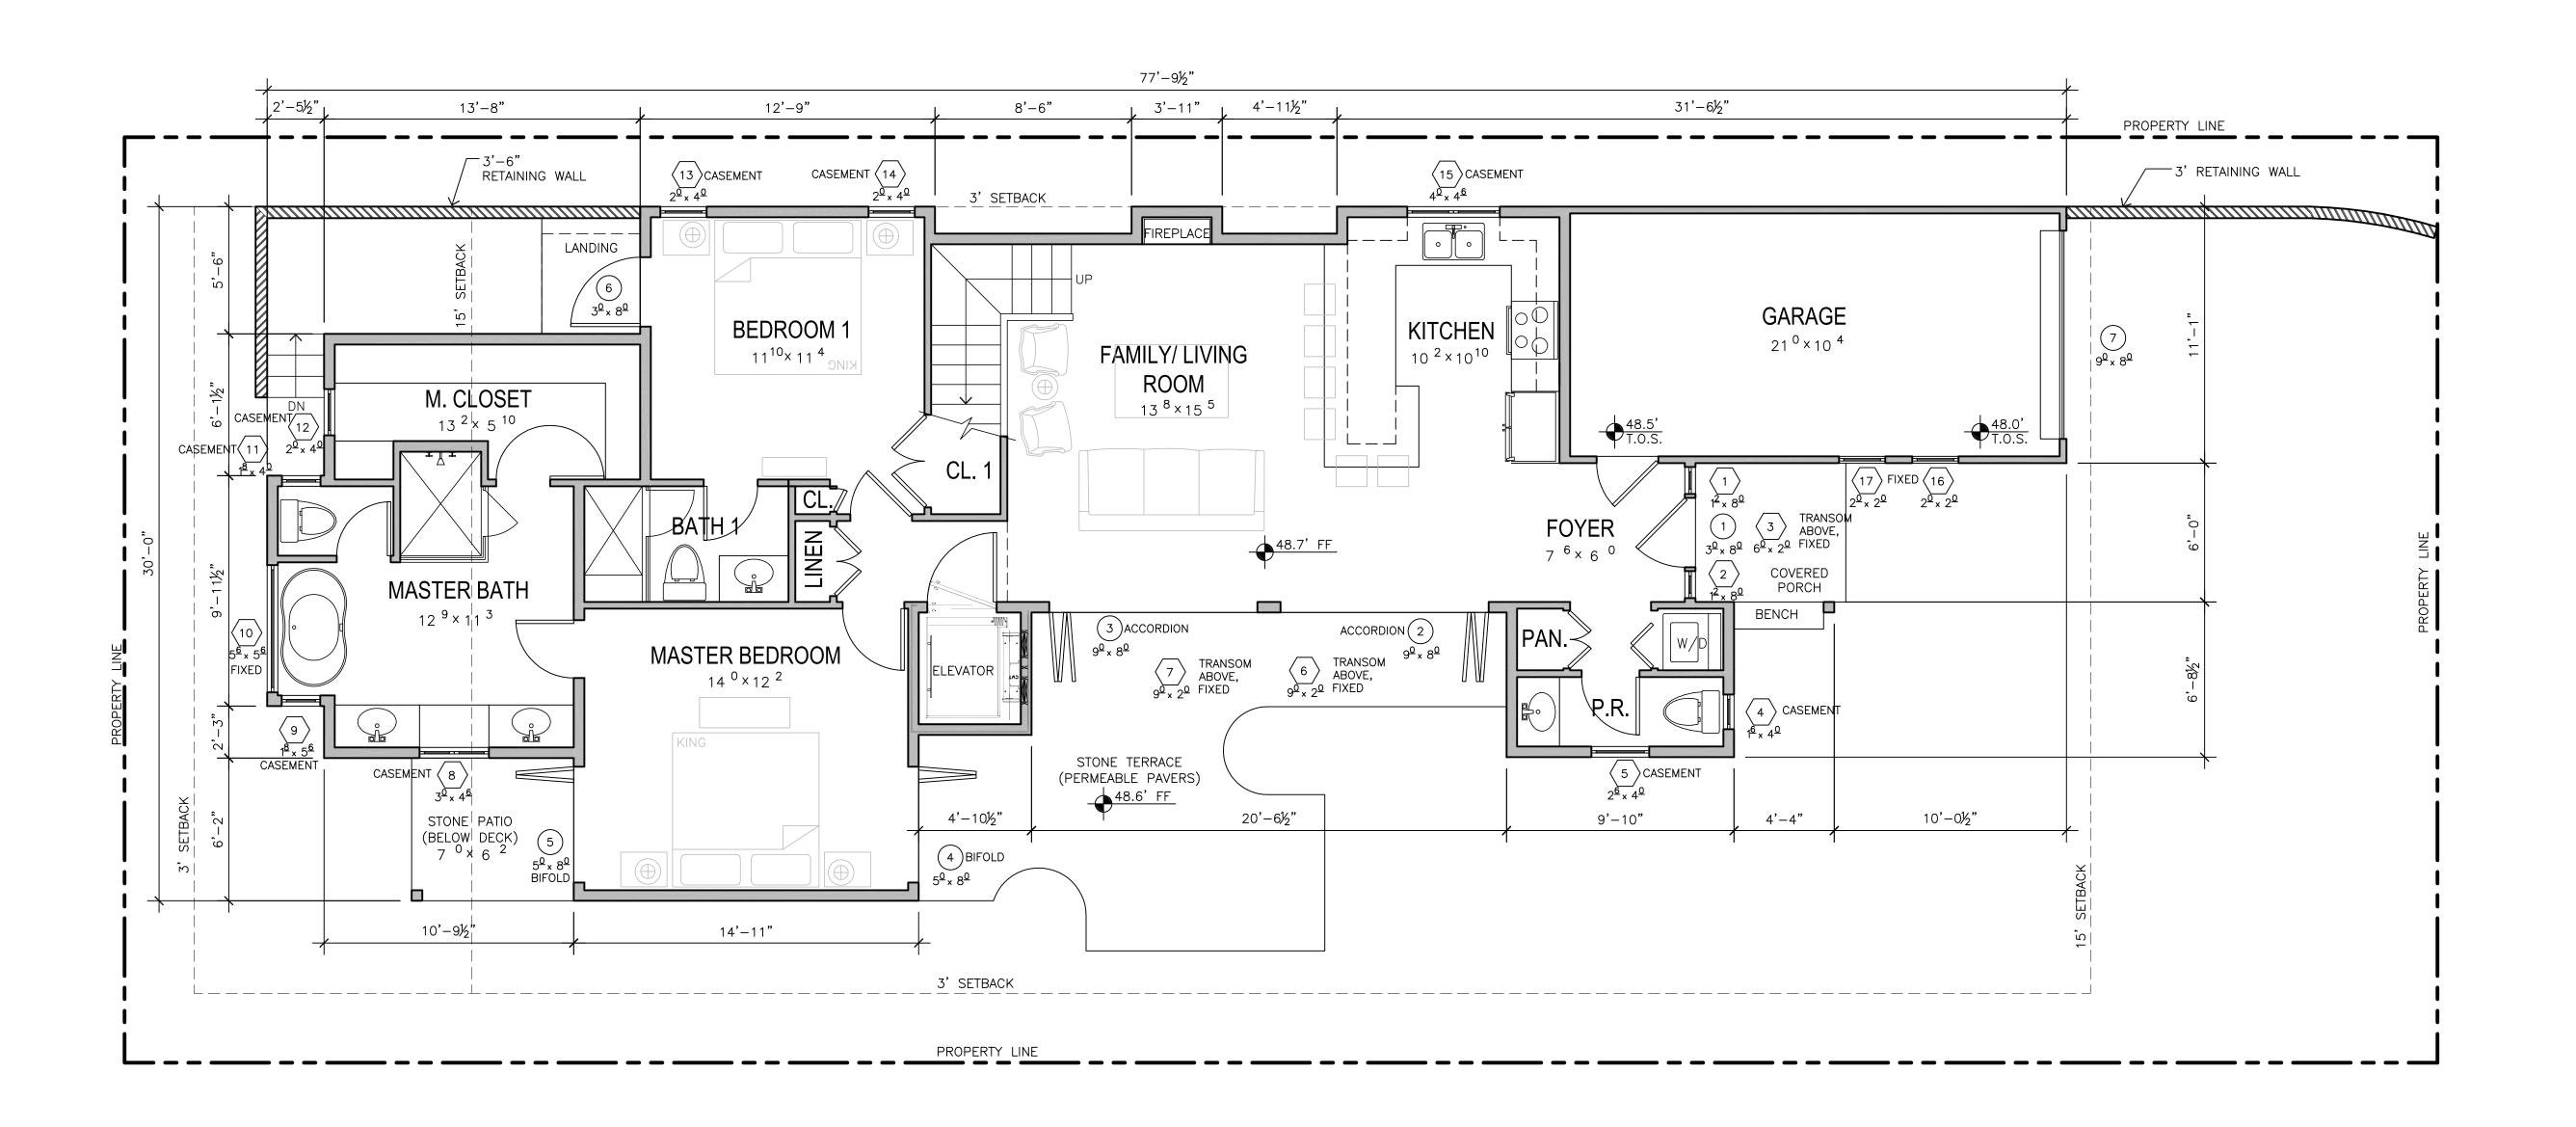

AO ARCHITECTURAL D E S I G N

ANATOLY OSTRETSOV

P.O.BOX 2272 MONTEREY, CA 93942 (831) 682-1331

5TH

MAIN LEVEL FLOOR PLAN

DATE: 05-10-2019 FINAL DESIGN APPROVAL

A2.0

SHEET NO.

MAIN LEVEL FLOOR PLAN


DOOR / WINDOW LEGEND

DENOTES A WINDOW

DENOTES A DOOR

 $(XX)^{X}$

1/4"=1'-0"

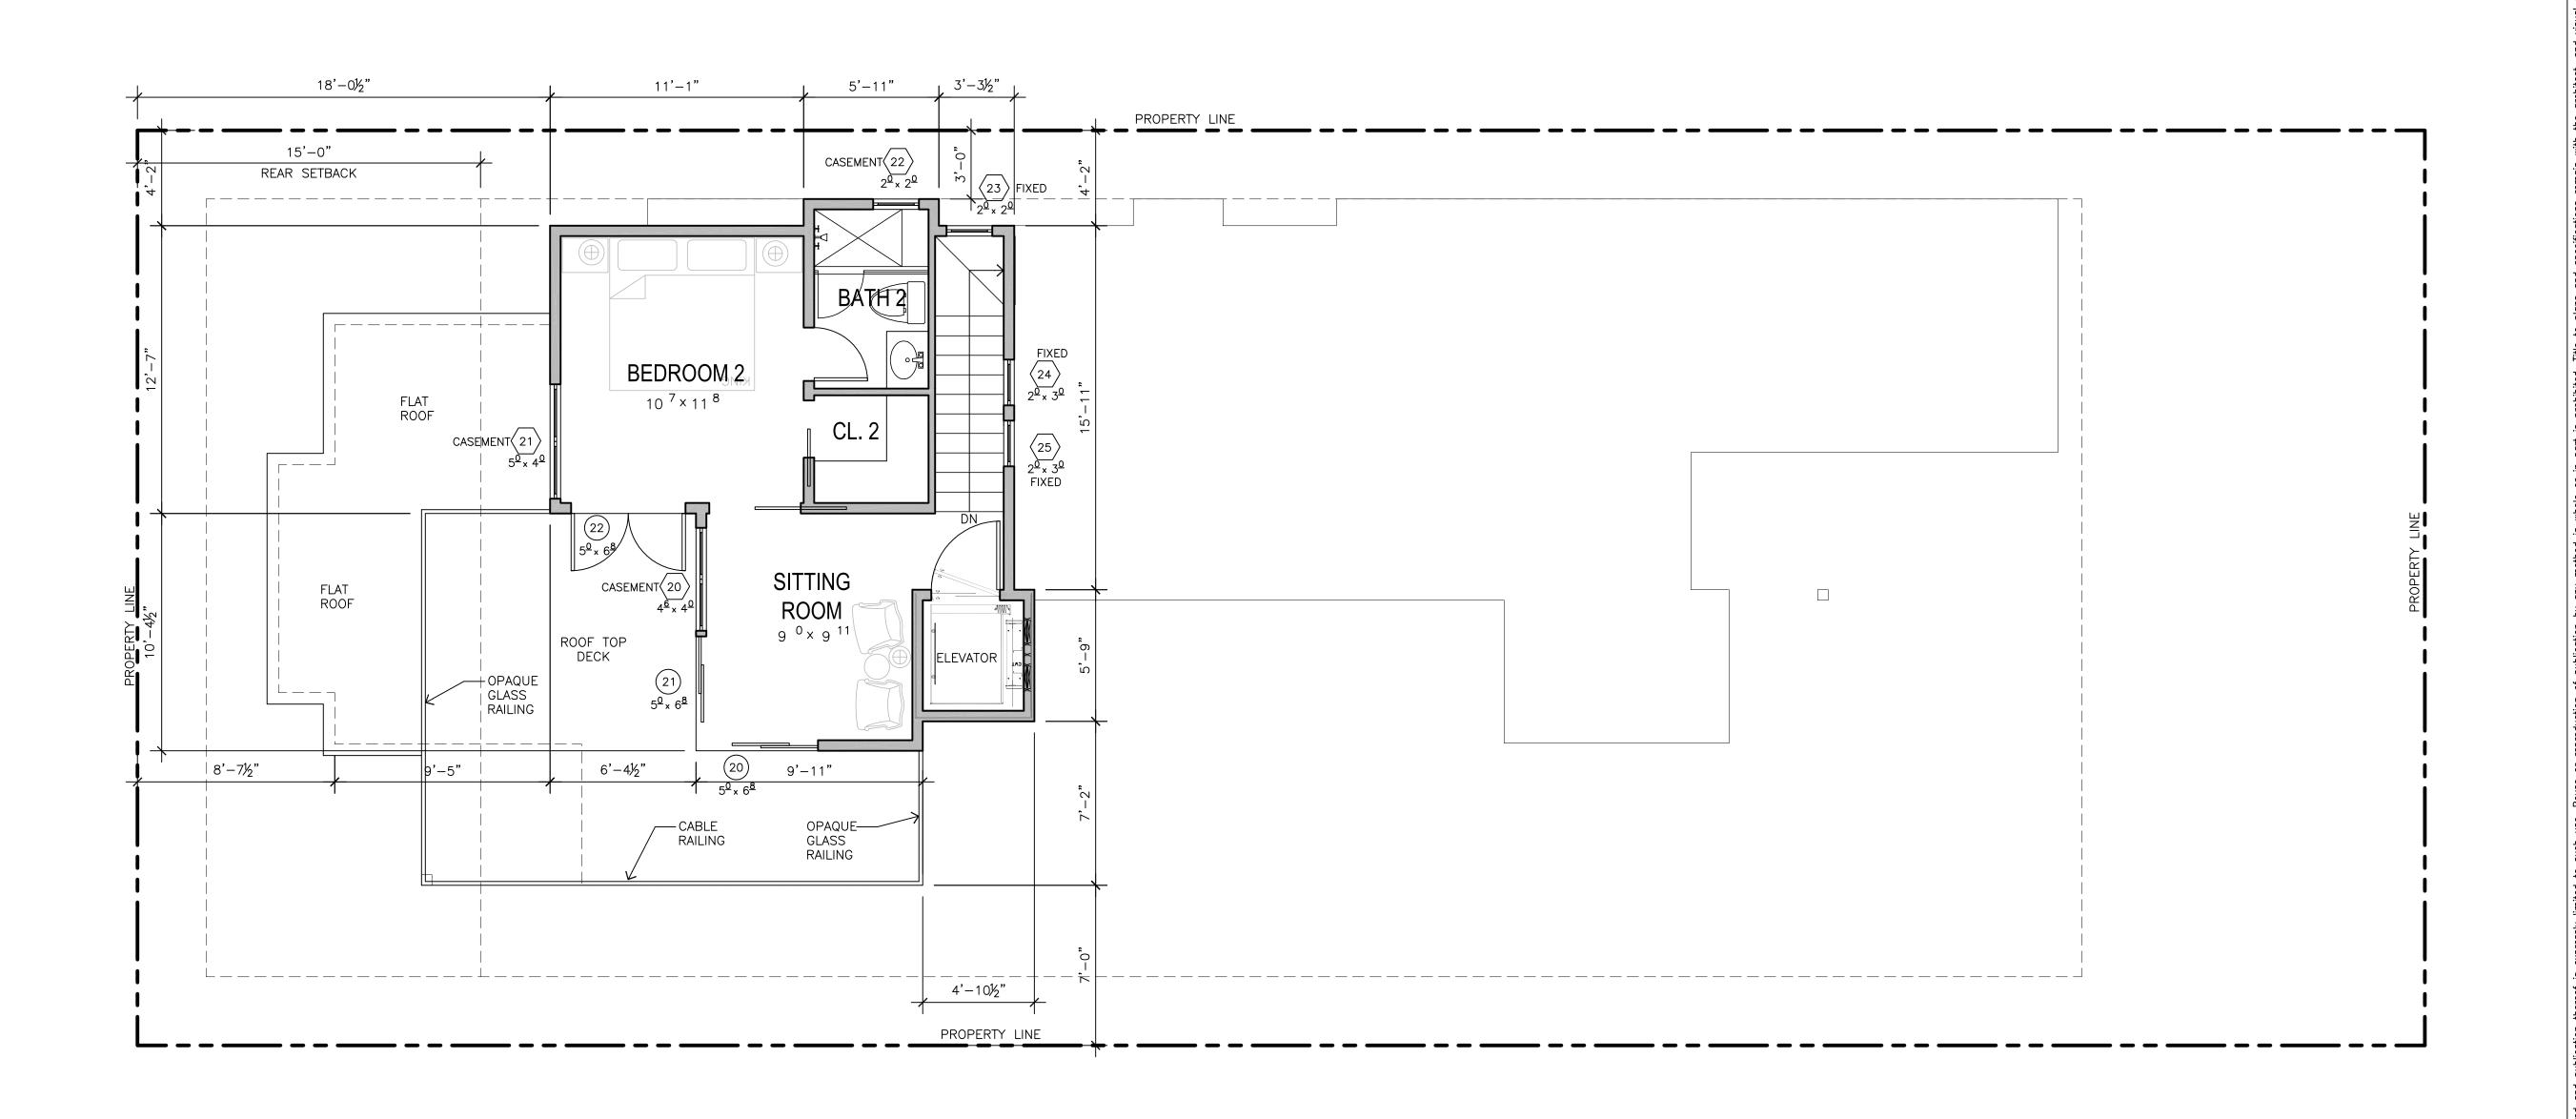

ANATOLY OSTRETSOV

P.O.BOX 2272 MONTEREY, CA 93942 (831) 682-1331

UPPER LEVEL FLOOR PLAN

DATE: 05-10-2019 FINAL DESIGN APPROVAL

A2.1

SHEET NO.


UPPER LEVEL FLOOR PLAN


DOOR / WINDOW LEGEND

DENOTES A DOOR

(XX)

1/4"=1'-0"

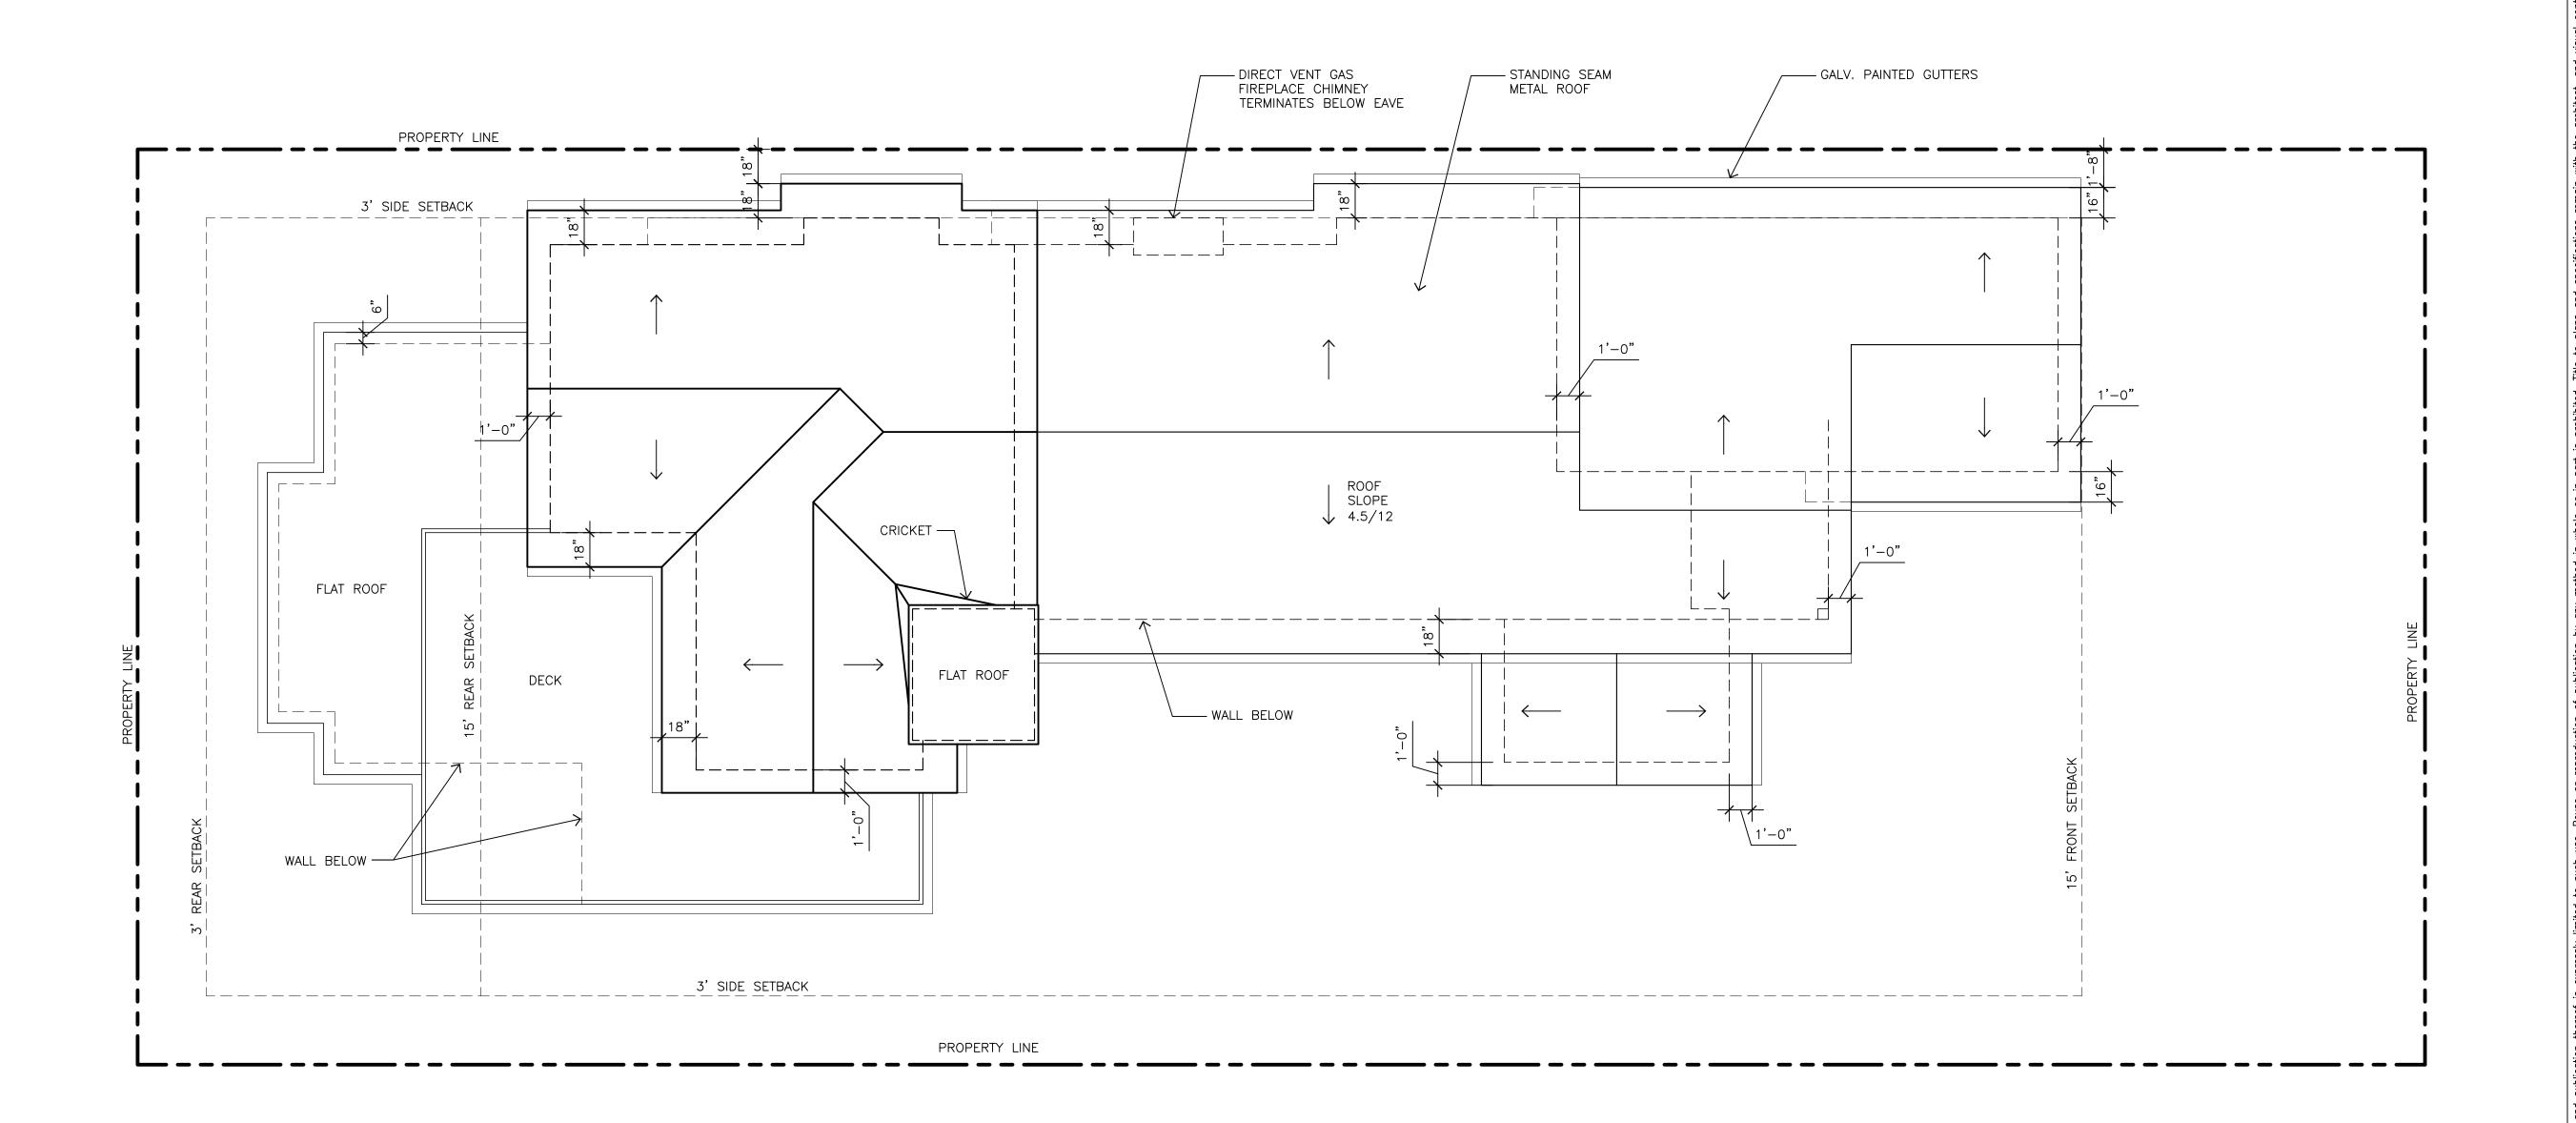

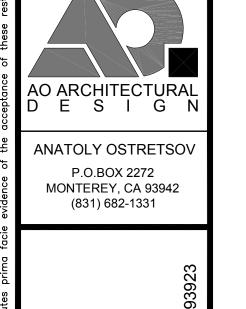


ROOF PLAN


DATE: 05-10-2019 FINAL DESIGN APPROVAL


A5.0

1/4"=1'-0"

ROOF PLAN

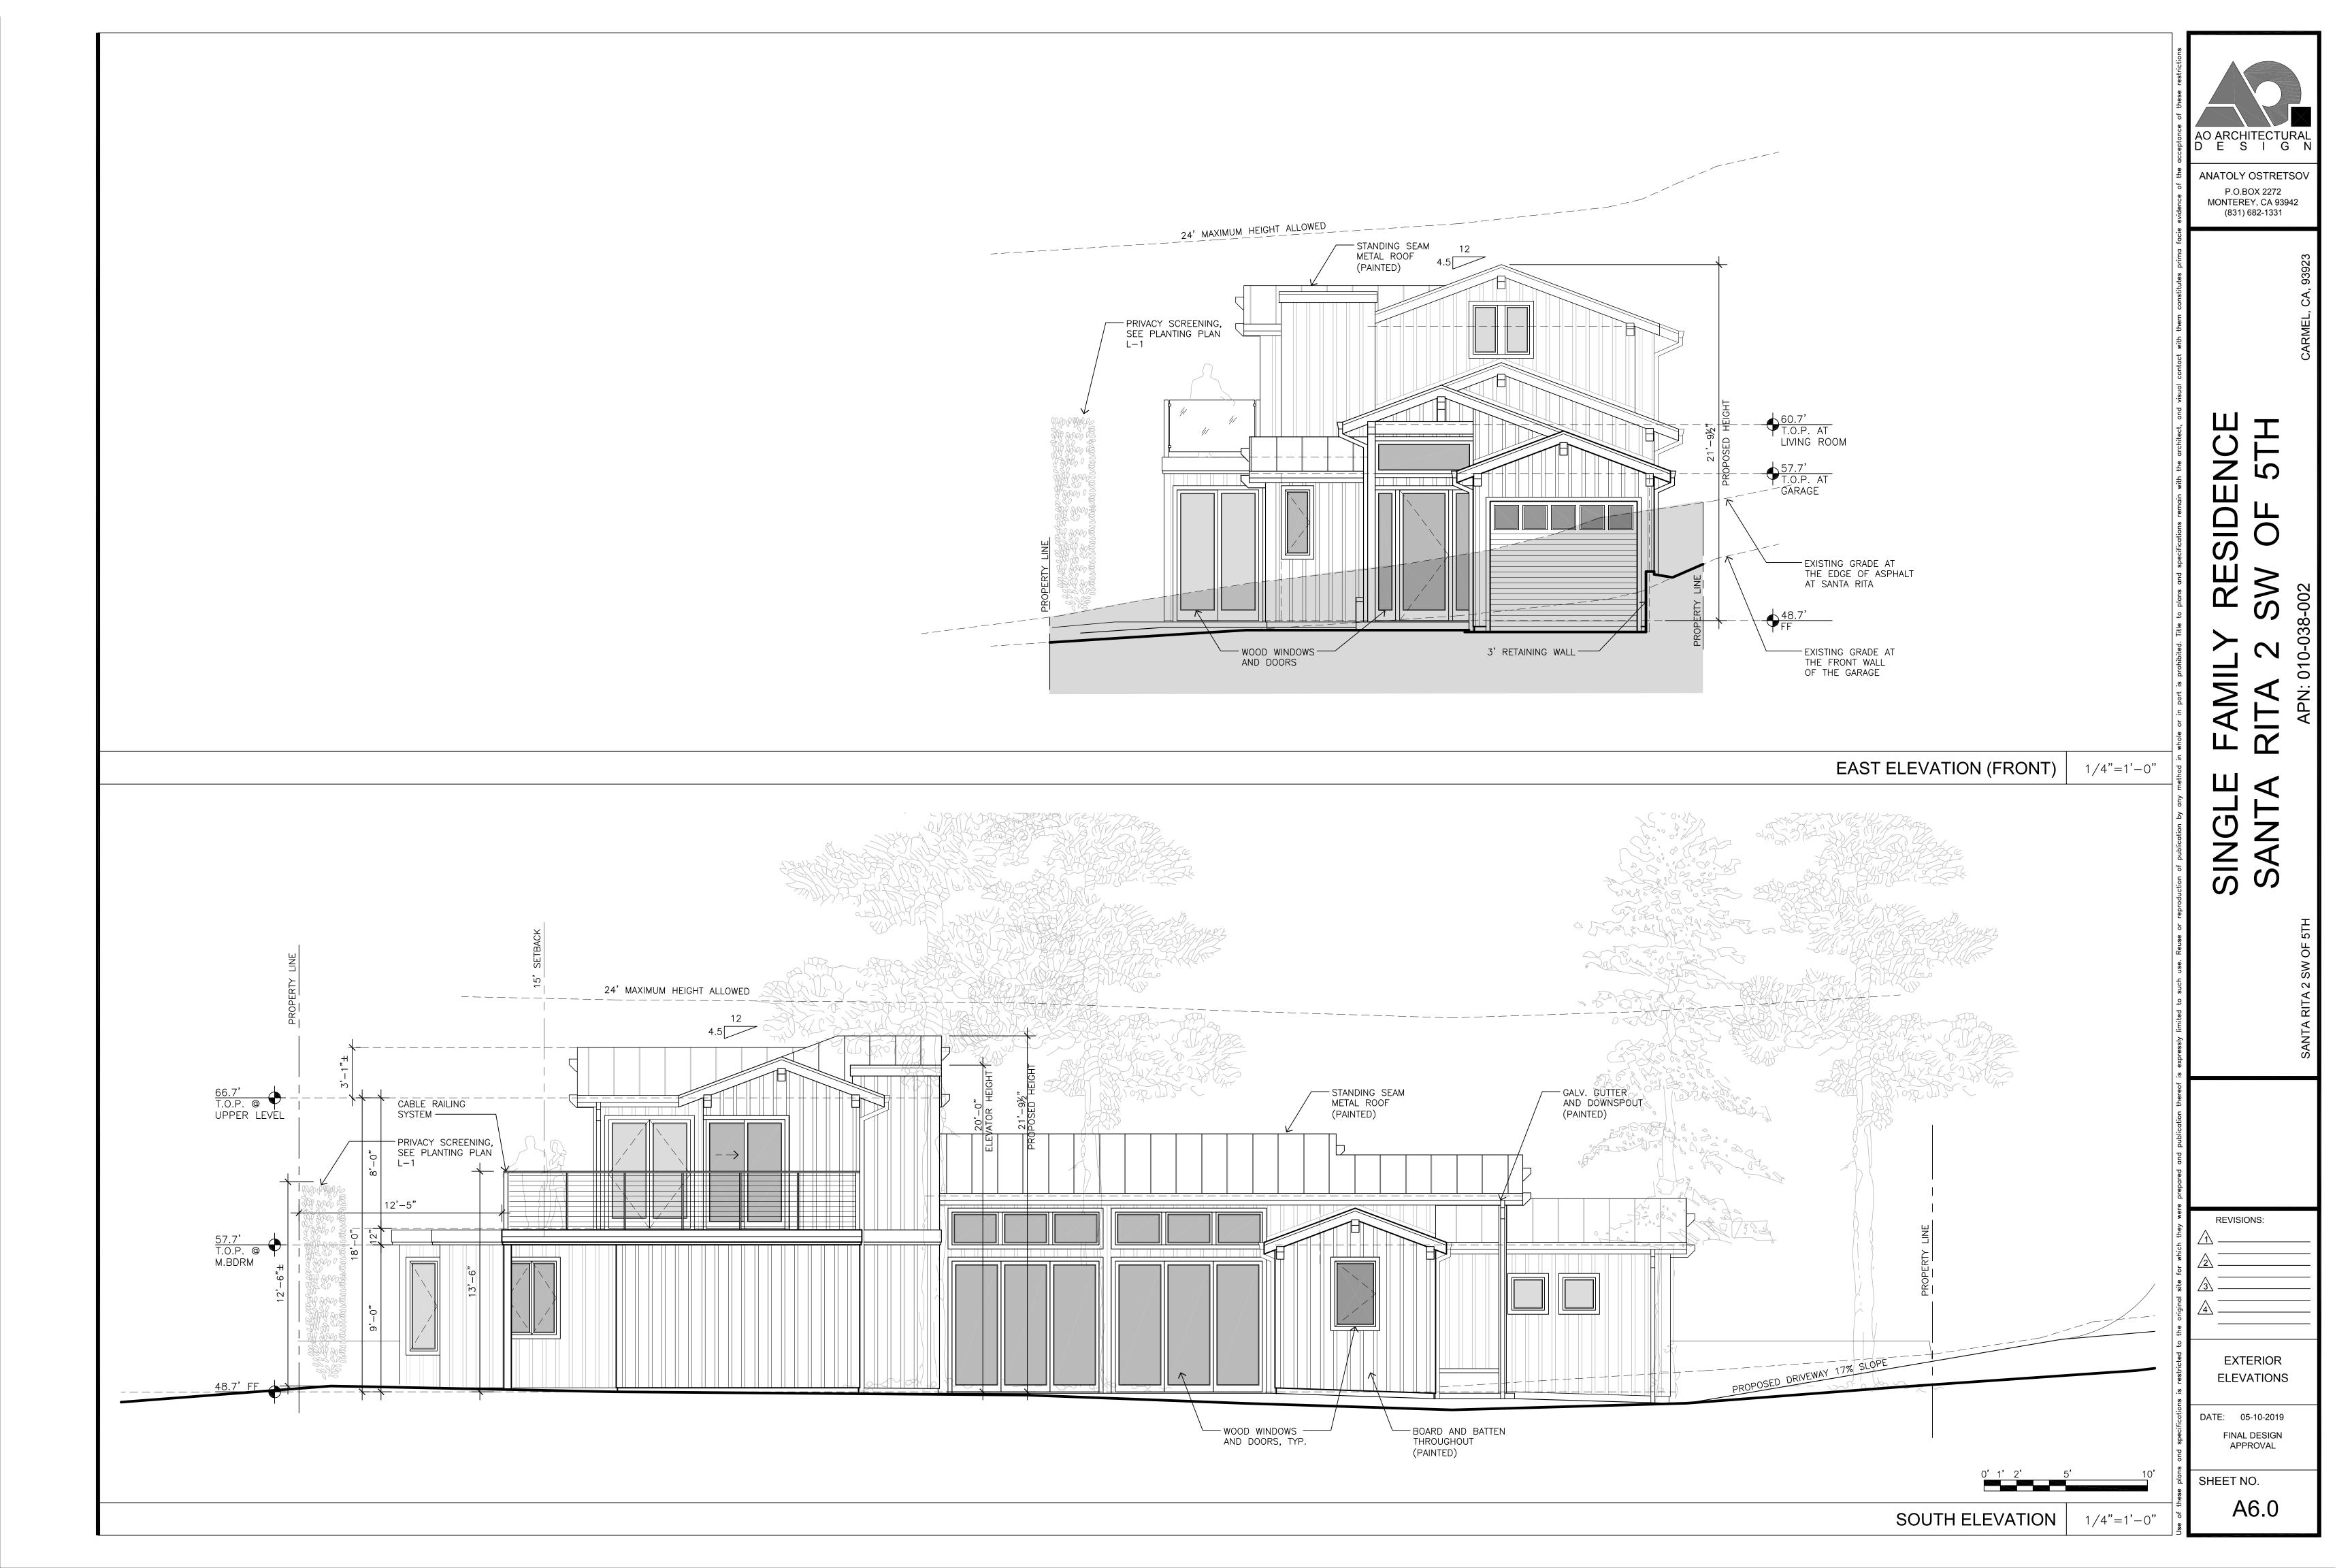

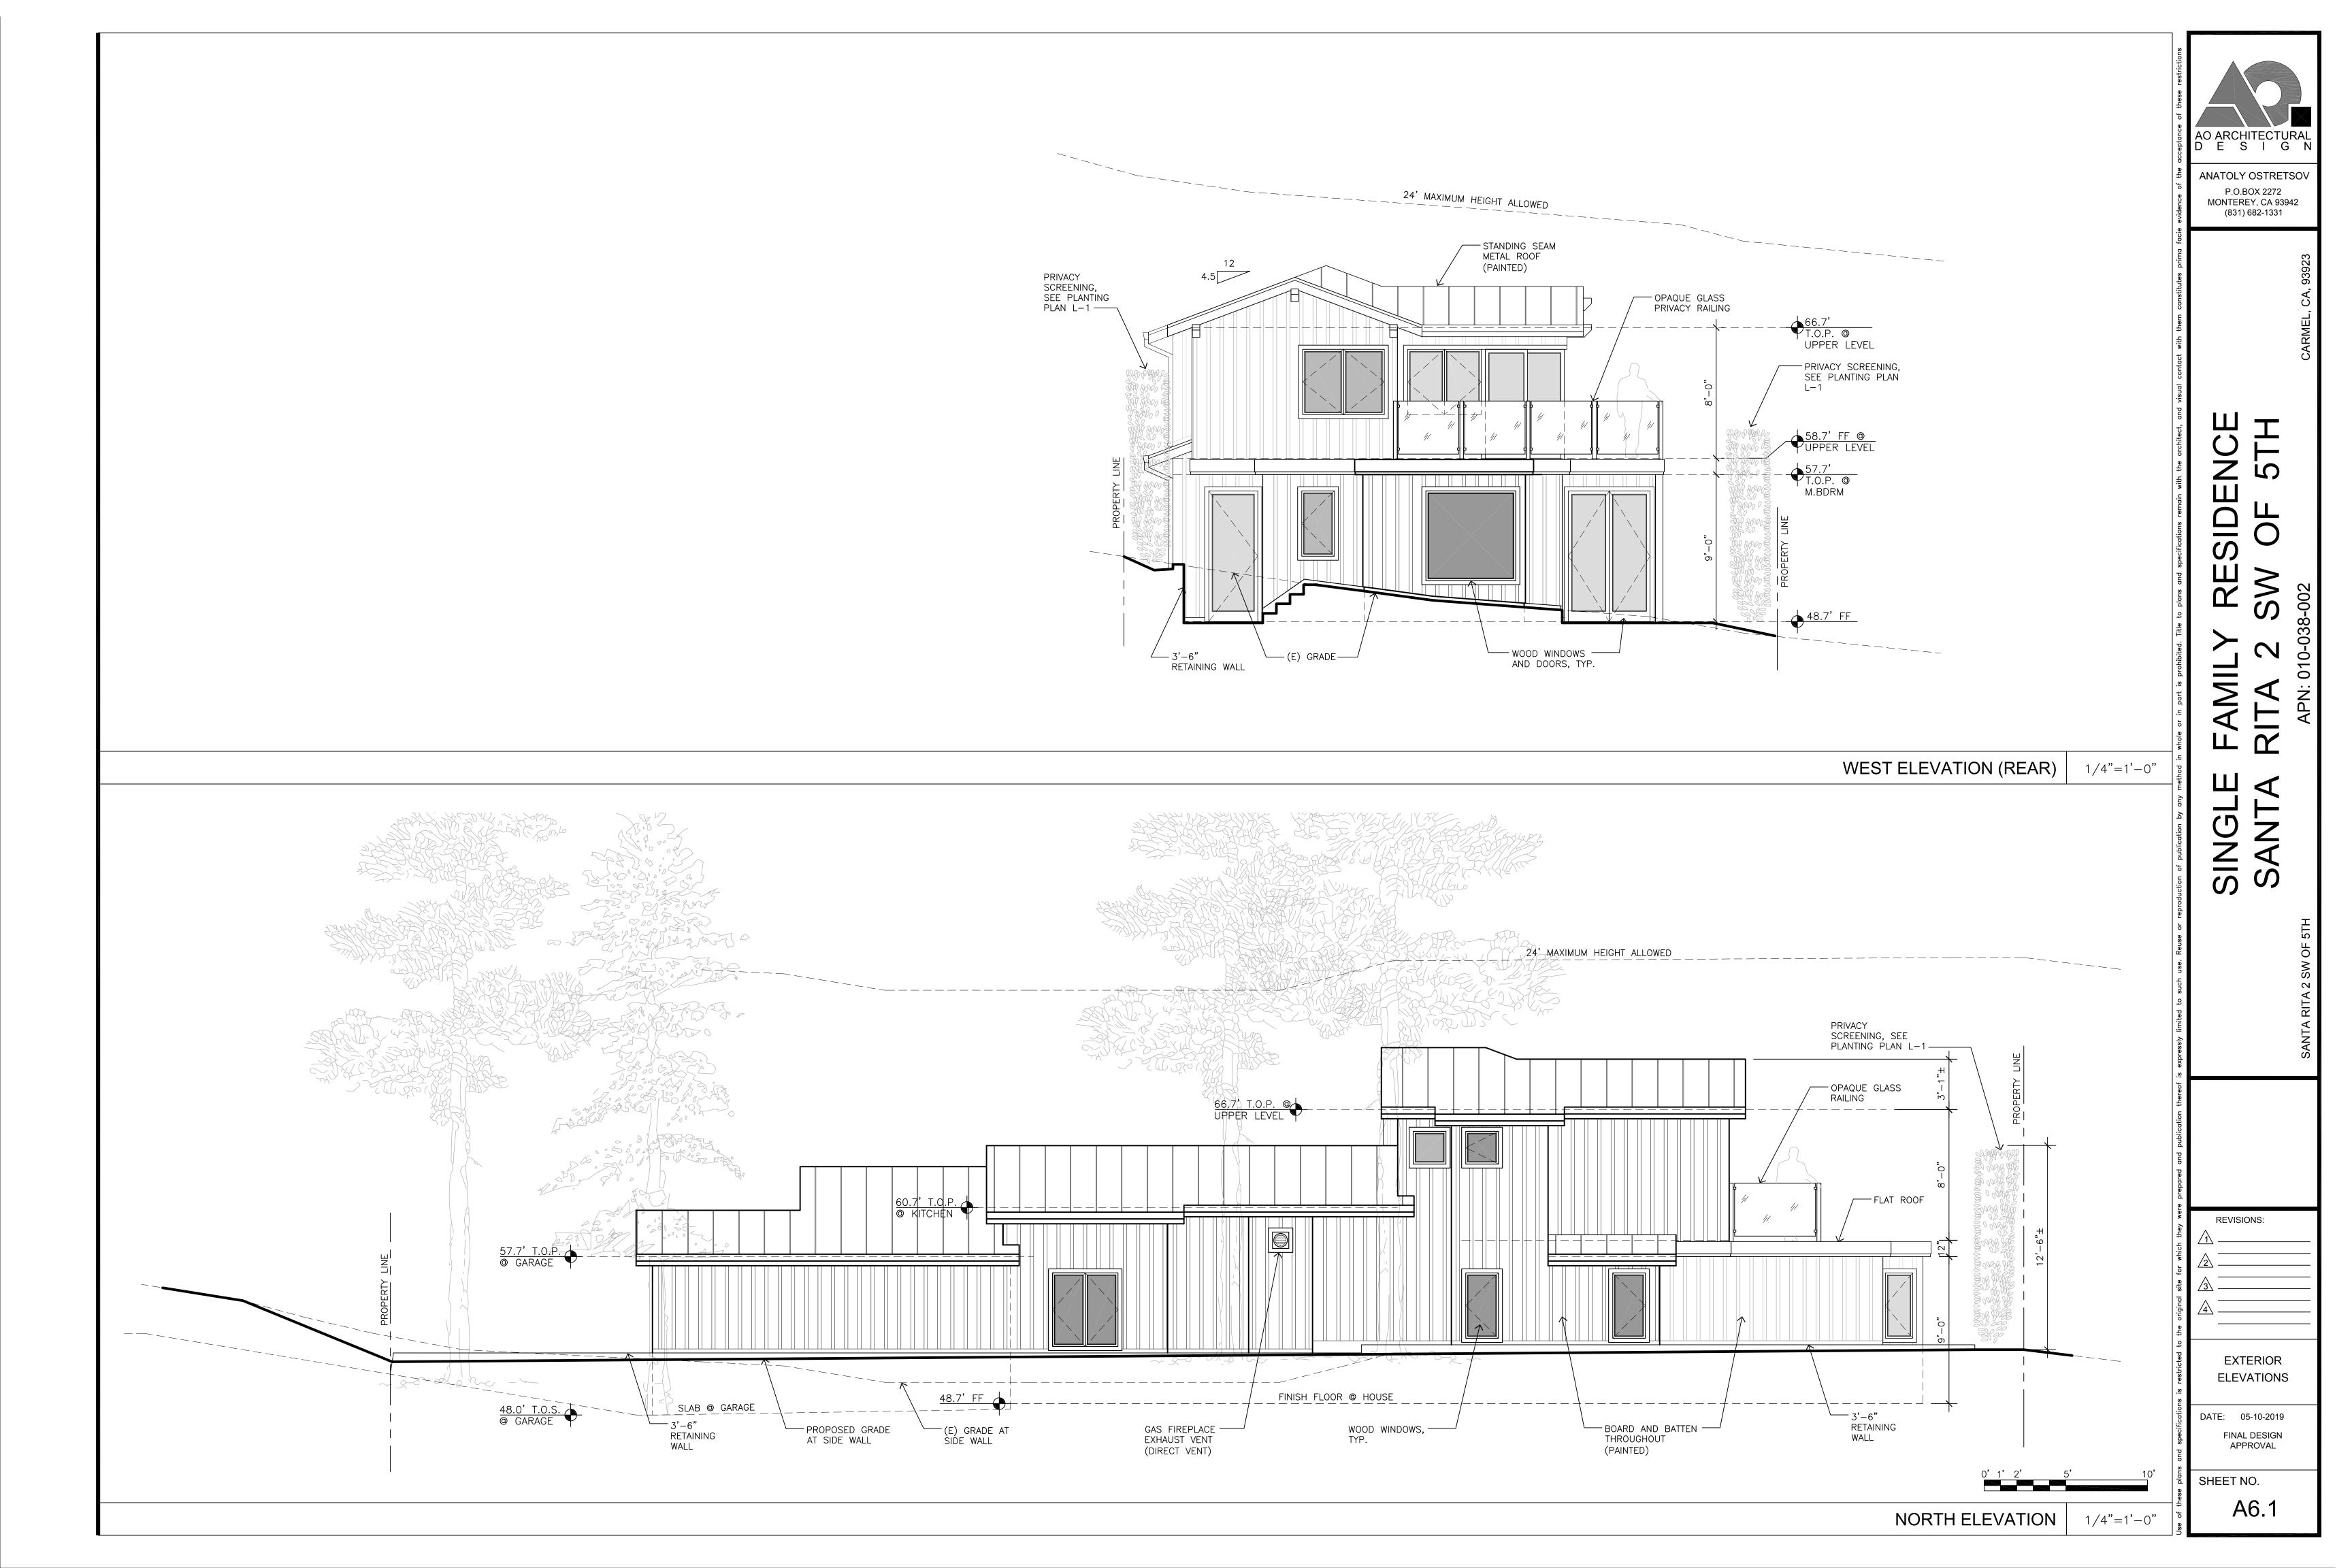

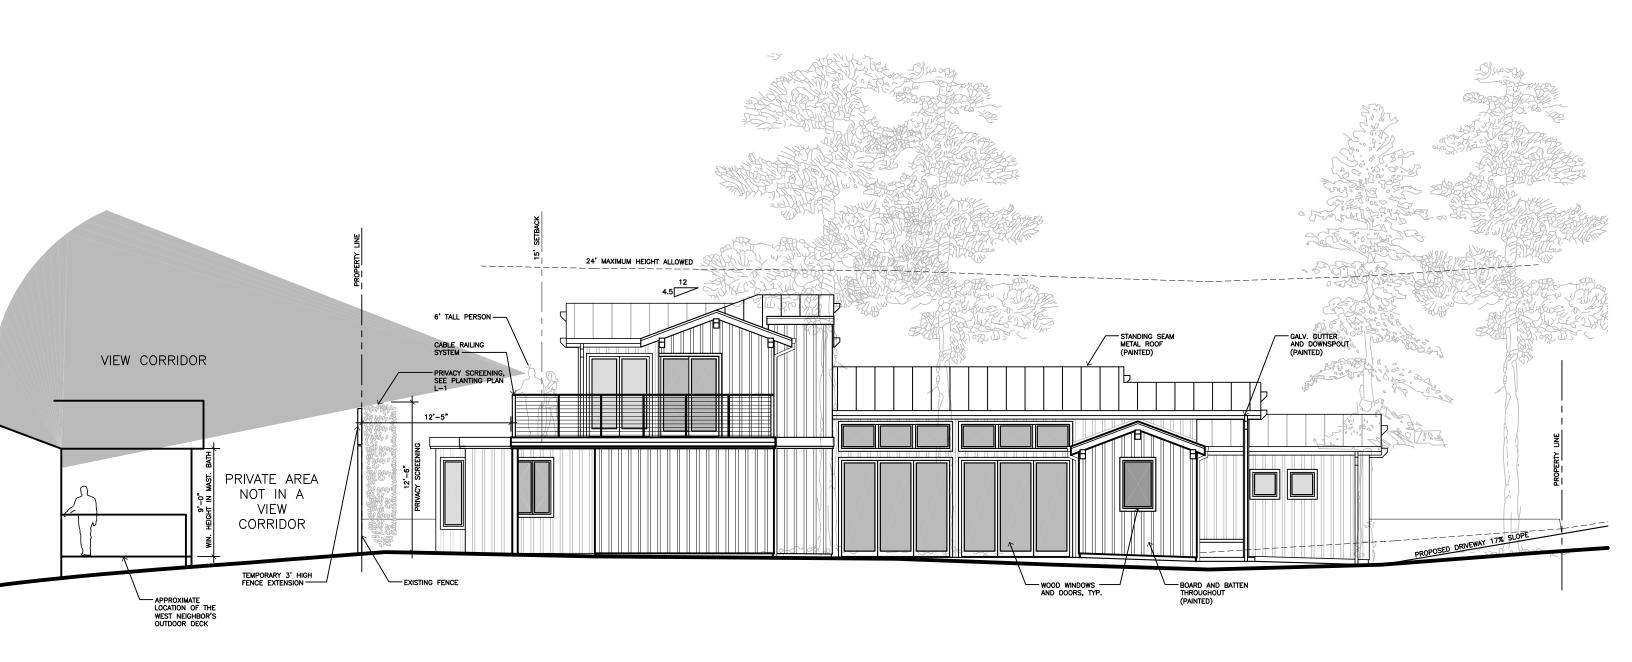

SANTA RITA 2 SW OF 5TH PRIVACY/ VIEW IMPACT STUDY TOWARD WEST

RECEIVED

GENERAL IRRIGATION NOTES:

1. Irrigation to be run off separate mainline extension

with isolation shut off valve 2. All drip lines to have an in-line filter

3. Pressure for regulator for drip irrigation to be regulated to 25 - 35 PSI

4. All valves to be sub-grade within a weatherproof valve box,

IRRIGATION LEGEND

→ Point of connection from mainline

Gate shut off valve

Backflow Prevention Assembly

- 3/4" pvc Schedule 40 to valves Control Valve to Drip - Hunter PGV 1"globe Valve with 30 PSI pressure regulator and filter

--- Drip Zone Riser from PVC to 1/2" Tubing

Lateral tubing to Emitters - 1/2* Polyetheline

C . Controller - Hunter ProC

Rain Sensor - Hunter Rain Clik

MAWA Calculations prepared for the
Jie Mei Project, Santa Rita 2 S/W of Carmel, CA (APN: 010-038-002)

able landscape irrigation usage for this site is 0.038 acre feet.

Formula & Calculations:

 $MAWA = ETo \times ETadj \times LA \times 0.623$ 325,851

= Reference ET = 33"/ yr (Zone 1) ETadj = ET Adjustment Factor = KL/IE = 0.5 /.85 = .59 = Landscape Coefficient = 0.5 (Mediterranean Climate / Drought Tolerant Plant Material = Drija Irrigation Efficiency = 0.85 = Landscaped Area = 922 sq. ft.

LA Calculation based on: 57 1 gal. plant @ 4 SF = 228 SF 34 5 gal. plant @ 9 SF = 306 SF 8 15 gal. plant @ 16 SF = 128 SF 13 24*80x Tree @ 20 SF = 260 SF Total SF = 922 SF

Estimate Total Water Use (ETWU) for this site = $\frac{33 \times .59 \times 881 \times 0.623}{325,851}$ = .035 acre feet 325,851

Plant List

code	Qty	Size	Botanical Name	Common Name
A	3	5 gal	Acacia 'Cousin Itt'	Dwarf River Wattle
В	7	1 gai	Agapanthus albiflorus	White African Lily
С	5	5 gal	Arctostaphylos 'Carmel Sur'	Manzanita Ground Cover
D	10	1 gai	Bergenia "Bressingham White'	White Bergenia
E	7	1 gal	Calamagrostis foliosa	Pacific Reed Grass
F	5	5 gal	Ceanothus "Anchor Bay'	Ceanothus
G	3	5 gal	Choysia ternata	Mock Orange
H	5	5 gal	Correa 'Ivory Bells'	Australian Fuchsia
1	5	5 gal	Grevillea 'Coastal Gem'	Grevillea
l	3	5 gal	Hardenbergia 'Alba'	White Lilac Vine
K	5	1 gai	Liriope muscari variagata	Varigated Lily Turf
L	5	5 gal	Pittosporum 'Marie Channon'	Varigated Pittosporum
M	13	24' box x 9'	Prunus laurocerasus	English Laurel
N	8	15 gal	Rhamnus alaternus	Italian Buckthorn
O	4	1 gal	Rosmarinus 'Irene'	Trailing Rosemary

Planting Plan scale: 1/8" = 1'0"

MI THE TOTAL

(N) HEDGE 9'-11' TALL

PAVERS

MULCH

MULCH

Irrigation Plan scale: 1/8" = 1'0"


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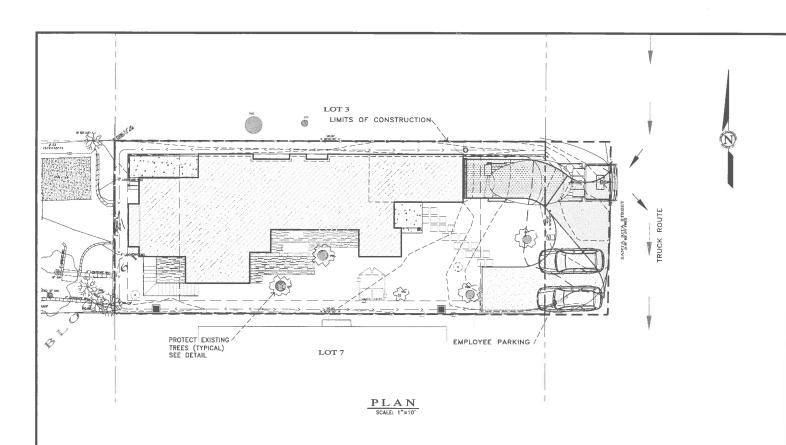
SHEET L1

Robert Shuler Design
PO Box 2152 RStowes3@att.net
Carmel, CA 93921 831 624-4079

Planting and Irrigation Plan Jie Mei Property Santa Rita 2 S/W of 5th Avenue Carmel, CA 93921 APN 010-038-002

SCALE: 18 = 10"



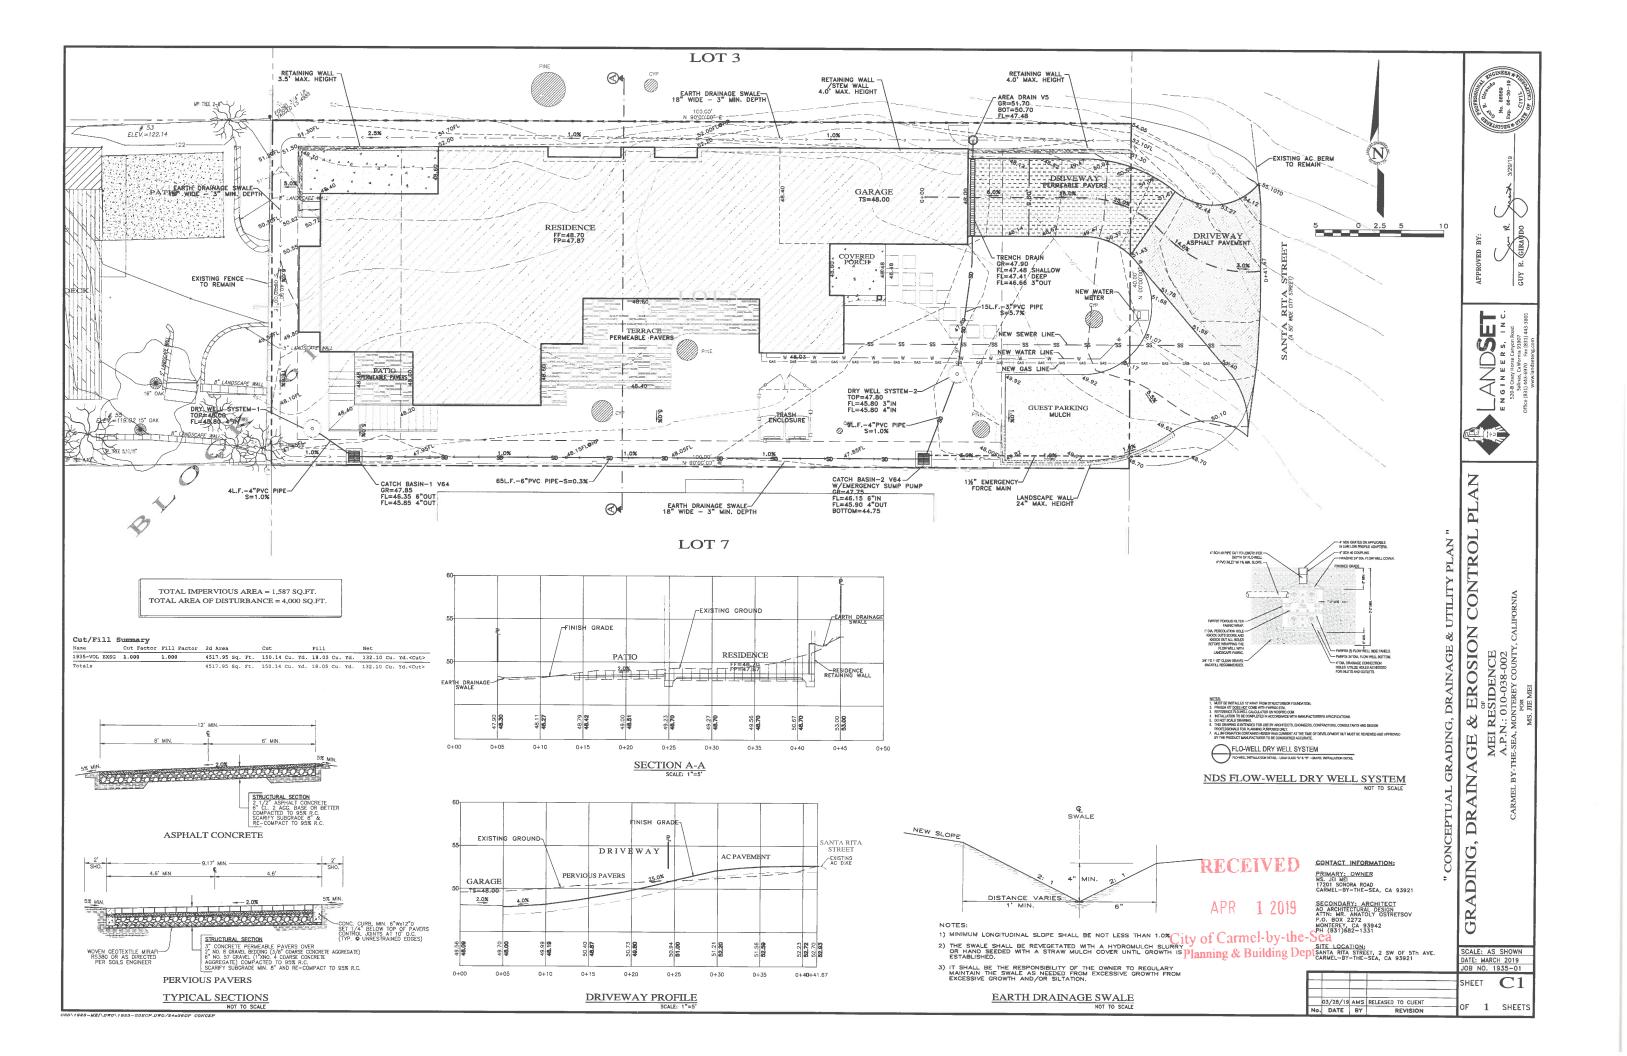

PLACE FENCING AT TREE DRIPLINE

FENCING (ESA) DETAIL

EARTHWORK QUANTITIES PER CIVIL ENGINEERING PLANS BY LANDSET ENGINEERS, INC.: 160 CY CUT $20\ \mathrm{CY}$ FILL

A. MOBILIZE, CLEAR & GRAB.

B. SITE GRADING.

C. UTILITY INSTALLATION.

D. CONSTRUCT STRUCTURE

E. INSTALL PAVERS AND LANDSCAPING.

F. SITE CLEANING, PUNCH LIST. SEE ARCHITECTURAL AND CIVIL PLANS FOR EROSION CONTROL.

CONSTRUCTION EQUIPMENT AND MATERIALS SHALL NOT BE STAGED ON SANTA RITA STREET AT ANY TIME DURING CONSTRUCTION. MATERIAL DELIVERIES SHALL BE SCHEDULED SUCH THAT THEY ARE USED PROMPTLY AND MATERIAL STORAGE IS MINIMIZED. ALL CONSTRUCTION EQUIPMENT AND MATERIALS SHALL BE STORED IN A DESIGNATED AREA ON THE SUBJECT PROPERTY.

HAUL ROUTES:
THE HAUL ROUTE TO THE SITE IS FROM RIO ROAD TO JUNIPERO AVENUE TO 5Th. AVENUE TO SANTA RITA
STREET, HAUL TRUCKS EXIT TO SANTA RITA STREET TO OCEAN AVENUE TO JUNIPERO AVENUE TO RIO ROAD.
VEHICLES SHALL NOT BE LEFT UNATTENDED WHILE IN QUEUE (IF NECESSARY) ON RIO ROAD. CONTRACTOR
TO ENSURE THAT HEIGHT RESTRICTIONS WITHIN THE DRIVEWAY AREA SHALL BE ADDRESSED BEFORE
CONSTRUCTION VEHICLES ENTER THE SITE. SEE DETAILS B AND C, TRUCK ROUTING PLANS.

MATERIAL DELIVERIES:
IN THE EVENT THAT MATERIAL DELIVERIES CAUSE SANTA BITA STREET TO BE PARTIALLY BLOCKED BY DELIVERY TRUCKS OR LOADINGUINLOADING OPERATIONS, A FLAGMAN SHALL BE PRESENT TO DIRECT TRAFFIC AROUND THE LANE OBSTRUCTION. THE FLAGMAN SHALL BE PRESENT AT ALL TIMES DURING WHICH DELIVERY CONSTRUCTION OPERATIONS MAY (IMPACT TRAFFIC ON SANTA BITA STREET AND SURROUNDING

EMPLOYEE PARKING.

LIMITED EMPLOYEE PARKING ON-SITE. EMPLOYEES SHALL USE PUBLIC PARKING LOTS AND CARPOOL TO
JOSSITE. ON-SITE PARKING SHALL BE IN LEGAL SPACES ALONG SANTA RITA STREET, OBEYING ALL PARKING
LAWS. PARKING IS PROHIBITED IN ALL NATURAL AREAS WHICH ARE NOT CURRENTLY PAVED OR GRAVEL.

LIMITS OF CONSTRUCTION: ALL CONSTRUCTION SHALL TAKE PLACE WITHIN THE BORDER AS SHOWN, EXISTING CYPRESS AND PINE TREES LOCATED WITHIN THE LIMITS SHOWN SHALL BE SURROUNDED BY ORANGE PROTECTIVE FENCING (SEE DETAIL).

NUMBER OF TRUCK TRIPS/DAY: 5

AMOUNT OF GRADING/DAY: 50 C.Y.

NUMBER OF EMPLOYEES/DAY: 4-8

HOURS OF OPERATION/DAY: 8

PROJECT SCHEDULING: PROJECTED START DATE 6 MAY 2018, 6 WORKING DAYS TO COMPLETE GRADING, MONDAY THRU FRIDAY, 8:00 A.M. - 4:30 P.M. TOTAL PROJECT DURATION IS APPROXIMATELY 12 MONTHS.


TRUCK TRIP GENERATION CHART:

CATEGORY	NO. OF TRUCK TRIPS	TOTAL DAYS	
DEMOLITION	0	0	
GRADING & SOIL REMOVAL (EXPORT)	16	4	
ENGINEERING MATERIALS (IMPORT)	4	4	
TOTALS	20	8	


TRUCK TRIP GENERATION NOTES:

TRUCK TRIPS FOR THE GRADING/SOIL REMOVAL IS BASED UPON 8
CUBIC YARDS PER TRUCKLOAD WITH AN AVERAGE OF 5 TRUCK LOADS
PER DAY.
 THERE ARE APPROXIMATELY 130 CUBIC YARDS OF SURPLUS SOIL
MATERIAL THAT WILL BE EXPLOYED FROM THE SITE.
 GRADING OPERATIONS SHALL TAKE APPROXIMATELY 6 WORKING DAYS
TO COMPLETE.

4. THE AMOUNT OF GRADING PER DAY WILL VARY, THE AVERAGE BETWEEN 40 & 50 CUBIC YARDS.

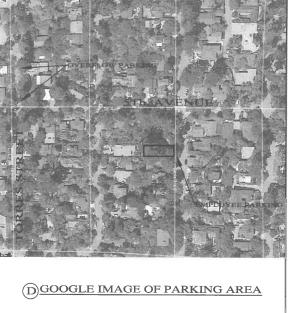

CARMEL BAY

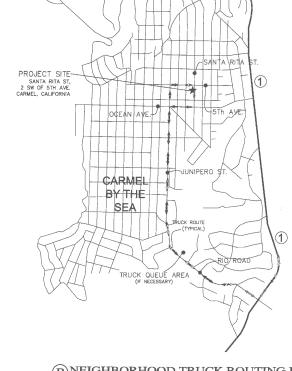




SHEET CMP1

F 1 SHEETS

(B) NEIGHBORHOOD TRUCK ROUTING PLAN

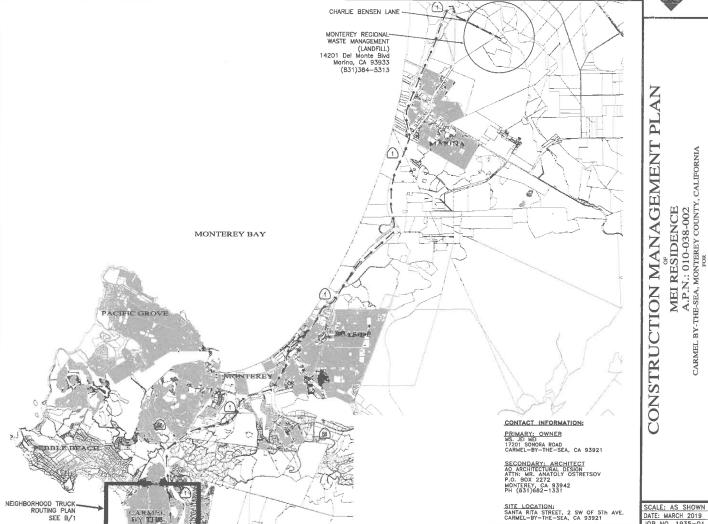

CARMEL VALLEY

OVERALL TRUCK

ROUTING PLAN
NOT TO SCALE

A CONSTRUCTION STAGING PLAN

Color and Material Samples for Santa Rita Residence

Santa Rita 2 SW of 5th, Carmel, CA APN: 010-038-002-000

ROOF FINISH

Standing seam painted aluminum roof "OCM", gutters, and downspouts Color "Quartz Ore" Matte (Light Gray)



BOARD AND BATTEN WALLS



Elastomeric paint over B&B <u>Exterior Paint Color OC-68</u> Benjamin Moore "DISTANT GRAY"

Distant Gray OC-68			

WINDOWS AND DOORS

Jeld Wen wood windows and exterior doors with wood trims Color: Bone White



DRIVEWAY PAVERS

Unilock Artline permeable pavers



FRONT PATHWAY AND COURTYARD TERRACE PAVERS


Hidrologic permeable pavers Color: Brown Stone



ROOF DECK - OPAQUE GLASS RAILING SYSTEM



ROOF DECK - STAINLESS STEEL CABLE RAILING SYSTEM

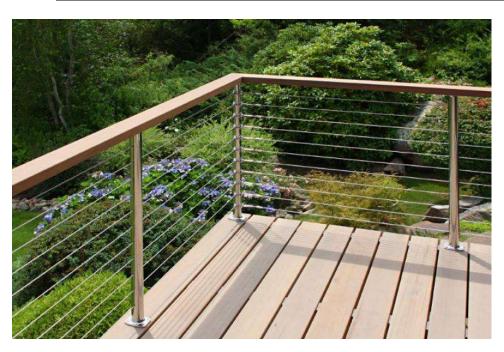

EXTERIOR LIGHT FIXTURE

Minka "Westgate" outdoor wall mount light fixture Model: 72382-246, LED bulb 10W max.

Finish: Alder Bronze



PROPERTY LINE FENCE

6' High redwood lattice top fence (4' high at front setback) Finish: weathered wood gray

