



PROPERTY OWNER:

ZHIRUO CAO AND OLIVER WANG 902 MCBRIDE LOOP SAN JOSE, CA. 95125 PH. (408) 674-7448

■ PROJECT ADDRESS:

MONTE VERDE, 2SW OF 2ND AVE CARMEL-BY-THE-SEA, CA 93921

■ PROJECT SCOPE:

PARTIAL DEMOLITION, REBUILD AND ADDITION TO EXISTING TWO—STORY SINGLE FAMILY RESIDENCE.
 DEMOLISH EXISTING CARAGE AT ZND AVENUE AND BUILD NEW GARAGE AT MONTE VERDE STREET.

■ OCCUPANCY: R-3, U CONST. TYPE:

■ A.P.N. 010-223-034

■ LEGAL DESC.: LOT: 39 BLOCK: II

R-1. SINGLE FAMILY RESIDENTIAL

■ STORIES:

■ MAX BLDG. HT: 24 FT GRADING: ■ TREE REMOVAL: NONE

■ TOPOGRAPHY: SLOPING

■ PROJECT CODE COMPLIANCE:

2016 CBC, CMC, CPC, CFC, CEC, CALIFORNIA RESIDENTIAL CODE, CALIFORNIA GREEN BUILDING CODE & 2016 CALIFORNIA ENERGY CODE

■ LOT AREA: 3,805 S.F. (0.087 Ac.)

■ SITE COVERAGE CALCULATIONS:

	EXISTING	PROPOSED REMOVAL	PROPOSED ADDITION	PROPOSED TOTAL	
DRIVEWAYS	817	-817	8	8	PE
PATIO/BRIDGE	163	-114	97	146	IME
WOOD DECK/STAIRS	348	-348	0	0	PE
STONE STAIRS	143	-56	27	114	IMF
STEPPING STONES	15	-15	0	0	IMF
RETAINING WALL	2	0	0	2	IME
ROCK WALLS	103	-65	0	38	IMF
FENCE	28	-24	6	10	IMF
WATERFALL	102	-102	0	0	PEI
TOTAL	1,721	-1,541	138	318	

NOTE: IMPERVIOUS = IMP. PERMEABLE = PER.

1,712 SF (45%)

1,709 SF (44.9%)

■ SITE COVERAGE ALLOWED: 376.64 SF (22% OF BASE FLOOR AREA) SITE COVERAGE EXISTING: 1,721 SF

■ SITE COVERAGE PROPOSED: 318 SF

■ F.A.R. CALCULATIONS

- 11/11/11 0/12/00				
MAIN BUILDING	EXISTING	PROPOSED REMOVAL	PROPOSED ADDITION	PROPOSE TOTAL
LOWER FLOOR	508	-158	521	871
MAIN FLOOR	304	-196	530	638
GARAGE	255	-255	200	200
TOTAL	1,067	-609	1,251	1,709

■ F.A.R. ALLOWED: F.A.R. PROPOSED:

VICINITY MAP

SHEET NO.

PROJECT LOCATION- JUN A. SILLANO, AIA

721 LIGHTHOUSE AVE

(831) 646-1261 (831) 646-1290 idg@idg-inc.net idg-inc.net

DISCLAIMER:

RECEIVED

FEB 2 5 2020

of Carmel-by-the-S ming & Building Den

PROJECT/CLIENT:

O MONTE VERDE RESIDENCE

PROJECT ADDRESS:

0 MONTE VERDE 2SW OF 2ND AVE. CARMEL, CA 93921

APN: 010-223-034

DATE: AUGUST 14, 2019 PLANNING DEPT. SUB.

REVISIONS:

OCTOBER 15, 2019
PLANNING CLARIFICATION SUB.
NOVEMBER 04, 2019 REV. PLNG. CLARIFICATION SUB DECEMBER 9, 2019

CLARIFICATION SUB.

A JANUARY 21, 2019
PLANNING REVISION SUB.

SITE **PLAN** 

A1.0




LEGEND


WALL MOUNTED DOWNLIGHT LIGHT FIXTURE 10 WATTS


1-25 WATTS MAX. (LED=375 LUMEN) WITH PHOTO SENSOR MINKA-LAVERY KIRKHAM OUTDOOR FIXTURES

## 'A' EXT. WALL MOUNT LIGHT FIXTURE

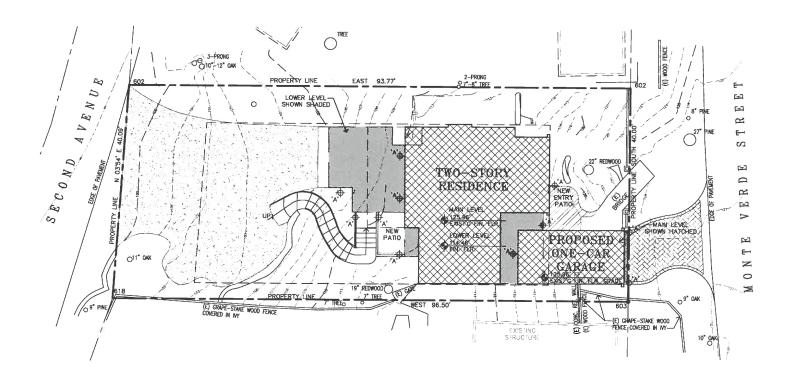

EXTERIOR LIGHTING PLAN

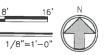

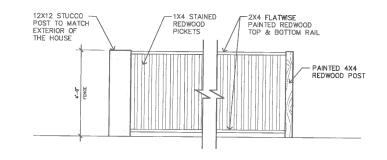





721 LIGHTHOUSE AVE

PH FAX EMAIL WEB (831) 646-1261 (831) 646-1290 idg<sup>e</sup>idg-inc.net idg-inc.net

DISCLAIMER:

STAMPS:

PROJECT/CLIENT:

O MONTE VERDE RESIDENCE

PROJECT ADDRESS:

0 MONTE VERDE 2SW OF 2ND AVE. CARMEL, CA 93921

APN: 010-223-034

DATE: AUGUST 14, 2019 PLANNING DEPT. SUB.

REVISIONS:

OCTOBER 15, 2019

PLANNING CLARIFICATION SUB.
NOVEMBER 04, 2019

REV. PLING. CLARIFICATION SUB.
DECEMBER 9, 2019

CLARIFICATION SUB.

CLARIFICATION SUB.

JANUARY 21, 2019

PLANNING REVISION SUB.

**EXTERIOR** LIGHTING PLAN

SHEET NO.

A1.1



JUN A. SILLANO, AIA

721 LIGHTHOUSE AVE PACIFIC GROVE CA. 93950

DISCLAIMER:

AL DOCA, ESPORA, ARRANCIARIST AND PLAYS ROCKLING TO PROPERTY AND PLAYS TO RECEIVE AND PROPERTY A

STAMPS:

PROJECT/CLIENT:

O MONTE VERDE RESIDENCE

PROJECT ADDRESS:

0 MONTE VERDE 2SW OF 2ND AVE. CARMEL, CA 93921

APN: 010-223-034

DATE: AUGUST 14, 2019
PLANNING DEPT. SUB.

REVISIONS:


OCTOBER 15, 2019
PLANNING CLARIFICATION SUB.
NOVEMBER 04, 2019
REV. PLING. CLARIFICATION SUB.
CLARIFICATION SUB.
CLARIFICATION SUB.
JANUARY 21, 2019
PLANNING REVISION SUB.

SIGHT LINE EVALUATION

SHEET NO.

A1.2

		4-								
Wdw.	Window	Window Size (Finish				Glass		Finish		
No.	Width Height	Height	Head Height	Туре	Material	Туре	Tempered	Interior	Exterior	Remarks
MAIN	LEVEL									
1	2'-6"	5'-0"	6'-8"	FIXED	WD	DBLPANE	YES	STAINED	METAL-CLAD	
2	4'-0"	5'-0"	6'-8"	FIXED	WD	DBLPANE	NO	STAINED	METAL-CLAD	
3	2'-6"	4'-6"	6'-8"	CASEMENT	WD	DBLPANE	YES	STAINED	METAL-CLAD	
4	4'-0"	4'-6"	6'-8"	DBLCASEMENT	WD	DBLPANE	NO	STAINED	METAL-CLAD	
5	4'-0"	4'-6"	6'-8"	DBLCASEMENT	WD	DBLPANE	NO	STAINED	METAL-CLAD	
6	2'-0"	2'-0"	7'-6"	AWNING	WD	DBLPANE	NO	STAINED	METAL-CLAD	
7	2'-0"	2'-0"	7'-6"	AWNING	WD	DBLPANE	NO	STAINED	METAL-CLAD	
8	2'-4"	3'-2"	6'-8"	CASEMENT	WD	DBLPANE	NO	STAINED	METAL-CLAD	
9	2'-4"	3'-2"	6'-8"	FIXED	WD	DBLPANE	NO	STAINED	METAL-CLAD	MULLED UNIT
10	2'-4"	3'-2"	6'-8"	CASEMENT	WD	DBLPANE	NO	STAINED	METAL-CLAD	
11	3'-6"	6'-8"	6'-8"	FIXED	WD	DBLPANE	YES	STAINED	METAL-CLAD	
12	3'-6"	6'-8"	6'-8"	FIXED	WD	DBLPANE	YES	STAINED	METAL-CLAD	

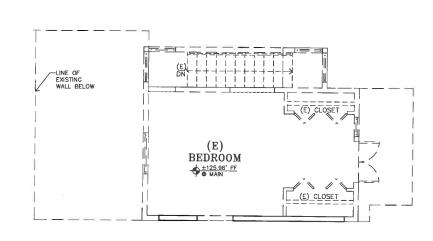


## EXISTING/ DEMOLITION MAIN LEVEL PLAN

1/4"=1'-0"

## WALL LEGEND

2X EXISTING WALL TO REMAIN (E) DOOR OR WINDOW TO BE REMOVED ==== 2X EXISTING WALL TO BE REMOVED

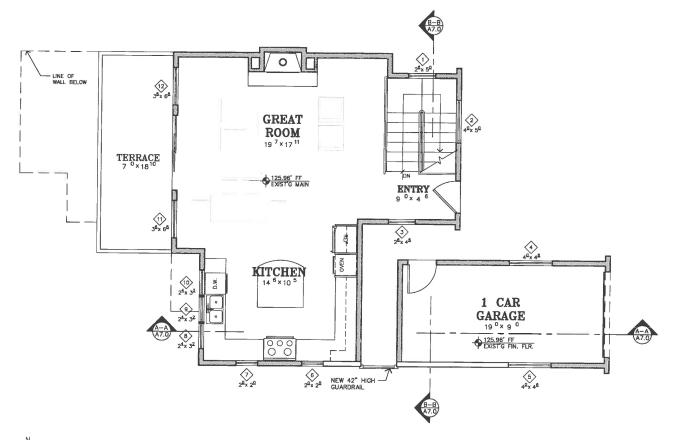



## PROPOSED MAIN LEVEL PLAN

1/4"=1'-0"

## WALL LEGEND

2X EXISTING WALL TO REMAIN

2X6 EXTERIOR STUD FRAMED WALL

2X4 INTERIOR STUD FRAMED WALL, U.O.N.

JUN A. SILLANO, AIA

721 LIGHTHOUSE AVE PACIFIC GROVE CA. 93950

PH FAX EMAIL WEB (831) 646-1261 (831) 646-1290 idg<sup>e</sup>idg-inc.net idg-inc.net

DISCLAIMER:

STAMPS:

PROJECT/CLIENT:

O MONTE VERDE RESIDENCE

PROJECT ADDRESS:

0 MONTE VERDE 2SW OF 2ND AVE. CARMEL, CA 93921

APN: 010-223-034

DATE: AUGUST 14, 2019 PLANNING DEPT. SUB.


REVISIONS:

OCTOBER 15, 2019
PLANNING CLARIFICATION SUB.
NOVEMBER 04, 2019
REV. PING. CLARIFICATION SUB.
DECEMBER 9, 2019
CLARBICATION SUB.
JANUARY 21, 2019
PLANNING REVISION SUB.
FEBRUARY 21, 2020
PLANNING DEPT. REQ.

MAIN LEVEL PLAN

A2.0

				V	VINE		SC	HEDI	JLE	
Wdw.	Window	Size (	(Finished)			Glass		Finish		
No.	Width	Height	Head Height	Туре	Material	Туре	Tempered	Interior	Exterior	Remarks
LOWER	LEVEL									
17	2'-6"	4'-2"	6'-8"	CASEMENT	WD	DBLPANE	NO	STAINED	METAL-CLAD	EGRESS
18	2'-6"	4'-2"	6'-8"	CASEMENT	WD	DBLPANE	NO	STAINED	METAL-CLAD	EGRESS
19	2'-0"	2'-6"	6'-8"	CASEMENT	WD	DBLPANE	YES	STAINED	METAL-CLAD	
20	4'-0"	3'-0"	6'-8"	DBL-CASEMENT	WD	DBLPANE	NO	STAINED	METAL-CLAD	EGRESS
21	2'-0"	6'-8"	6'-8"	FIXED	WD	DBLPANE	YES	STAINED	METAL-CLAD	
22	2'-0"	6'-8"	6'-8"	FIXED	WD	DBLPANE	YES	STAINED	METAL-CLAD	MULLED WITH DOOR 12
23	2'-6"	4'-2"	6'-8"	FIXED	WD	DBLPANE	YES	STAINED	METAL-CLAD	
24	4'-6"	4'-2"	6'-8"	DBL-CASEMENT	WD	DBLPANE	NO	STAINED	METAL-CLAD	FGRESS

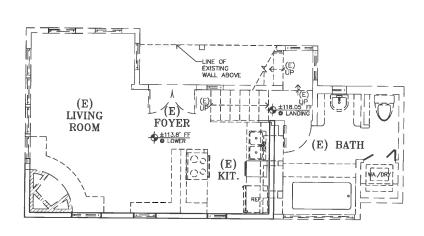


## EXISTING/ DEMOLITION LOWER LEVEL PLAN

1/4"=1'-0"

## WALL LEGEND

2X EXISTING WALL TO REMAIN (E) DOOR OR WINDOW TO BE REMOVED ZX EXISTING WALL TO BE REMOVED

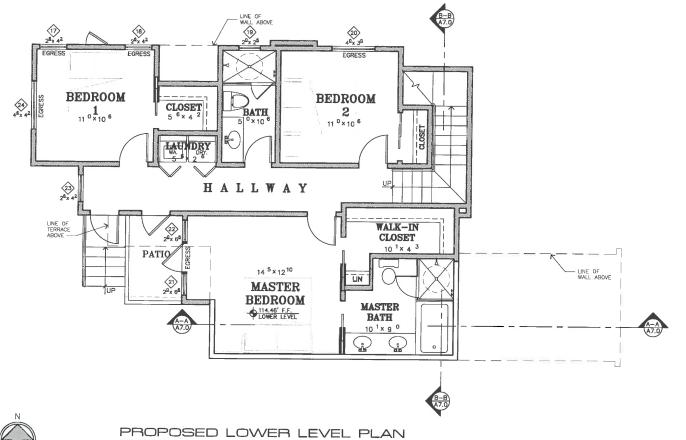



## WALL LEGEND

2X EXISTING WALL TO REMAIN 2X6 EXTERIOR STUD FRAMED WALL 2X4 INTERIOR STUD FRAMED WALL, U.O.N.

# JUN A. SILLANO, AIA

721 LIGHTHOUSE AVE PACIFIC GROVE CA. 93950

(831) 646-1261 (831) 646-1290 idg<sup>©</sup>idg-inc.net PH FAX EMAIL WEB idg-inc.net

DISCLAIMER:

STAMPS:

PROJECT/CLIENT:

O MONTE VERDE RESIDENCE

PROJECT ADDRESS:

0 MONTE VERDE 2SW OF 2ND AVE. CARMEL, CA 93921

APN: 010-223-034

DATE: AUGUST 14, 2019 PLANNING DEPT. SUB.

REVISIONS:

1/4"=1'-0"

OCTOBER 15, 2019

PLANNING CLARIFICATION SUB.
NOVEMBER 04, 2019


REV. PLNG. CLARIFICATION SUB.
DECEMBER 9, 2019
CLARIFICATION SUB.
JANUARY 21, 2019

PLANNING REVISION SUB,
FEBRUARY 21, 2020
PLANNING DEPT. REQ.

LOWER LEVEL PLAN

SHEET NO.

A3.0

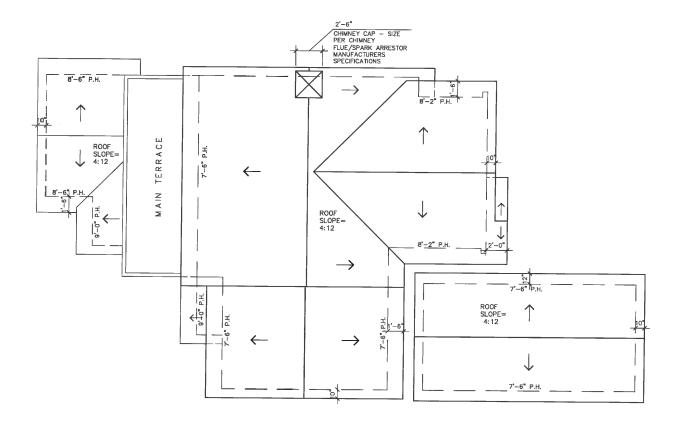

ROOF PLAN



JUN A. SILLANO, AIA

721 LIGHTHOUSE AVE PAICIFIC GROVE CA. 93950

(831) 646-1261 (831) 646-1290 idg<sup>e</sup>idg-inc.net idg-inc.net

DISCLAIMER:

PROJECT/CLIENT:

O MONTE VERDE RESIDENCE

PROJECT ADDRESS:

0 MONTE VERDE 2SW OF 2ND AVE. CARMEL, CA 93921

APN: 010-223-034

DATE: AUGUST 14, 2019 PLANNING DEPT. SUB.


REVISIONS:

OCTOBER 15, 2019
PLANNING CLARIFICATION SUB.
NOVEMBER 04, 2019
REV. PLING. CLARIFICATION SUB.
DECEMBER 9, 2019
CLARIFICATION SUB.
JANUARY 21, 2019
PLANNING REVISION SUB.

**ROOF PLAN** 

SHEET NO.

A5.0

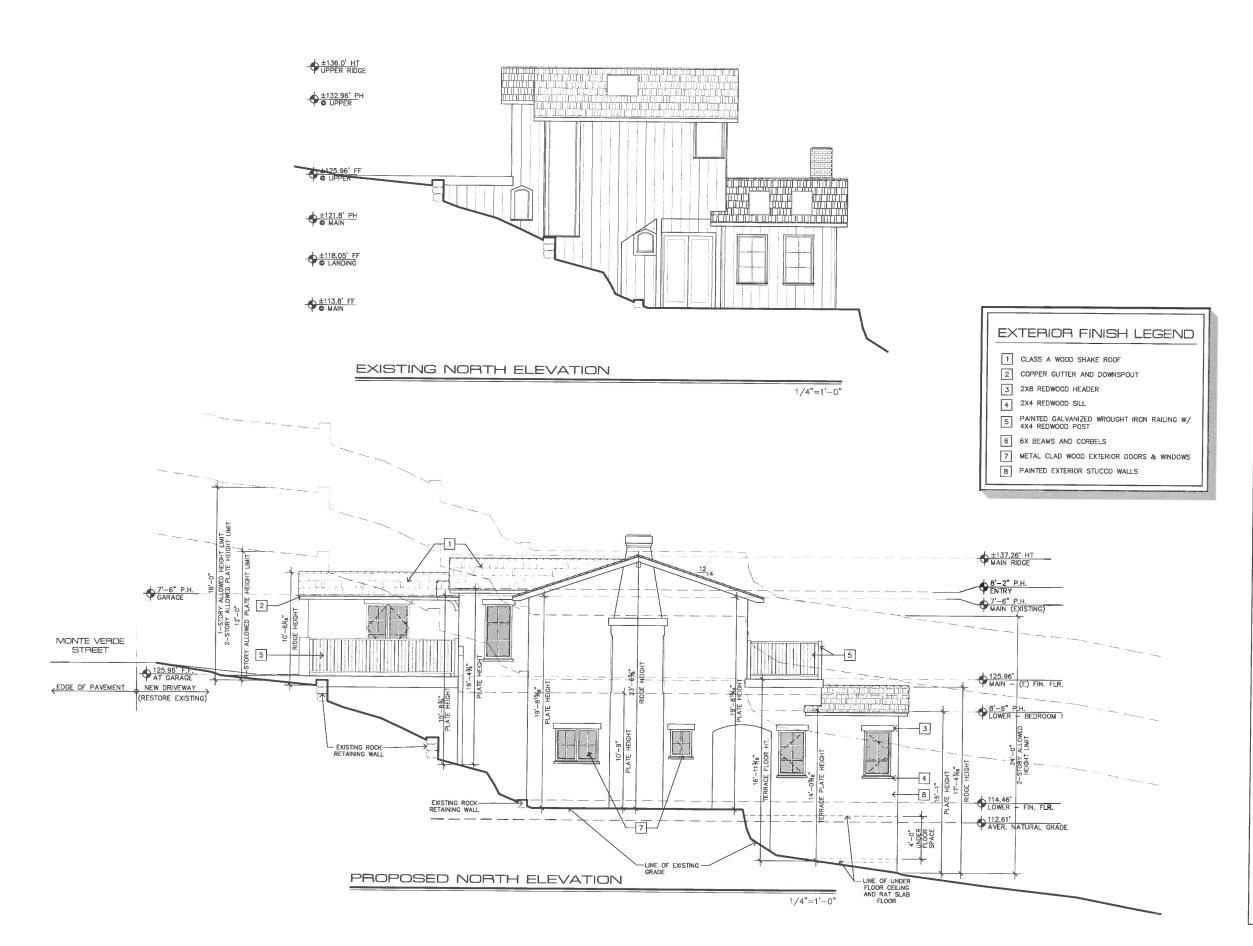



721 LIGHTHOUSE AVE PACIFIC GROVE CA. 93950

PH FAX EMAIL (831) 646-1261 (831) 646-1290 idg®idg-inc.net idg-inc.net

DISCLAIMER:

STAMPS:

PROJECT/CLIENT:

O MONTE VERDE RESIDENCE

PROJECT ADDRESS:

0 MONTE VERDE 2SW OF 2ND AVE. CARMEL, CA 93921

APN: 010-223-034

DATE: AUGUST 14, 2019 PLANNING DEPT. SUB.

REVISIONS:

CCTOBER 15, 2019

PLANNING CLARIFICATION SUB.
NOVEMBER 04, 2019


REV. PUNG. CLARIFICATION SUB.
DECEMBER 9, 2019


CLARIFICATION SUB.
JANUARY 21, 2019
PLANNING REVISION SUB.

**ELEVATIONS** 

SHEET NO.


A6.0

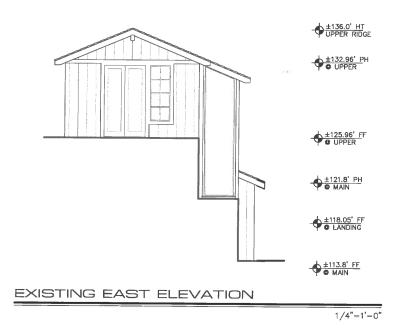

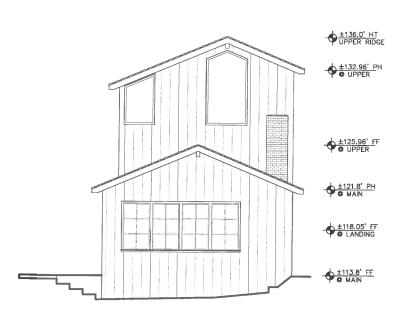

## EXISTING WEST ELEVATION

1/4"=1'-0"

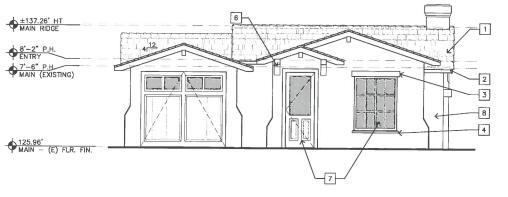


## PROPOSED EAST ELEVATION

1/4"=1'-0"

## EXTERIOR FINISH LEGEND

- 1 CLASS A WOOD SHAKE ROOF
- 2 COPPER GUTTER AND DOWNSPOUT
- 3 2X8 REDWOOD HEADER
- 4 2X4 REDWOOD SILL
- 5 PAINTED GALVANIZED WROUGHT IRON RAILING W/
- 6 6X BEAMS AND CORBELS
- 7 METAL CLAD WOOD EXTERIOR DOORS & WINDOWS
- 8 PAINTED EXTERIOR STUCCO WALLS

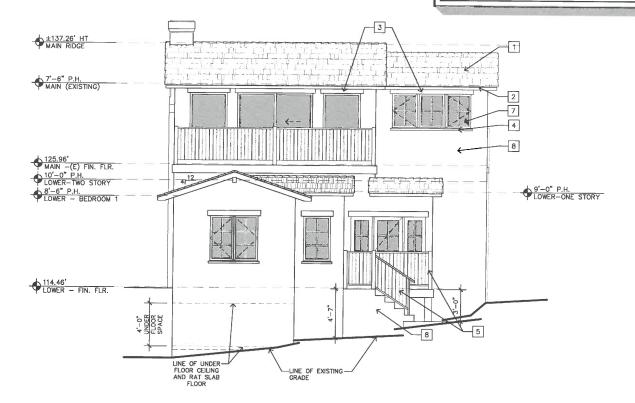

## PROPOSED WEST ELEVATION

1/4"=1'-0"



721 LIGHTHOUSE AVE PACIFIC GROVE CA. 93950

(831) 646-1261 (831) 646-1290 idg**9**idg-inc.net PH FAX EMAIL WEB

idg-inc.net

DISCLAIMER:



STAMPS:

PROJECT/CLIENT:

O MONTE VERDE RESIDENCE

PROJECT ADDRESS:

0 MONTE VERDE 2SW OF 2ND AVE. CARMEL, CA 93921

APN: 010-223-034

DATE: AUGUST 14, 2019 PLANNING DEPT. SUB.

REVISIONS:

OCTOBER 15, 2019
PLANNING CLARIFICATION SUB.
NOVEMBER 04, 2019
REV. PING. CLARIFICATION SUB.
DECEMBER 9, 2019


CLARIFICATION SUB.

JANUARY 21, 2019

PLANNING REVISION SUB.

**ELEVATIONS** 

A6.1

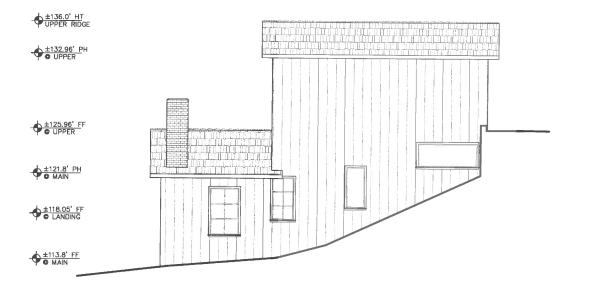


## EXISTING SOUTH ELEVATION

1/4"=1'-0"

## EXTERIOR FINISH LEGEND

- 1 CLASS A WOOD SHAKE ROOF
- 2 COPPER GUTTER AND DOWNSPOUT
- 3 2X8 REDWOOD HEADER
- 4 2X4 REDWOOD SILL
- 5 PAINTED GALVANIZED WROUGHT IRON RAILING W/ 4X4 REDWOOD POST
- 6 6X BEAMS AND CORBELS
- 7 METAL CLAD WOOD EXTERIOR DOORS & WINDOWS
- 8 PAINTED EXTERIOR STUCCO WALLS

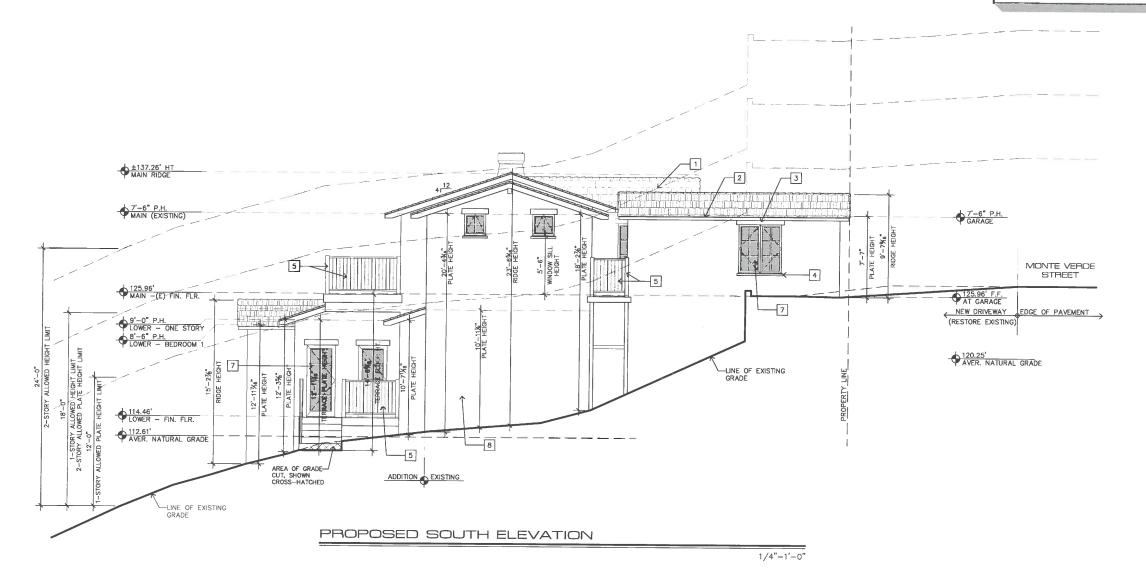

JUN A. SILLANO, AIA

721 LIGHTHOUSE AVE PACIFIC GROVE CA. 93950

PH FAX EMAIL WEB (831) 646-1261 (831) 646-1290 idg®idg-inc.net idg-inc.net

DISCLAIMER:

STAMPS:

PROJECT/CLIENT:

O MONTE VERDE RESIDENCE

PROJECT ADDRESS:

0 MONTE VERDE 2SW OF 2ND AVE. CARMEL, CA 93921

APN: 010-223-034

DATE: AUGUST 14, 2019 PLANNING DEPT. SUB.

REVISIONS:

OCTOBER 15, 2019


PLANNING CLARIFICATION SUB.
NOVEMBER 04, 2019

REV. PUNG. CLARIFICATION SUB.
DECEMBER 9, 2019
CLARIFICATION SUB.
JANUARY 21, 2019
PLANNING REVISION SUB.
FEBRUARY 21, 2020
PLANNING DEPT. REQ.

**ELEVATIONS** 


SHEET NO.

A6.2

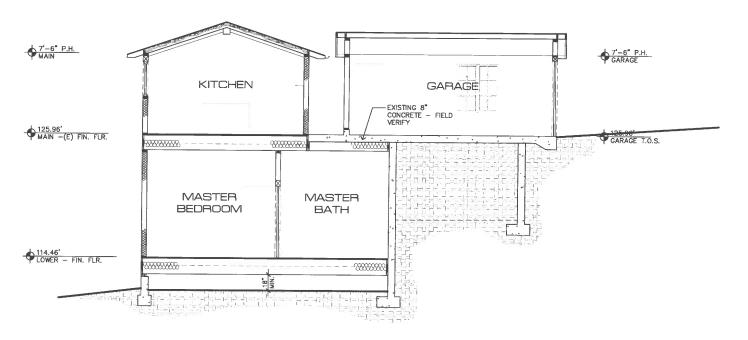

SECTION A-A

1/4"=1'-0"

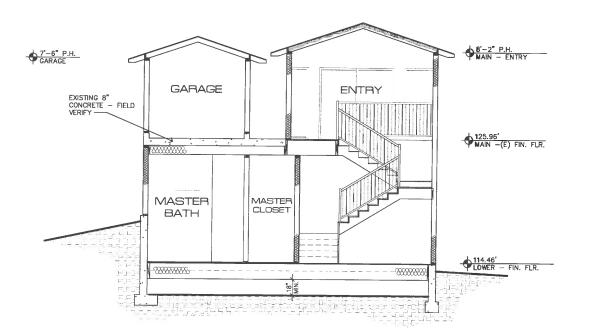

SECTION B-B

JUN A. SILLANO, AIA

721 LIGHTHOUSE AVE P**AC**IFIC GROVE CA. 93950

PH B FAX B EMAIL B (831) 646-1261 (831) 646-1290 idg<sup>6</sup>idg-inc.net idg-inc.net

DISCLAIMER:

STAMPS:

PROJECT/CLIENT:

O MONTE VERDE RESIDENCE

PROJECT ADDRESS:

0 MONTE VERDE 2SW OF 2ND AVE. CARMEL, CA 93921

APN: 010-223-034

DATE: AUGUST 14, 2019 PLANNING DEPT. SUB.

REVISIONS:

OCTOBER 15, 2019

PLANNING CLARIFICATION SUB.
NOVEMBER 04, 2019

REV. PLING. CLARIFICATION SUB.
DECEMBER 9, 2019

CLARIFICATION SUB.
JANUARY 21, 2019


PLANNING REVISION SUB.

SECTIONS

A7.0

## 3. EXTERIOR VOLUME

B. VOLUME OPTION FOR ADDITIONS. IT IS RECOGNIZED THAT EXISTING HOMES BUILT PRIOR TO 2003 MAY NOT HAVE BEEN DESIGNED TO COMPLY WITH VOLUME STANDARDS. FOR THESE HOMES THE FOLLOWING OPTION IS AVAILABLE. ADDITIONS OF FLOOR AREA, WHETHER ATTACHED OR DETACHED, MAY BE APPROVED THROUGH DESIGN REWEW WITHOUT DETERMINING COMPLIANCE WITH THE EXTERNO VOLUME STANDARD FOR THE ENTIRE SITE. INSTEAD, THE ADDITION(S) SHALL COMPLY WITH THE APPLICABLE VOLUME FACTOR (FROM THE TABLE ABOVE), ONLY FOR THE SPECIFIC FLOOR AREA CONTAINED IN THE ADDITION OF THE SPECIFIC FLOOR AREA CONTAINED IN THE ADDITION OF THE SPECIFIC FLOOR AREA CONTAINED IN THE ADDITION OF THE SPECIFIC FLOOR ASSET OF THE ADDITION OF THE ADDITION OF THE SPECIFIC FLOOR ASSET OF THE APPLICABLE STANDARD OF THE APPLICABLE STANDA

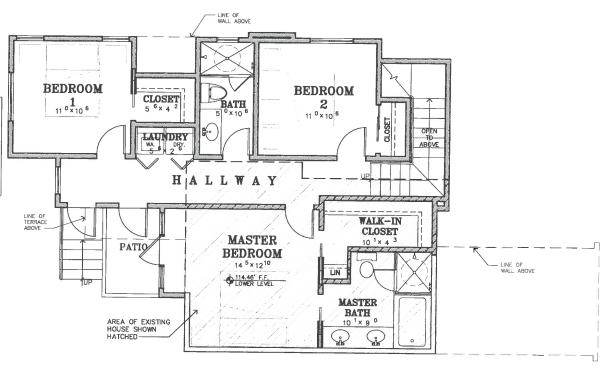


## WALL LEGEND

2X EXISTING WALL TO REMAIN 2X6 EXTERIOR STUD FRAMED WALL 2X4 INTERIOR STUD FRAMED WALL, U.O.N.



## PROPOSED LOWER LEVEL PLAN

1/4"=1'-0"

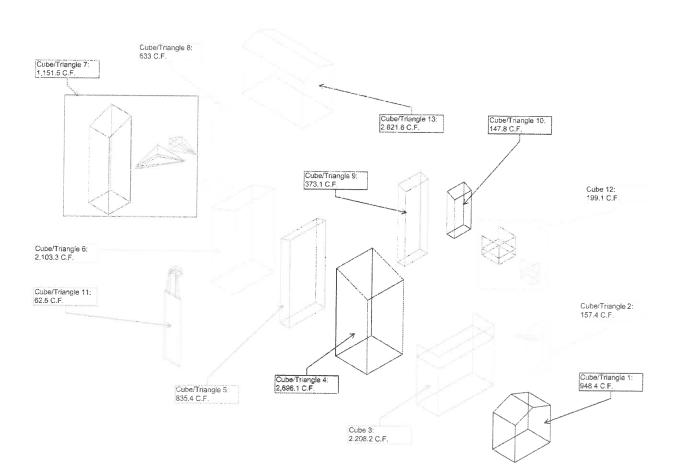

## Volumetrics Analysis

14,337.4

Allowed Volume Proposed Volume:

MAIN HOUSE: FORMS	CALCULATION (H x W x L)	TOTAL C.F
CUBE 1	10'-4" x 11'-5" x 7'-3"	855.3
TRIANGLE 1	2'-3" x 11'-5" x 7'-3" ÷ 2	93.1
CUBE 2	10'-10" x 2'-10" x 4'-7"	140.7
TRIANGLE 2a	1'-6" x 2'-10" x 4'-5.5" ÷ 2	9.5
TRIANGLE 2b	1'-6" x 2'-10" x 5'-1" ÷ 4	5.4
TRIANGLE 2c	6" x 2'-10" x 5'-1" ÷ 4	1.8
CUBE 3	16'-9" x 7'-0" x 18'-10"	2,208.2
CUBE 4	20'-10" x 10'-3" x 11'-7"	2,473.5
TRIANGLE 4	3'-9" x 10'-3" x 11'-7" ÷ 2	222.6
CUBE 5	23'-6" x 3'-0" x 11'-7"	816.6
TRIANGLE 5	1'-1" x 3'-0" x 11'-7" ÷2	18.8
CU3E 6	20'-10" x 7"-3" x 13'-1"	1,976.1
TRIANGLE 6	2'-8" x 7'-3.5" x 13'-1" ÷ 2	127.2
CUBE 7	21'-6" x 6'-6" x 7'-1"	989.9
TRIANGLE 7a	2'-8" x 6'-6" x 7'-1" ÷ 2	61.4
TRIANGLE 7b	2'-8" x 9'-1" x 7'-1" ÷ 4	42.9
TRIANGLE 7c	8" x 9'-1" x 7'-1" ÷ 4	10.7
TRIANGLE 7d	1'-7" x 9'-1" x 4'-2" ÷ 2	30
TRIANGLE 7e	1'-9" × 9'-1" × 4'-2" ÷ 4	16.6
CUBE 8	22'-7" x 6'-6" x 4'-2"	611.6
TRIANGLE 8	1'-7" x 6'-6" x 4'-2" ÷ 2	21.4
CUBE 9	20'-10" x 2'-5" x 7'-3"	365.0
TRIANGLE 9	11" x 2'-5" x 7'-3.5" ÷ 2	8.1
CUBE 10	10'-10" x 2'-5" x 5'-5"	141.8
TRIANGLE 10	11" x 2'-5" x 5'-5" ÷ 2	6
CUBE 11a	18'-10" x 6" x 5'-0"	47.1
CUBE 11b	6'-8" x 6" x 2'-2"	7.2
CUBE 11c	11" x 1'-8" x 2'-2"	3.3
TRIANGLE 11a	6'-B" x 6" X 1'-1" ÷ 2 x 2	3.6
TRIANGLE 11b	11" x 2" x 1'-8" ÷ 2 x 2	.3
TRIANGLE 11c	6" x 1'-3" x 1'-8" ÷ 2 x 2	1
CUBE 12a	5'-4" x 5'-6" x 5'-4"	156.4
CU3E 12b	5'-4" x 2'-0" x 4'-0"	42.7

G	ΔF	2.5	G
pani	÷	÷	ï

CUBE 13	13'-2" x 19'-11" x 10'-0"		2,622.4
TRIANGLE 13	2'-0" x 19'-11" x 10'-0" ÷ 2		199.2
		TOTAL	14,337.4

Sub-total 11,515.8

JUN A. SILLANO, AIA

721 LIGHTHOUSE AVE PACIFIC GROVE CA. 93950

PH FAX EMAIL WEB (831) 646-1261 (831) 646-1290 idg<sup>9</sup>idg-inc.net idg-inc.net

DISCLAIMER:

STAMPS:

PROJECT/CLIENT:

O MONTE VERDE RESIDENCE

PROJECT ADDRESS:

0 MONTE VERDE 2SW OF 2ND AVE. CARMEL, CA 93921

APN: 010-223-034

DATE: AUGUST 14, 2019 PLANNING DEPT. SUB.

REVISIONS:

OCTOBER 15, 2019

PLANNING CLARIFICATION SUB.
NOVEMBER 04, 2019
REV. PUNG. CLARIFICATION SUB.
DECEMBER 9, 2019
CLARIFICATION SUB.
JANUARY 21, 2019
PLANNING REVISION SUB.

**VOLUMETRICS ANALYSIS** 

SHEET NO.

V1.0

## BUILDING DEPARTMENT NOTES: PERMITS & INSPECTIONS:

QUANTITY SIZE WUCOLS

5 gal

5 gal

5 gai

1 gal

1 gal

15 gal

1 gal

1 gai

1 gal

5 gal

Low

Low

Low

Med

Low

Low

Low

Low

Low

PLANTING LEGEND

SYMBOL BOTANICAL NAME

CEA CON Ceanothus 'Concha'

CON MAU Convolvulus mauritanicus

HEU CAN Heuchera 'Canyon Duet'

QUE AGR Quercus agrifolia

SAL LEU Salvia leucantha

SAL SON Salvia sonomensis

//O 9" PINE

WOO FIM Woodwardia fimbriata

ARC EME Arctostphylos 'Emerald Carpet'

ARC HOW | Arctostanhylos 'Howard McMinn'

ROS TUS Rosmarinus officinalis 'Tuscan Blue'

COMMON NAME

Concha Ceanothus

Coast Live Oak

Creeping Sage

Giant Chain Fern

Ground Morning Glory

Canyon Duet Coral Bells

Tuscan Blue Rosemary

Mexican Bush Sage

Emerald Carpet Manzanita

Howard McMinn Manzanita

THE CONTRACTOR SHALL OBTAIN ALL REQUIRED INSPECTIONS FOR THE WORK AND GIVE THE OWNER TIMELY NOTICE OF INTENT TO EACH INSPECTION.

### CODES:

ALL MATERIAL, WORKMANSHIP AND METHODS OF CONSTRUCTION SHALL CONFORM TO THE APPLICABLE REQUIREMENTS OF THE UBC AND LOCAL BUILDING CODES.

NO POTABLE WATER MAY BE USED FOR COMPACTION OR DUST CONTROL PURPOSES IN CONSTRUCTION ACTIVITIES WHERE THERE IS A REASONABLY AVAILABLE SOURCE OF RECLAIMED WATER.

CONTRACTOR TO USE AUTO SHUT-OFF NOZZLES ON ANY WATER HOSES USED ON THE PROJECT.

LAYOUT NOTES: ANNOTATED DIMENSIONS TO TAKE PRECEDENCE OVER SCALED DRAWINGS.

ALL NON IRRIGATED BRUSH TO BE KEPT AT GROUND LEVEL FOR AN AREA OF 50' SURROUNDING THE PROPOSED RESIDENCE.

## XERISCAPE PRACTICES:

LOW WATER USE, DROUGHT TOLERANT PLANTS
 WATER CONSERVING IRRIGATION TECHNIQUES AND SYSTEMS
 DRIP IRRIGATE ALL PLANT MATERIAL
 INSTALLATION OF RAIN SENSOR

### PLANTING NOTES:

ALL LANDSCAPE AREAS SHALL BE CONTINUOUSLY MAINTAINED IN A LITTER FREE, WEED FREE CONDITION AND ALL PLANT MATERIAL SHALL BE CONTINUOUSLY MAINTAINED IN A HEALTHY GROWING CONDITION.

STAKING: STAKING SHALL BE PROVIDED FOR TREES AND SHRUBS AS NEEDED. TIES TO BE LOCATED AND SIZED TO ALLOW FOR EXPANSION AND GROWTH.

MULCHING: SPREAD 3" OF MULCH OVER ALL EXPOSED PLANTING AREAS COMPOST MINIMUM OF 4 CUBIC YARDS PER 1,000SQFT OF PERMEABLE AREA TO A DEPTH OF  $6^{\star}$ 

WHEN STAGING PLANT MATERIAL ON SITE INSTALL A TEMPORARY DRIP LINE AS NEEDED.

SOIL AMENDMENT TO BE ADDED TO PLANTED ARE AS NEEDED FOR PLANT MATERIAL

### SCOPE OF WORK:

THIS IS RESTORATION OF AN EXISTING LANDSCAPE. IRRIGATION TO BE CONNECTED TO EXISTING SYSTEM AND EXPANDED WITH DRIP IRRIGATION FOR NEW PLANTINGS LANDSCAPE DESIGNED TO USE ALL NATIVE AND/OR DROUGHT TOLERANT PLANTING.

### PROJECT INFORMATION:

OWNER ZHIRUO CAU AND OLIVER WANG SITE

MONTE VERDE, 2SW OF 2ND AVE. CARMEL-BY-THE-SEA, CA 93921

APN 010-223-034 TOPOGRAPHY

TREE REMOVAL TREE REPLACEMENT PLAN TO MEET MONTEREY COUNTY REQUIERMENTS

GRADING SOILS REPORT SEE SOILS REPORT

### LANDSCAPING STATEMENT:

I PATRICK WILSON CERTIFY THAT THIS LANDSCAPING AND IRRIGATION PLAN COMPLIES WITH ALL CITY OF CARMEL'S LANDSCAPING REQUIREMENTS INCLUDING USE OF NATIVE, DROUGHT TOLERANT, NON-INVASIVE SPECIES, LIMITED TURF; AND LOW-FLOW, WATER CONSERVING IRRIGATION FIXTURES



## **MISSION** LANDSCAPING

P.O. BOX 875 PACIFIC GROVE CALIFORNIA 93950

> P 831 373 8293 F 831 373 2283

www.missionlandscaping.com email: missionlandscaping@me.com

Landscape & General Contractors C27 & B 392291 Landscape Architecture CA Lic #5806

Wang Residence Monte Verde, 2SW of 2nd Ave. Carmel-by-the-Sea, CA 93921.

APN: 010-223-034 Revisions:



Drawing Title:


Landscape Plan

11/13/19 1/8\*\*=1\*0\*\* Drawn By: DW & PW

L1.0

Page Number

C Mission Landscaping Inc. 2019

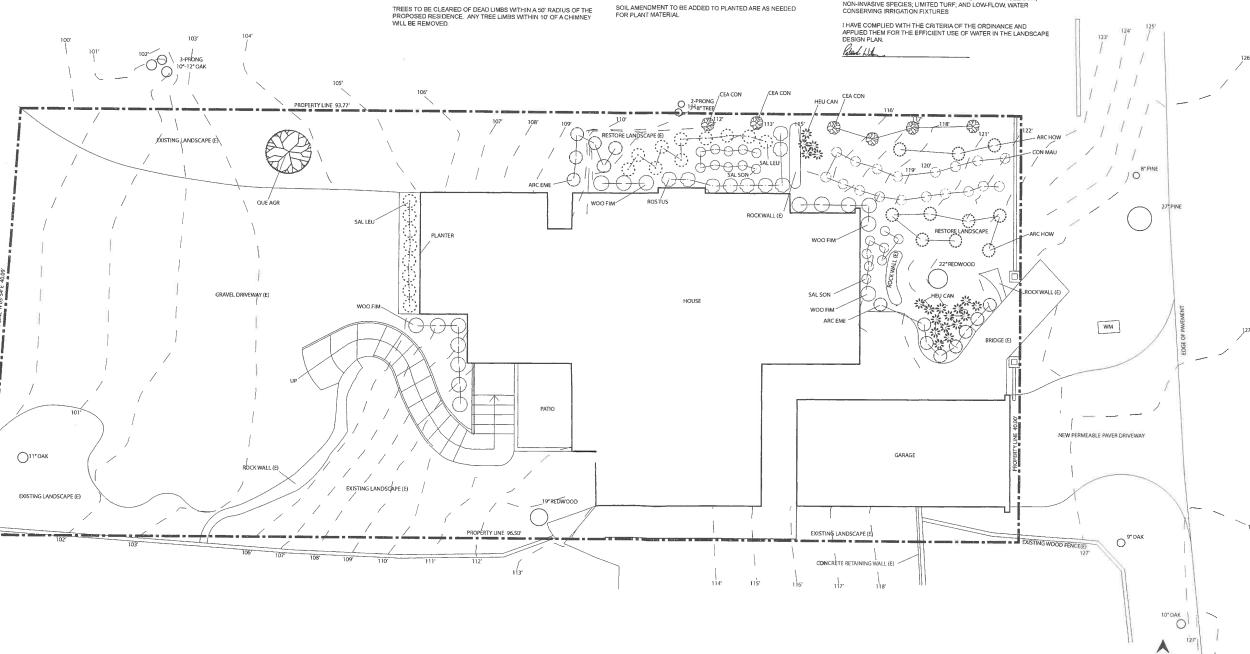

| IRRIGATION SCHEDULE: FOR ESTABLISHMENT PERIOD - ONE YEAR 1 AND 2 GALLON PLANTS 15 MINS X 2 TIMES PER WEEK 5 AND 15 GALLON PLANTS 20 MINS X 2 TIMES PER WEEK 24° BOX TREES 00 MINS X 2 TIMES PER WEEK XERISCAPE PRACTICES: IRRIGATION LEGEND: SYSTEM DESIGNED TO PREVENT LOW HEAD DRAINAGE AND NO OVERSPRAY OR RUNOFF ALL IRRIGATION MAIN LINE TRENCHING SHALL BE A MINIMUM OF 18" MIN. BELOW FINISH AT PLANTER BEDS AND 24" MIN. BELOW PAUED SURFACES. LATERA LINES TO BE 12" BELOW FINISH. AND DRIP LINES TO BE 5" BELOW FINISH. 1. LOW WATER USE, DROUGHT TOLERANT PLANTS 1 5" DIA SCH 40 PVC MAIN SUPPLY LINE IRRIGATION LAID OUT TO CONFORM TO HYDROZONES INDICATED ON LANDSCAPE PLAN 2. WATER CONSERVING IRRIGATION TECHNIQUES AND SYSTEMS FEBCO BACKFLOW PREVENTION DEVICE 3. DRIP IRRIGATE ALL NON-TURF PLANT MATERIAL FOR MATURE PERIOD - AFTER ONE YEAR OR DETERMINE ON PLANT TO CONNECT IRRIGATION WATER LINE TO DOMESTIC MAIN SUPPLY VIA BACKFLOW PREVENTION DEVICE. (SEE DETAIL.)  $\boxtimes$ SYSTEM DESIGNED TO ACHIEVE MINIMUM IRRIGATION EFFICIENCY OF 75 FOR OVERHEAD SPRAY AND .81 FOR DRIP ZONES 1 AND 2 GALLON PLANTS
5 AND 15 GALLON PLANTS
24 BOX TREES
24 BOX TREES
25 AND 15 GALLON PLANTS
26 MINS X 1 TIMES PER WEEK
30 MINS X 1 TIMES PER WEEK 4. INSTALLATION OF WEATHER SENSOR AND SMART CONTROLLER TO REGULATE EFFICIENT WATERING. VALVE BOX ALL BANKS OF IRRIGATION VALVES TO BE CONNECTED TO IRRIGATION MAINLINE AFTER A GATE VALVE FOR SERVICING OF INDIVIDUAL BANKS.  $\odot$ RAINBIRD ESP-SMT SMART IRRIGATION CONTROLLER 5. IRRIGATION ZONES TO BE BASED ON LIKE WATER NEEDS. SYSTEM USES LOW VOLUME IRRIGATION IN MULCHED PLANTING AREAS AS PLANTS MATURE AND BECOME MORE ESTABLISHED, THE IRRIGATION CAN BEGIN TO TAPER OFF AS MUCH AS THE PLANTS WILL ALLOW. 0 SYSTEM HAS MATCHED PRECIPITATION RATES FOR HEAD AND EMISSION DEVICES IRRIGATION DEMAND: AUTOMATIC CONTROLLER DEVICE: ₩ RAINBIRD ESP RAIN SENSOR THE IRRIGATION HEADS ARE LAID OUT FOR OPTIMAL SPACING 14GPM AT 55 PSI STATIC UPSTREAM OF BACKFLOW PREVENTOR. VERIFY EXACT PRESSURE PRIOR TO SHALL BE WALL MOUNTED AS DIRECTED BY LANDSCAPE CONTRACTOR. SERVICE TO BE 120 VOLTAC HARDWIRED GATE VALVE SWING JOINTS ARE USED ON ALL SPRINKLER HEADS COMMENCEMENT OF WORK PER ELECTRICAL CONTRACTOR. 4" SCH 40 PVC CHASE PIPE SYSTEM USES CHECK OR ANTI-DRAIN VALVES LOW VOLTAGE LIGHTING: LANDSCAPING STATEMENT: SUBSURFACE IRRIGATION OR OTHER MEANS THAT PRODUCES NO RUNOFF OR OVERSPRAY FOR TURF OR OTHER AREAS LESS THAN 10 FEET IN WIDTH TO BE INSTALLED IN ELECTRAL CONDUIT. RUN ADDITIONAL I PATRICK WILSON CERTIFY THAT THIS LANDSCAPING AND IRRIGATION PLAN COMPLIES WITH ALL CITY OF CARMEL BY-THE-SEA LANDSCAPING REQUIREMENTS INCLUDING USE OF NATIVE, DROUGHT TOLERANT, NON-INVASIVE SPECIES, LIMITED TURF; AND LOW-FLOW, WATER CONSERVING IRRIGATION FIXTURES 2" CHASES AND EXTRA WIRES AS NEEDED. LOCATE BEOW MAIN IRRIGATION LINES. SEE ELECTRICAL PLAN. WHERE SPRINKLER HEADS ARE CLOSER THAN 24" TO HARDSCAPE, HARDSCAPE IS DESIGNED TO DRAIN ENTIRELY INTO LANDSCAPE HOSE BIBS: EACH VALVE IRRIGATES HYDROZONE WITH SIMILAR CONDITIONS WITH SPRINKLER HEADS AND EMISSION DEVICES THAT ARE APPROPRIATE FOR THE PLANT TYPE WITHIN THE LYDROZOME. TO BE BRASS AND INSTALLED ON A 4"X4" PRESSURE I HAVE COMPLIED WITH THE CRITERIA OF THE ORDINANCE AND APPLIED THEM ACCORDINGLY FOR THE EFFICIENT USE OF WATER IN THE IRRIGATION DESIGN PLAN. THE HYDROZONE VALVE BOXES, PIPE, AND HOSE BIBS: ALL EXPOSED COMPONENTS OF IRRIGATION SYSTEM TO BE PURPLE IN COLOR TO SHOW IT IS RECLAIMED WATER. TREES WILL BE PLACED ON SEPARATE VAVLES FROM SHRUBS, GROUNDCOVERS, AND TURF WHERE FEASIBLE DRIP EMITTERS TO BE 1 GPH UNLESS OTHERWISE NOTED NEW VALVES FOR RESTORATION LANDSCAPE PLANTS 678 / O 8" PINE

19"REDWOOD

PLANTER

GRAVEL DRIVEWAY (F)

ROCK WALL (E)

EXISTING LANDSCAPE (E)

//O 9" PINE

Wang Residence Monte Verde, 2SW of 2nd Ave. Carmel-by-the-Sea, CA 93921.

MISSION

LANDSCAPING

P.O. BOX 875

PACIFIC GROVE

CALIFORNIA 93950

P 831 373 8293

F 831 373 2283

www.missionlandscaping.com

email: missionlandscaping@me.com

Landscape & General Contractors C27 & B 392291 Landscape Architecture CA Lie #5806

APN: 010-223-034 Revisions:

RESTORE LANDSCAPE

GARAGE

CONCRETE RETAINING WALL (E)

WM

0

EXISTING WOOD FENCE(E)




Drawing Title:


Irrigation Plan


L2.0


© Mission Landscaping Inc. 2019

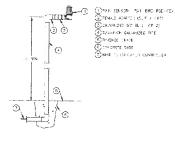


RAIN SENSOR
RSD-CEX POLE MOUNT

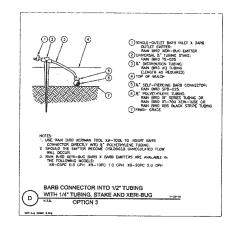

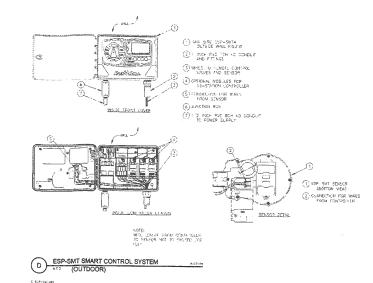

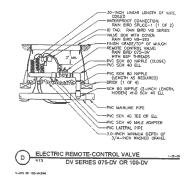

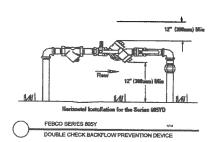

WATER CALCULATIONS FOR NEW PLANTING

Water Efficient Landscape Wo	-labora	T	7			<del></del>	,
Instructions:	rksneet	<del> </del>					
Fill in all items in this color			<del> </del>		ļ		
Answer is shown in this color				ļ			
Answer is snown in this color	<del> </del>	ļ					
Reference Evapotranspiration (E	To)	32.9	Carmet	<del>                                     </del>			
	ETWU requirement	ETWU requirement	ETWU requirement	ETWU requirement	MAWA requirement	ETWU requirement	
	Plant Factor	Irrigation	Irrigation		Landscape Area		Estimated Total Water Use
Hydrozone#/Planting Description	(PF)	Method	Efficiency (IE)	ETAF (PF/IE)	(LA) (sq. ft.)	ETAF x Area	(ETWU)
Regular Landscape Areas							
1) low water use plants		Drip	0.81	0.247	449	110.86	2,26
2) medium water use plants	0.4	Drîp	0.81	0.494	57	28,15	574
3) high water use (pool & spa)	0.7	Drip	1	0.700	0	0.00	3,-
						0.00	
			Tota	ıls	506	139.01	2,836
Special Landscape Areas (SLA): R	ecycled Water						
low water use plants				1	0	0	0
medium water use plants				1	0	0	
medium water use plants				1	0	0	C
				Totals	0	0	
				E	stimated Total Wa	ter Use (ETWU)	2.836
				4,645			
Di- A Was a Live T		Irrigation	Irrigation				
Plant Water Use Type very low	Plant Factor 0-0.1	method	Efficiency				
low		overhead spray	0.75				
low	0.1-0.3	drip	0.81				
medium	0.4-0.6				1		
high	0.7-1.0						
MAWA (annual gallons allowed)=						1	
morre (annual gations attowed)=	(Eto) (0.62) [(ET/	AF x LA) + ((1-ET	AF) x SLA)]				
where 0.62 is a conversion factor tyear. LA is the total landsape area ETAF is .55 for residential areas an	that converts acre	-inches per acre	lugar to gallan	er sq. ft./ q. ft., and			
where 0.62 is a conversion factor t year. LA is the total landsape area ETAF is .55 for residential areas an	that converts acre	-inches per acre	lugar to gallan	ersq.ft./ q.ft., and			
where 0.62 is a conversion factor t year. LA is the total landsape area ETAF is .55 for residential areas an ETAF Calculations	that converts acre	-inches per acre	lupar to collect	er sq. ft./ q. ft., and			
where 0.62 is a conversion factor t year. LA is the total landsape area ETAF is .55 for residential areas an ETAF Calculations Regular Landscape Areas	that converts acre in sq. ft, SLA is the d 0.45 for non re	-inches per acre	lupar to collect	er sq. ft./ q. ft., and			
where 0.62 is a conversion factor t year. LA is the total landsape area ETAF is .55 for residential areas an ETAF Calculations Regular Landscape Areas Total ETAF x Area	that converts acre in sq. ft, SLA is the d 0.45 for non re	e-inches per acre he total special la sidential areas.	/year to gallons pe indscape area in s	q. ft., and			
where 0.62 is a conversion factor t year. LA is the total landsape area ETAF is .55 for residential areas an <u>TAF Calculations</u> Regular Landscape Areas Total ETAF x Area Total Area	that converts acre in sq. ft, SLA is ti d 0.45 for non re	e-inches per acre, ne total special la sidential areas.	/year to gallons pe indscape area in s	q. ft., and	0.55 or below for		
where 0.62 is a conversion factor t year. LA is the total landsape area ETAF is .55 for residential areas an <u>TAF Calculations</u> Regular Landscape Areas Total ETAF x Area Total Area	that converts acre in sq. ft, SLA is ti d 0.45 for non re	e-inches per acre, ne total special la sidential areas.	lupar to collect	q. ft., and	0.55 or below for		
where 0.62 is a conversion factor t year. LA is the total landsape area ETAF is .55 for residential areas an ETAF Calculations degular Landscape Areas Total ETAF x Area Total Area Average ETAF	that converts acre in sq. ft, SLA is ti d 0.45 for non re	e-inches per acre, ne total special la sidential areas.	/year to gallons pe indscape area in s	q. ft., and	0.55 or below for ential areas.		
where 0.62 is a conversion factor t year. LA is the total landsape area ETAF is .55 for residential areas an <u>TAF Calculations</u> Regular Landscape Areas fotal ETAF x Area fotal Area Average ETAF	that converts acre in sq. ft, SLA is ti d 0.45 for non re 139 506 0.27	e-inches per acre, ne total special la sidential areas.	/year to gallons pe indscape area in s	q. ft., and	0.55 or below for ential areas.		
where 0.62 is a conversion factor to year. LA is the total landsape area ETAF is .55 for residential areas an ETAF Calculations. Regular Landscape Areas Total ETAF x Area Total Area Average ETAF All Landscape Areas Total ETAF x Area	that converts acre in sq. ft, SLA is ti d 0.45 for non re 139 506 0.27	e-inches per acre, ne total special la sidential areas.	/year to gallons pe indscape area in s	q. ft., and	0.55 or below for ontial areas.		
where 0.62 is a conversion factor t year. LA is the total landsape area ETAF is .55 for residential areas an ETAF Calculations Regular Landscape Areas Total ETAF x Area Total Area Werage ETAF	that converts acre in sq. ft, SLA is ti d 0.45 for non re 139 506 0.27	e-inches per acre, ne total special la sidential areas.	/year to gallons pe indscape area in s	q. ft., and	0.55 or below for ontial areas.		

ETWU AND MAWA FOR NEW PLANTING

ETWU = 2,836 GALLONS OR .0087 ACRE FEET MAWA = 4,645 GALLONS OR .0143 ACRE FEET

ETWU IS LESS THAN MAWA



MISSION LANDSCAPING

P.O. BOX 875 PACIFIC GROVE CALIFORNIA 93950

P 831 373 8293 F 831 373 2283 www.missionlandscaping.com email: missionlandscaping@me.com Landscape & General Contractors C27 & B 392291 Landscape Architecture CA Lic #5806

Wang Residence Monte Verde, 2SW of 2nd Ave. Carmel-by-the-Sea, CA 93921.

APN: 010-22**3-0**34 Revisions:



Drawing Title:

Irrigation Details

11/13/19 Scale: 1/8"=1.0" Drawn By: DW & PW Page Number:

L2.1

© Mission Landscaping Inc. 2019

## **COLOR AND MATERIAL SAMPLES FOR**

WANG-CAO PROJECT

MONTE VERDE 2SW OF 2<sup>ND</sup> AVE., CARMEL-BY-THE-SEA, CA APN: 010-223-034

CLASS 'A' SIMULATED WOOD SHAKE ROOF



CEDUR ROOFING SHAKES WALDEN

HALF-ROUND COPPER

**GUTTERS & DOWNSPOUTS** 



PAINTED GALVANIZED W.I. RAILING WITH REDWOOD POSTS



**EXTERIOR STUCCO WALLS** 



MAIN COLOR: KELLY MOORE: DOESKIN (202)

## HEADERS, SILLS, CORBELS AND BEAMS




SEMI-TRANSPARENT STAIN CABOT: MISSION BROWN

## EXTERIOR TERRACE/PATIO FLOOR TILE



PORCELAIN TIL LIGHT GREY

## METAL CLAD WOOD EXTERIOR DOORS & WINDOWS

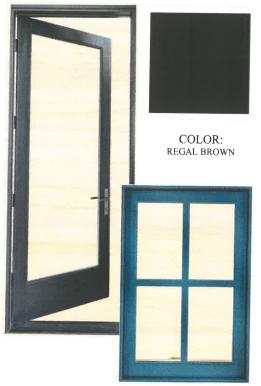

## RECEIVED

FEB 2 5 2020

City of Carmel-by-the-Sea Planning & Building Dept.

## RECONFIRGURED ROCK WALLS



REUSE EXISTING ROCK