

SITE INFORMATION

PACIFIC GAS & ELECTRIC 245 MARKET ST., MAIL CODE N10D SAN FRANCISCO, CA 94105 CONTACT: DAVID 7FNNFR PH: (415) 847-0283

APPLICANT:

2785 MITCHELL DRIVE, BLDG. 9 WALNUT CREEK, CA 94598 36' 33' 0.26" N

VERIZON WIRELESS

LATITUDE (NAD 83): LONGITUDE (NAD 83): 121' 55' 40.43" W GROUND ELEVATION +63.40' AMSI CITY OF CARMEL ZONING JURISDICTION

PROPOSED USE UNMANNED TELECOMMUNICATIONS FACILITY

PROJECT TEAM

TRAFFIC CONTROL NOTE

PRIOR TO STARTING WORK, AND A MINIMUM OF FIVE (5) DAYS IF WORK WILL AFFECT A BUS STOP OR AN EXISTING TRAFFIC SIGNAL, OR IF WORK WILL REQUIRE A ROAD OR ALLEY CLOSURE.

APPLICANT:
VERIZON WIRELESS
2785 MITCHELL DRIVE, BLDG. 9
WALNUT CREEK, CA 94598
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RF ENGINEER:
VERIZON WIRELESS
2785 MITCHELL DRIVE, BLDG. 9
WALNUT CREEK, CA 94598
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ARCHITECT/ENGINEERING: CELLSITE CONCEPTS 10650 SCRIPPS RANCH BLVD., SUITE 224 SAN DIEGO, CA 92131 CONTACT: REGGIE GABRIEI PHONE: (619) 200-7190 EMAIL: reggie.gabriel@cellsite.net

<u>SITE ACQUISITION:</u> SEQUOIA DEPLOYMENT SERVICES, INC. 22471 ASPAN ST., SUITE #290 LAKE FOREST, CA 92630 CONTACT: CHELSEA MANUTO

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ZONING: SEQUOIA DEPLOYMENT SERVICES, INC. 22471 ASPAN ST., SUITE #290 LAKE FOREST, CA 92630 CONTACT: MICHAEL NAZAROFF PHONE: (562) 237-6380
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PROJECT DESCRIPTION

THE PROJECT CONSISTS OF INSTALLATIONS OF TELECOMMUNICATIONS EQUIPMENT FOR VERIZON WIRELESS TO COLLOCATE ON EXISTING PG&E POLE. THE INSTALLATIONS ENTAILS:

- INSTALL (1) PROPOSED VERIZON WIRELESS 4'-0" HIGH CANTENNA ON POLE
- PROPOSED VERIZON WIRELESS 7'-0" HIGH POLE TOP EXTENSION
 PROPOSED VERIZON WIRELESS EQUIPMENT STANDOFF INSTALL (1)
- PROPOSED VERIZON WIRELESS EQUIPMENT SHROUD WITH REMOTE RADIO UNITS (RRU).
- DIPLEXER(S), PSU(S) AND FIBER DEMARC.
 INSTALL (1) PROPOSED VERIZON WIRELESS SMART POLE METER
-) PROPOSED VERIZON WIRELESS DISCONNECT SWITCH AND DISTRIBUTION PANEL ON TAXABLE OF TAXAB
- INSTALL ASSOCIATED CABLING AND GROUNDING

APPLICABLE CODES

NLL WORK AND MATERIALS SHALL BE PERFORMED AND INSTALLED IN ACCORDANCE WITH THE CURRENT EDITIONS OF THE FOLLOWING CODES AS ADOPTED BY THE LOCAL GOVERNING AUTHORITIES THE CONTRACTOR SHALL SUBMIT A TRAFFIC CONTROL PLAN (11"X17") FOR APPROVAL PRIOR TO STARTING WORK. THE PLAN SHOULD BE SUBMITTED TO THE TRAFFIC CONTROL PERMIT COUNTER. CONTRACTOR SHALL OBTAIN A TRAFFIC CONTROL PERMIT A MINIMUM OF TWO (2) WORKING DAYS

- CALIFORNIA ADMINISTRATIVE CODE (INCL TITLE 24 & 25)
 2016 CALIFORNIA BUILDING CODE
 LOCAL BUILDING CODE
- CITY/COUNTY ORDINANCES
- ANSI/EIA-222-G LIFE SAFETY CODE NFPA-101 2016 CALIFORNIA ELECTRICAL CODE
- CA PUBLIC UTILITIES COMMISSION ORDER (GO 95 AND GO 128)

Verizon

PROJECT TYPE: POLYGON **SOUTH CARMEL 001**

IFO A2 LOT 11 SAN ANTONIO AVE., **CARMEL, CA 93923**

LOCATION CODE: 428216

SITE: (PG&E POLE # 110293014)

GENERAL NOTES

- LOCATIONS OF UNDERGROUND UTILITIES SHOWN ON THE DRAWINGS WERE OBTAINED BY A SEARCH OF AVAILABLE RECORDS. NEITHER THE OWNER NOR THE ENGINEER ASSUMES ANY RESPONSIBILITY FOR UTILITIES OR STRUCTURES NOT SHOWN OR NOT IN THE LOCATION SHOWN ON THE DRAWINGS.
- THE CONTRACTORS SHALL INSTALL ALL EQUIPMENT AND MATERIALS IN ACCORDANCE WITH MANUFACTURER'S RECOMMENDATIONS UNLESS SPECIFICALLY INDICATED OTHERWISE, OR WHERE LOCAL CODES OR REGULATIONS TAKE PRECEDENCE.
- APPROVAL OF THESE PLANS BY THE CITY ENGINEER DOES NOT AUTHORIZE ANY WORK TO BE PERFORMED UNTIL A PERMIT HAS BEEN ISSUED.
- UPON ISSUANCE OF A PERMIT, NO WORK WILL BE PERMITTED ON WEEKENDS OR HOLIDAYS WITHOUT PERMISSION FROM THE ENGINEERING DEPARTMENT
- THE CONTRACTOR SHALL TAKE ALL PRECAUTIONARY MEASURES NECESSARY TO PROTECT FROM DAMAGING EXISTING IMPROVEMENTS WHICH ARE TO REMAIN IN PLACE. CONTRACTOR SHALL, AT HIS OWN EXPENSE, REPAIR, REPLACE OR RECONSTRUCT ALL SUCH IMPROVEMENTS OR OTHER STRUCTURES DAMAGED BY HIS WORK, TO THE ENGINEER'S SATISFACTION.
- THE CONTRACTOR SHALL BE RESPONSIBLE FOR SURVEY MONUMENTS AND/OR VERTICAL CONTROL BENCHMARKS WHICH ARE DISTURBED OR DESTROYED BY CONSTRUCTION. A LAND SURVEYOR MUST FILED LOCATE, REFERENCE, AND/OR PRESERVE ALL HISTORICAL OR CONTROLLING MONUMENTS PRIOR TO ANY EARTHWORK, IP DESTROYED, SUCH MONUMENTS SHALL BE REPLACED WITH APPROPRIATE MONUMENTS BY A LAND SURVEYOR A CORNER RECORD OF SURVEY, AS APPROPRIATE, SHALL BE FIELD AS REQUIRED BY THE PROFESSIONAL LAND SURVEYORS ACT. IF ANY VERTICAL CONTROL IS TO BE DISTURBED OR DESTROYED, THE JURISDICTION'S FIELD SURVEY DIVISION MUST BE NOTIFIED, IN WRITING, AT LEAST 3 DAYS FROM OCCURRENCE. THE CONTRACTOR WILL BE RESPONSIBLE FOR THE COST OF REPLACING ANY VERTICAL CONTROL BENCHMARKS DESTROYED BY THE CONSTRUCTION
- CONTRACTOR SHALL BE RESPONSIBLE FOR THE POTHOLE AND LOCATING OF ALL EXISTING UTILITIES THAT CROSS THE PROPOSE TRENCH LINE AND MUST MAINTAIN 1 FOOT MINIMUM VERTICAL
- DO NOT EXCAVATE OR DISTURB BEYOND THE PROPERTY LINES OR LEASE LINES, UNLESS OTHERWISE NOTED.
- CONTRACTOR SHALL REPLACE OR REPAIR ALL TRAFFIC SIGNAL CONSTRUCTION.

- 10. CONTRACTOR SHALL NOTIFY THE JURISDICTION A MINIMUM OF 48 HOURS PRIOR TO COMMENCING WORK WITHIN 10 FEET OF ALL SEWER, WATER, AND STORM DRAIN MAIN
- 11 "PUBLIC IMPROVEMENT SUBJECT TO DESUETUDE OR DAMAGE." IF REPAIR OR REPLACEMENT OF SUCH PUBLIC IMPROVEMENTS IS REQUIRED, THE OWNER SHALL OBTAIN THE REQUIRED PERMITS FOR WORK IN PUBLIC RIGHT-OF-WAY, SATISFACTORY TO THE PERMIT-ISSUING AUTHORITY.
- 12. THE CONTRACTOR SHALL MAKE ARRANGEMENTS FOR A PRE-CONSTRUCTION MEETING WITH THE CITY FIELD ENGINEERING DIVISION PRIOR TO ANY DISTURBANCE TO THE SITE, EXCLUDING UTILITY MARK-OUTS AND SURVEYING.
- 13. MANHOLES OR COVERS SHALL BE LABELLED "NAME OF COMPANY"
- 14. CONTRACTOR SHALL IMPLEMENT AN EROSION AND SEDIMENT CONTROL PROGRAM DURING THE PROJECT CONSTRUCTION ACTIVITIES. THE PROGRAM SHALL MEET THE APPLICABLE REQUIREMENTS OF THE STATE WATER RESOURCE CONTROL
- 15. THE CONTRACTOR SHALL HAVE EMERGENCY MATERIALS AND EQUIPMENT ON HAND FOR UNFORESEEN STUATIONS, SUCH AS DAMAGE TO UNDERGROUND WATER, SEWER, AND STORM DRAIN FACILITIES WHEREBY FLOWS MAY GENERATE EROSION AND SEDIMENT POLLUTION.
- 16. THE CONTRACTOR SHALL VERIEY LOCATION ALL EXISTING UNDERGROUND UTILITIES INCLUDING SEWER LATERALS & WATER SERVICES TO INDIVIDUAL LOTS OF BOTH VERTICAL AND HORIZONTAL PRIOR TO COMMENCING IMPROVEMENTS OPERATIONS.
- LOCATION AND ELEVATIONS OF IMPROVEMENTS, TO BE MET BY WORK, SHALL BE CONFIRMED BY FIELD MEASUREMENTS PRIOF TO CONSTRUCTION OF NEW WORK.
- 18. GRADES SHOWN ARE FINISH GRADES, CONTRACTOR SHALL
 DETERMINE NECESSARY SUB GRADE ELEVATIONS AND SHALL
 CONSTRUCT SMOOTH TRANSITION BETWEEN FINISH GRADES 19. THE CONTRACTOR SHALL SUBMIT WORK PLANS FOR ALL BORE
- OPERATIONS TWO WEEKS PRIOR TO COMMENCING WORK
- 20. THE CONTRACTOR SHALL BE TOTALLY RESPONSIBLE FOR COMPLIANCE WITH THE PROVISIONS OF THE STATE OF

- 21. CONTRACTOR AGREES THAT HE SHALL ASSUME SOLE
 RESPONSIBILITY FOR JOB SITE CONDITION DURING THE COURSE
 OF CONSTRUCTION OF THIS PROJECT, INCLUDING SAFETY OF ALL
 PERSONS AND PROPERTY; THAT THIS EQUIPMENT SHALL APPLY PERSONS AND PROPERTY: THAT THIS EQUIPMENT SHALL APPLY CONTINUOUSLY AND NOT BE LIMITED TO NORMAL WORKING HOURS; AND THAT THE CONTRACTOR SHALL DEFEND, INDEMNIFY AND HOLD THE OWNER AND THE ENGINEER HARMLESS FROM AND AND ALL LUABILITY, REAL OR ALLEGED IN CONNECTION WITH THE PERFORMANCE OF WORK ON THIS PROJECT, EXCEPTING FOR LIABILITY ARISING FROM SOLE NEGLIGENCE OF THE OWNER OR THE PROJECT, EXCEPTING FOR
- 22. THE LOCATIONS OF ALL EXISTING UTILITIES SHOWN ON THESE THE LOCATIONS OF ALL EXISTING UTILITIES SHOWN ON THESE PLANS ARE FROM EXISTING RECORDS AND CORROBORATED, WHERE POSSIBLE WITH FIELD TIES. THE CONTRACTOR IS RESPONSIBLE FOR CONFIRMING THE LOCATIONS SHOWN, BOTH HORIZONTALLY AND VERTICALLY PRIOR TO CONSTRUCTION. IF EXISTING LOCATIONS VARY SUBSTANTIALLY FROM THE PLANS, THE ENGINEER SHOULD BE NOTIFIED TO MAKE ANY CONSTRUCTION CHANGES REQUIRED.

THE ENGINEER.

- AS-BUILT DRAWINGS MUST BE SUBMITTED TO THE CITY ENGINEER PRIOR TO ACCEPTANCE OF THIS PROJECT.
- 24. ALL NEW AND EXISTING UTILITY STRUCTURES ON SITE AND IN AREAS TO BE DISTURBED BY CONSTRUCTION SHALL BE ADJUSTED TO FINISH ELEVATIONS PRIOR TO FINAL INSPECTION OF WORK.
- 25. ANY DRAIN AND/OR FIELD TILE ENCOUNTERED/DISTURBED DURING CONSTRUCTION SHALL BE RETURNED TO IT'S ORIGINAL CONDITION PRIOR TO COMPLETION OF WORK, SIZE, LOCATION AND TYPE OF ANY UNDERGROUND UTILITIES OR IMPROVEMENTS SHALL BE ACCURATELY NOTED AND PLACED ON "AS-BUILT" DRAWINGS BY GENERAL CONTRACTOR, AND ISSUED TO THE ARCHITECT OR ENGINEER AT COMPLETION OF PROJECT.
- 26. ALL TEMPORARY EXCAVATIONS FOR THE INSTALLATION OF FOUNDATIONS, UTILITIES, ETC., SHALL BE PROPERLY LAID BACK OR BRACED IN ACCORDANCE WITH THE CORRECT OCCUPATIONAL SAFETY AND HEALTH ADMINISTRATION (OSHA) REQUIREMENTS.







C 05/17/2019 SETBACK ADDED B 03/08/2019 100% CD'S SET A 01/30/2019 90% CD'S SET REV DATE DESCRIPTION

MAY 17, 2019

100% CD SET

LICENSURE: No. C 83930 Exp. 9-30-19

SOUTH CARMEL 001 LOCATION CODE: 428216

IFO A2 LOT 11 SAN ANTONIO AVE. CARMEL, CA 93923

TITLE SHEET

T-1

ACCESSIBILITY NOTE

HE FACILITY IS UNMANNED AND NOT FOR HUMAN HABITATION. HANDICAPPED ACCESS REQUIREMENTS ARE NOT REQUIRED IN ACCORDANCE WITH THE 2016 CALIFORNIA BUILDING CODE. A TECHNICIAN WILL VISIT THE SITE AS REQUIRED FOR ROUTINE MAINTENANCE. THE PROJECT WILL NO RESULT IN ANY SIGNIFICANT DISTURBANCE OR EFFECT ON DRAINGE; NO SANITARY SEWER SERVICE. POTABLE WATER, OR TRASH DISPOSAL IS REQUIRED AND NO COMMERCIAL SIGNAGE IS NEW.

THE TELECOMMUNICATIONS EQUIPMENT SPACE SHOWN ON THESE PLANS IS NOT CUSTOMARILY OCCUPIED. WORK TO BE PERFORMED IN THIS FACILITY CANNOT REASONABLY BE PERFORMED BY PERSONS WITH A SEVERE IMPAIRMENT: MOBILITY, SIGHT, AND/OR HEARING. THEREFORE, PER 2016 CALIFORNIA BUILDING CODE SECTION 1105B.3.4, AND/OR 11B-203.5 OF 2016 CALIFORNIA BUILDING CODE, EXCEPTION 1, THIS FACILITY SHALL BE EXEMPTED FROM ALL TITLE 24 ACCESS

DO NOT SCALE **DRAWINGS** SUBCONTRACTOR SHALL VERIEY ALL PLANS

WORK OR BE RESPONSIBLE FOR SAME. IF USING 11"X17" PLOT, DRAWINGS WILL BE HALF

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ABBREVIATIONS

AB AC A/C ADJ A.F.F. ARREDOX	ANCHOR BOLT ASPHALTIC CONCRETE AIR CONDITIONING ADJUSTABLE ABOVE FINISH FLOOR ARCHITECTURAL APPROXIMATELY	JT LAM LBS LT LA LNA	JOINT LAMINATED POUNDS LIGHT LIGHTNING ARRESTOR LOW NOISE AMPLIFIER
A.G.L. A.M.S.L.	ABOVE GRADE LEVEL ABOVE MEAN SEA LEVEL	MFR MAT MAX	MANUFACTURER MATERIAL MAXIMUM
BD BLDG BLKG BOT BSMT BTS	BOARD BUILDING BLOCKING BOTTOM BASEMENT BASE TRANSCEIVER STATION	MECH MIN MISC ML MO MS MTD MTL	MECHANICAL MINIMUM MISCELLANEOUS METAL LATH MASONRY OPENING MACHINE SCREW MOUNTED METAL
C CEM CL CLG CLR COL	COURSE(S) CEMENT CHAIN LINK CEILING CLEAR COLUMN	(N) NIC NO NTS	NEW NOT IN CONTRACT NUMBER NOT TO SCALE
CONC CONST CONT CORR CO	COLOMN CONCRETE CONSTRUCTION CONTINUOUS CORRIDOR CONDUIT ONLY	OA O.C. OPNG OPP	OVERALL ON CENTER OPENING OPPOSITE
00	CONDON ONLY	DARTN	DARTITION

PARTN

PL PLAS PLYWD POC PROP PT

R REQD RD RM RMS RO

SC SCHED SECT SHT SIM SPECS SS STL STOR STOR STUCT SUSP SW SWBO

THK TI

UNO

VCT VERT V.I.F. VG

XFMR

@

SYMBOLS:

DTL DWG

GA GALV

GYP GFCI

GND

HSS

HT HV

EXISTING

EVATION OUIPMENT

FACE OF STUDS FINISH SURFACE FOOT, FEET

FINISH WALL FINISH GRADE FUTURE

GAUGE GALVANIZED GLASS

GROUND

GROUND FAULT CIRCUIT

HOLLOW CORE
HARDWARE
HEATER
HOLLOW METAL
HORIZONTAL
HOUR
HOLLOW STRUCTURAL
SECTION
HEIGHT

HIGH VOLTAGE

INSIDE DIMENSION INSULATION INTERIOR

SECTION NUMBER

- SHEET NUMBER

- DETAIL NUMBER

- SHEET NUMBER

- SECTION NUMBER

- SHEET NUMBER

- DETAIL NUMBER

- SHEET NUMBER

— F— F— F—

----E/F----E/F---

\x-x

PARTITION

RISER REQUIRED ROOF DRAIN

ROOMS ROUGH OPENING

SOLID CORE SCHEDULE SECTION SHEET SIMILAR SPECIFICATIONS STAINLESS STEEL STEFI

TRUCTURAL SUSPENDED

SWITCHBOARD

UNLESS NOTED OTHERWISE

VERIFY IN FIELD VERTICAL GRAIN

TRANSFORMER

CHANNEL

ANGLE PROPERTY LINE

BUILDING SECTION REFERENCE

DETAIL REFERENCE

DETAIL SECTION

EXTERIOR FLEVATION

REFERENCE

REFERENCE

FENCING

PROPERTY LINE

FLECTRICAL SERVICE

ELECTRICAL/FIBER SERVICE

FIBER SERVICE

CENTERLINE

ΑT

THICK
TENANT IMPROVEMENT
TOWER MOUNTED AMPLIFIER
TOP OF SURFACE
TUBE STEEL
TYPICAL

VINYL COMPOSITION TILE VERTICAL

RESISTANT

PLYWOOD POINT OF CONNECTION PROPERTY PRESSURE TREATED

- WILL HAVE WORKED AT HIS/HER OWN HISH AND EXPENSE.

 CONTRACTOR SHALL DETERMINE ACTUAL ROUTING OF CONDUIT, POWER, T1 OR FIBER CABLES, GROUNDING CABLES AS SHOWN ON THE POWER, GROUNDING AND TELCO PLAN DRAWING. CONTRACTOR SHALL UNILIZE EXISTING TRAYS AND/OR SHALL ADD NEW TRAYS AS NECESSARY. CONTRACTOR SHALL CONTRINE THE ACTUAL ROUTING WITH THE CONTRACTOR. ROUTING OF TRENCHING SHALL BE APPROVED BY CONTRACTOR ALL MATERIALS AND CONSTRUCTION SHALL BE IN CONFORMANCE WITH THE BUILDING CODE AND ALL OTHER GOVERNING CODES. THESE NOTES SHALL BE CONSIDERED A PART OF THE WRITTEN SPECIFICATIONS.
 - THE CONTRACTOR SHALL NOTIFY ARCHITECT/ENGINEER OF ANY ERRORS, OMISSIONS, OR DISCREPANCIES AS THEY MAY BE DISCOVERED IN THE PLANS, SPECIFICATIONS, & NOTES PRIOR TO STARTING CONSTRUCTION, INCLUDING BUT NOT LIMITED BY DEMOLITION. THE CONTRACTOR SHALL BE RESPONSIBLE FOR CORRECTING ANY ERROR, OMISSION, OR INCONSISTENCY AFTER THE START OF CONSTRUCTION WHICH HAS NOT OMISSION, ON INCOMPRISED A TEATH OF CONTROLLING MINISTRUS MINISTRUS MEETING METHOD OF THE ARCHITECT/ENGINEER AND SHALL INCUR ANY EXPENSES TO RECTIFY THE SITUATION. THE METHOD OF CORRECTION SHALL BE APPROVED BY THE ARCHITECT/ENGINEER.

. PLANS ARE INTENDED TO BE DIAGRAMMATIC OUTLINE ONLY, UNLESS NOTED OTHERWISE.
THE WORK SHALL INCLUDE FURNISHING MATERIALS, EQUIPMENT, APPURTENANCES AND
LABOR NECESSARY TO COMPLETE ALL INSTALLATIONS AS INDICATED ON THE DRAWINGS.

LABOR NECESSARY TO COMPLETE ALL INSTALLATIONS AS INDICATED ON THE DRAWINGS.

2. ALL EXISTING UTILITIES, FACILITIES, CONDITIONS, AND THEIR DIMENSIONS SHOWN ON THE PLAN HAVE BEEN PLOTTED FROM AVAILABLE RECORDS. THE ARCHITECT/ENGINEER AND THE OWNER ASSUME NO RESPONSIBILITY WHATSOEVER AS TO THE SUFFICIENCY OR THE ACCURACY OF THE INFORMATION SHOWN ON THE PLANS, OR THE MANNER OF THEIR REMOVAL, OR ADJUSTMENT. CONTRACTORS SHALL BE RESPONSIBLE FOR DETERMINING EXACT LOCATION OF ALL EXISTING UTILITIES AND FACILITIES PRIOR TO START OF CONSTRUCTION. CONTRACTORS SHALL ALSO OBTAIN FROM EACH UTILITY COMPANY DETAILED INFORMATION RELATIVE TO WORKING SCHEDULES AND METHODS OF REMOVING OR ADJUSTING EXISTING UTILITIES. ANY DISCREPANCIES OR DOUBTS AS TO THE INTERPRETATION OF PLANS SHOULD BE IMMEDIATELY REPORTED TO THE ARCHITECT/ENGINEER FOR RESOLUTION AND INSTRUCTION. AND NO FURTHER WORK

ARCHITECT/ENGINEER FOR RESOLUTION AND INSTRUCTION, AND NO FURTHER WORK SHALL BE PERFORMED UNTIL THE DISCREPANCY IS CHECKED AND CORRECTED BY THE ARCHITECT/ENGINEER. FALUER TO SECURE SUCH INSTRUCTION MEANS CONTRACTOR WILL HAVE WORKED AT HIS/HER OWN RISK AND EXPENSE.

- APPROVED BY THE ARCHITECT/ENGINEER.
 PRIOR TO STARTING CONSTRUCTION THE CONTRACTOR HAS THE RESPONSIBILITY TO LOCATE ALL EXISTING UTILITIES, WHETHER OR NOT SHOWN ON THE PLANS, AND TO PROTECT THEM FROM DAMAGE. THE CONTRACTOR OR SUBCONTRACTOR SHALL BEAR THE EXPENSE OF REPARING OR REPLACING ANY DAMAGE TO THE UTILITIES CAUSED DURING THE EXECUTION OF THE WORK. WHERE REQUIRED FOR THE PROPER EXECUTION OF THE WORK, UTILITIES SHALL BE RELOCATED AS DIRECTED BY ENGINEERS. EXTREME CAUTION SHOULD BE USED BY THE CONTRACTOR WHEN EXCAVATING OR PIER DRILLING AROUND OR NEAR UTILITIES. CONTRACTOR SHALL PROVIDE SAFETY TRAINING FOR THE WORKING CREW.
- ALL EXISTING INACTIVE SEWER, WATER, GAS, ELECTRIC AND OTHER UTILITIES, WHICH INTERFERE WITH THE EXECUTION OF THE WORK, SHALL BE REMOVED AND SHALL BE CAPPED, PLUGGED OR OTHERWISE DISCONTINUED AT POINTS WHICH WILL NOT INTERFERE WITH THE EXECUTION OF THE WORK, SUBJECT TO THE APPROVAL OF THE
- ENGINEER.

 8. A COPY OF THE APPROVED PLANS SHALL BE KEPT IN A PLACE SPECIFIED BY THE GOVERNING AGENCY, AND BY LAW SHALL BE AVAILABLE FOR INSPECTION AT ALL TIMES. IT IS THE CONTRACTOR'S RESPONSIBILITY TO ENSURE ALL CONSTRUCTION SET REFLECT THE SAME INFORMATION AS THE APPROVED PLANS. THE CONTRACTOR SHALL ALSO MAINTAIN ONE SET OF PLANS AT THE SITE FOR THE PURPOSE OF DOCUMENTING ALL AS—BULLT (FANNES, REVISIONS, ADDEDNUMS, OR CHANGE ORDERS. THE CONTRACTOR SHALL FORWARD THE AS—BULLT/HIRED DRAWINGS TO THE ARCHITECT/ENGINEER AT THE CONCLUSION OF THE PROJECT.
- 9. THE CONTRACTOR SHALL BE RESPONSIBLE FOR THE COMPLETE SECURITY OF THE SITE WHILE THE WORK IS IN PROGRESS UNTIL THE JOB IS COMPLETE.
- THE CONTRACTOR IS RESPONSIBLE TO PROVIDE TEMPORARY POWER, WATER, AND TOILET FACILITIES AS REQUIRED BY THE PROPERTY OWNER OR GOVERNING AGENCY.

 THE CONTRACTOR SHALL BE RESPONSIBLE FOR COMPLYING WITH ALL SAFETY PRECAUTIONS AND REGULATIONS DURING THE WORK. THE ENGINEER WILL NOT ADVISE ON, NOR PROVIDE DIRECTION, AS TO SAFETY PRECAUTIONS AND PROGRAMS.
- THE CONTRACTOR IS SOLELY RESPONSIBLE FOR ALL CONSTRUCTION MEANS, METHODS, TECHNIQUES, PROCEDURES, SEQUENCING, AND COORDINATING ALL PORTIONS OF THE WORK UNDER THE PROJECT. FURTHERMORE, THE STRUCTURE IS DESIONED AS A UNIT UPON COMPLETION. THE CONTRACTOR IS RESPONSIBLE FOR FURNISHING ALL TEMPORARY BRACING AND/OR SUPPORT THAT MAY BE REQUIRED AS THE RESULT OF THE CONTRACTOR'S CONSTRUCTION METHODS. THE INVESTIGATION, DESIGN, SAFETY, DEQUACY AND INSPECTION OF BRACING, SHORING, TEMPORARY SUPPORTS, ETC. IS HE SOLE RESPONSIBILITY OF THE CONTRACTOR.
- 13. THE CONTRACTOR SHALL BE RESPONSIBLE TO OBTAIN AND PAY FOR ALL PERMITS, LICENSES AND INSPECTIONS WITH RESPECT TO THE WORK TO COMPLETE THE PROJECT. BUILDING PERMIT APPLICATIONS SHALL BE FILED BY THE OWNER OR HIS REPRESENTATIVE. CONTRACTOR SHALL OBTAIN THE PERMIT AND MAKE FINAL PAYMENT OF SAID DOCUMENT(S).
- 14. ALL DIMENSIONS TAKE PRECEDENCE OVER SCALE UNLESS OTHERWISE NOTED.
- THE CONTRACTOR SHALL PROVIDE ALL NECESSARY FRAMING, BACKING, HANGERS, BLOCKING OR SUPPORTS FOR INSTALLATION OF ITEMS INDICATED ON THE DRAWINGS.
- NEW CONSTRUCTION ADDED TO EXISTING CONSTRUCTION SHALL BE MATCHED IN FORM, TEXTURE, MATERIAL AND PAINT COLOR EXCEPT AS NOTED IN THE PLANS.
- WHERE SPECIFIED, MATERIALS TESTING SHALL BE TO THE LATEST STANDARDS AVAILABLE AS REQUIRED BY THE LOCAL GOVERNING AGENCY RESPONSIBLE FOR RECORDING THE RESULTS.
- ALL GENERAL NOTES AND STANDARD DETAILS ARE THE MINIMUM REQUIREMENTS TO BE USED IN CONDITIONS WHICH ARE NOT SPECIFICALLY SHOWN OTHERWISE.
- 19. ALL SYMBOLS AND ABBREVIATIONS ARE CONSIDERED CONSTRUCTION INDUSTR STANDARDS, IF A CONTRACTOR HAS A QUESTION REGARDING THEIR EXACT MEANING. THE ARCHITECT/ENGINEER SHALL BE NOTIFIED FOR CLARIFICATIONS.
- CONTRACTORS SHALL VISIT THE SITE PRIOR TO BID TO ASCERTAIN CONDITIONS WHICH MAY ADVERSELY AFFECT THE WORK OR COST THEREOF.
- 21. THE CONTRACTOR SHALL FIELD VERIFY THE DIMENSIONS, ELEVATIONS, ETC. NECESSARY FOR THE PROPER CONSTRUCTION AND ALIGNMENT OF THE NEW PORTION OF THE WORK TO THE EXISTING WORK.
- 22. REPRESENTATIONS OF TRUE NORTH, OTHER THAN THOSE FOUND ON THE PLOT OF SURVEY DRAWING (SHEET LS1), SHALL NOT BE USED TO IDENTIFY OR ESTABLISH THE BEARING OF TRUE NORTH AT THE SITE. THE CONTRACTOR SHALL RELY SOLELY ON THE PLOT OF SURVEY DRAWING AND ANY SURVEYOR'S MARKINGS AT THE SITE FOR THE PLOT OF SURVEY DRAWING AND ANY SURVEYOR'S MARKINGS AT THE STIE FOR THE ESTABLISHMENT OF TRUE NORTH, AND SHALL NOTIFY THE ARCHITECT/ ENGINEER PRIOR TO PROCEEDING WITH THE WORK. IF ANY DISCREPANCY IS FOUND BETWEEN THE VARIOUS ELEMENTS OF THE WORKING DRAWINGS AND THE TRUE NORTH ORIENTATION AS DEPICTED ON THE CIVIL SURVEY, THE CONTRACTOR SHALL ASSUME SOLE LIABILITY FOR ANY FAILURE TO NOTIFY THE ARCHITECT/ENGINEER.
- 23. NO CHANGES ARE TO BE MADE TO THESE PLANS WITHOUT THE KNOWLEDGE AND NO CHANGES ARE 10 BE MADE TO THESE PLANS WITHOUT THE KNOWLEDGE AND WRITTEN CONSENT OF THE ARCHITECT/ ENGINEER. UNAUTHORIZED CHANGES RENDER THESE DRAWINGS VOID. THIS INCLUDES THAT THE CONTRACTOR SHALL NOT BE RELIEVED OF ANY DEVIATION FROM THE PLANS BY THE PROFESSIONAL'S OF RECORD REVIEW OF SHOP DRAWINGS, PRODUCT DATA, ETC. UNLESS THE CONTRACTOR HAS SPECIFICALLY INFORMED THE PROFESSIONAL OF RECORD OF SUCH DEVIATION IN WRITING AT THE TIME OF SUBMISSION, AND THE PROFESSIONAL OF RECORD HAS GIVEN WRITTEN APPROVAL TO THE SPECIFIC DEVIATION.
- 24. ANY REFERENCE TO THE WORDS "APPROVED" OR "APPROVAL" IN THESE DOCUMENTS SHALL BE HERE DEFINED TO MEAN CENERAL ACCEPTANCE OR REVIEW AND SHALL NOT RELIEVE THE CONTRACTOR AND/OR HIS SUB-CONTRACTORS OF ANY LIABILITY IN FURNISHING THE REQUIRED MATERIALS OR LABOR SPECIFIED.
- 25. KEEP GENERAL AREA CLEAN, HAZARD FREE, AND DISPOSE OF ALL DIRT, DEBRIS, RUBBISH AND REMOVE EQUIPMENT NOT SPECIFIED AS REMAINING ON THE PROPERTY. LEAVE PREMISES IN CLEAN CONDITION AND FREE FROM PAINT SPOTS, DUST OR SMUDGES OF ANY NATURE

CONTRACTOR NOTES: **EQUIPMENT LOCATION**

- THE DRAWINGS INDICATE DIAGRAMMATICALLY THE DESIRED LOCATIONS OR ARRANGEMENTS OF CONDUIT RUNS, OUTLETS, EQUIPMENT, ETC., AND ARE TO BE FOLLOWED AS CLOSELY AS POSSIBLE. PROPER DIDDEGMENT MUST BE EXERCISED IN EXECUTING THE WORK SO AS TO SECURE THE BEST POSSIBLE INSTALLATION IN THE AVAILABLE SPACE LIMITATIONS OR INTERFERENCE OF STRUCTURE CONDITIONS
- ENCOUNTERED.

 IN THE EVENT CHANGES IN THE INDICATED LOCATIONS OR ARRANGEMENTS ARE NECESSARY, DUE TO FIELD CONDITIONS IN THE BUILDING CONSTRUCTION OR REARRANGEMENT OF FURNISHINGS OR EQUIPMENT, SUCH CHANGES SHALL BE MADE WITHOUT COST, PROVIDING THE CHANGE IS ORDERED BEFORE THE CONDUIT RUNS, ETC., AND WORK DIRECTLY CONNECTED TO THE SAME IS INSTALLED AND NO EXTRA MATERIALS ARE REQUIRED.
- 3. COORDINATE THE WORK OF THIS SECTION WITH THAT OF ALL OTHER TRADES, WHERE CONFLICTS OCCUR, CONSULT WITH THE RESPECTIVE CONTRACTOR AND COME TO AGREEMENT AS TO CHANGES NECESSARY, OBTAIN WRITTEN ACCEPTANCE FROM ENGINEER FOR THE PROPOSED CHANGES BEFORE

UTILITY SERVICE

- TELEPHONE AND ELECTRICAL METERING FACILITIES SHALL CONFORM TO THE
 REQUIREMENTS OF THE SERVING UTILITY COMPANIES. CONTRACTOR SHALL VERIFY SERVICE
 LOCATIONS AND REQUIREMENTS. SERVICE INFORMATION WILL BE FURNISHED BY THE SERVING UTILITIES.
- 2. CONFORM TO ALL REQUIREMENTS OF THE SERVING UTILITY COMPANIES








C 05/17/2019 SETBACK ADDED B 03/08/2019 100% CD'S SET A 01/30/2019 90% CD'S SET REV DATE DESCRIPTION

ISSUED DATE:

MAY 17, 2019

ISSUED-FOR: -

100% CD SET

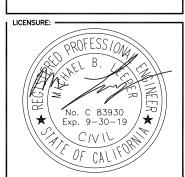

PROJECT INFORMATION:

SOUTH CARMEL 001 LOCATION CODE: 428216

IFO A2 LOT 11 SAN ANTONIO AVE. CARMEL, CA 93923

DRAWN BY SAG CHECKED BY

SHEET-TITLE:

NOTES AND **SPECIFICATIONS**

SHEET-NUMBER:


T-2



NOTES:

1. THIS IS NOT A BOUNDARY SURVEY. THIS IS A SPECIALIZED TOPOGRAPHIC MAP. THE PROPERTY LINES AND EASEMENTS SHOWN HEREON ARE FROM RECORD INFORMATION AS NOTED HEREON. CELLISTE CONCEPTS TRANSLATED THE TOPOGRAPHIC SURVEY TO RECORD INFORMATION USING FOUND MONUMENTS SHOWN HEREON. THE LOCATION OF PROPERTY LINES SHOWN HEREON ARE APPROXIMATE AND FOR INFORMATIONAL PURPOSES ONLY. THEY ARE NOT TO BE RELIED UPON AS THE ACTUAL BOUNDARY LINES.

- ANY CHANGES MADE TO THE INFORMATION ON THIS PLAN, WITHOUT THE WRITTEN CONSENT OF CELLSITE CONCEPTS, RELIEVES CELLSITE CONCEPTS OF ANY AND ALL LIABILITY.
- 3. THE HEIGHTS AND ELEVATIONS FOR THE TREES, BUSHES AND OTHER LIVING PLANTS SHOWN HEREON, SHOULD BE CONSIDERED APPROXIMATE (+/-) AND ONLY FOR THE DATE OF THIS SURVEY. THEY ARE PROVIDED AS A GENERAL REFERENCE AND SHOULD NOT BE USED FOR DESIGN
- 4. RIGHT-OF-WAY WAS ESTABLISHED BY LOCATING FOUND CENTERLINE CITY OR COUNTY MONUMENTS. IF CENTERLINE MONUMENTS WERE NOT LOCATABLE, THE CENTERLINE OFFSET TIES WERE USED TO ESTABLISH THE INTERSECTIONS. IF NEITHER CENTERLINE TIES OR CENTERLINE INTERSECTION MONUMENTS WERE LOCATABLE, EXISTING IMPROVEMENTS WERE USED TO ESTABLISH
- 5. ALL SHOWN RIGHT-OF-WAY WERE BASED UPON RESEARCH AT COUNTY OR CITY FILES AND REFLECT THE LATEST RECORDED MAPS, RECORDS OF SURVEY, PARCEL MAPS OR OTHER RECORDS. RIGHT-OF-WAY WILL NOT REFLECT ANY DEDICATION, TAKEN OR OFFERED AFTER THE THE RECORD MAP USED. ALL SURVEYS WERE COMPLETED WITHOUT THE BENEFIT OF A CURRENT TITLE REPORT AND MAY NOT SHOW ADDITIONAL DEDICATIONS NOT SHOWN ON THE RECORD MAPS USED.
- 6. WRITTEN DIMENSIONS SHALL TAKE PREFERENCE OVER SCALED & SHALL BE VERIFIED ON THE JOB SITE. ANY DISCREPANCY SHALL BE BROUGHT TO THE NOTICE OF THE SURVEYOR PRIOR TO COMMENCEMENT OF ANY WORK.

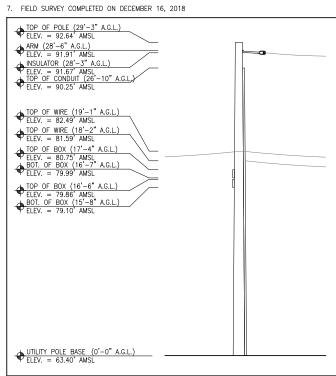

BASIS OF BEARING


THE CENTERLINE OF SAN ANTONIO AVE. BEARING $500^{\circ}00^{\circ}00^{\circ}W$ WAS USED AS BASIS OF BEARING FOR THIS SURVEY.

BASIS OF ELEVATIONS: (NAVD 1988)

ELEVATIONS ARE BASED ON CALVRS G.P.S. BROADCAST COORDINATE VALUES FOR 2017, NAVD $88\,$

FLOOD ZONE

SITE IS LOCATED IN FLOOD ZONE "X" AS PER F.I.R.M. MAP NO. 06053C0316H EFFECTIVE DATE 06/21/2017

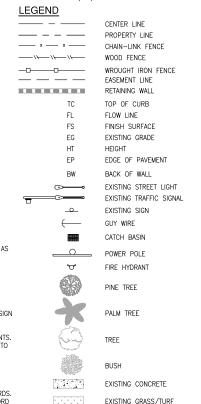

MONUMENTS


R.O.S. NO. 33-98 R.O.S. NO. 25-06

LATITUDE: 36'33'00.26" N (36.550072) LONGITUDE: 121'55'40.43" W (-121.92789)

DATED FEBRUARY 14, 2018 DATED SEPTEMBER 06, 2001

DATED APRIL 22, 1999

MONUMENT FD.

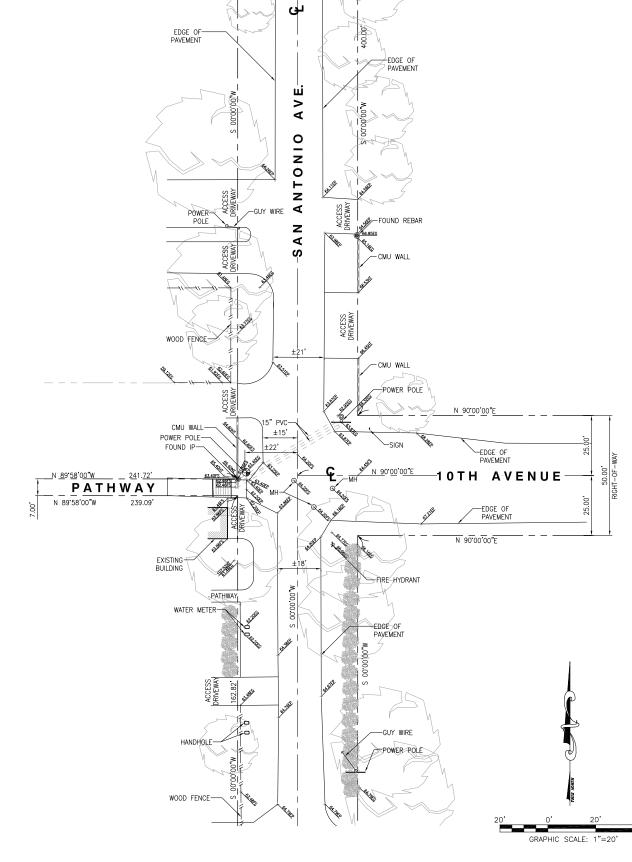

50.00 RIGHT-OF-WAY







1 12/20/2018 FINAL SURVEY REV DATE DESCRIPTION

DECEMBER 20, 2018

ISSUED FOR: -

ISSUED DATE:

FINAL SURVEY

LICENSURE: L.S. 8780 Exp. 12/31/20

SOUTH CARMEL 001 LOCATION CODE: 428216 IFO A2 LOT 11 SAN ANTONIO AVE. CARMEL, CA 93923


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SHEET-TITLE:


TOPOGRAPHIC SURVEY

SHEET-NUMBER:

LS-1

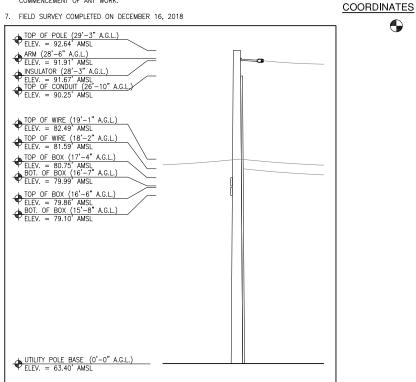

UTILITY POLE PROFILE

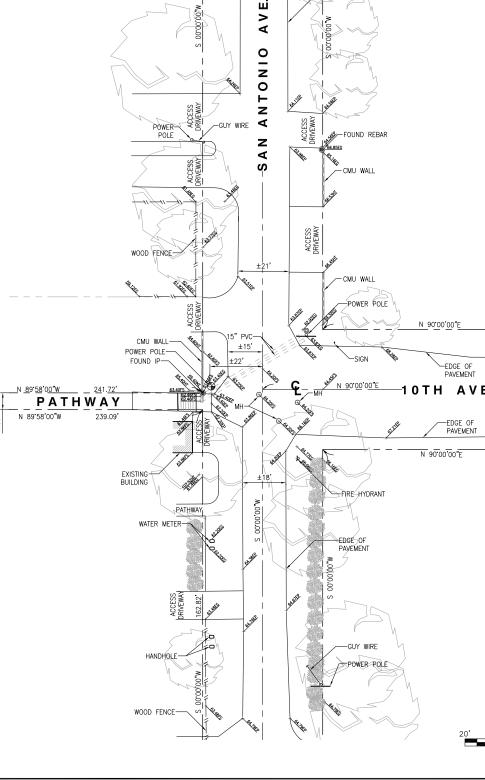


SITE NOTES:

- 1. REPRESENTATIONS OF TRUE NORTH, OTHER THAN THOSE FOUND ON THE PLOT OF SURVEY DRAWINGS SHALL NOT BE USED TO IDENTIFY OR ESTABLISH BEARING OF TRUE NORTH AT THE SITE. THE CONTRACTOR SHALL RELY SOLELY ON THE PLOT OF SURVEY DRAWING AND ANY SURVEYOR'S MARKINGS AT THE SITE FOR THE ESTABLISHMENT OF TRUE NORTH, AND SHALL NOTIFY THE ARCHITECT/ENGINEER PRIOR TO PROCEEDING WITH THE WORK IF ANY DISCREPANCY IS FOUND BETWEEN THE VARIOUS ELEMENTS OF THE WORKING PAWNINGS AND THE TRUE NORTH ORIENTATION AS DEPICTED ON THE CIVIL SURVEY. THE CONTRACTOR SHALL ASSUME SOLE LIABILITY FOR ANY FAILURE TO NOTIFY THE ARCHITECT/ ENGINEER.
- 2. CONTRACTOR TO VERIFY LOCAL UTILITY REQUIREMENTS FOR DEPTH, SIZES, AND SEPARATION OF CONDUITS PRIOR TO INSTALLATION. NOTIFY CONSTRUCTION MANAGER IMMEDIATELY OF ANY DISCREPANCIES.
- 3. PROPOSED UTILITY SERVICES SHOWN NEED TO BE VERIFIED AND APPROVED BY UTILITY COMPANIES BEFORE START OF CONSTRUCTION. CONTRACTOR TO VERIFY WITH CLIENT PROJECT MANAGER TO OBTAIN FINAL APPROVAL.
- 4. VERIFY, LOCATE, AND PROTECT ALL EXISTING SUBSTRUCTURES AS REQUIRED, CALL DIG ALERT ® (800) 227–2600 48 HOURS BEFORE ANY EXCAVATION. CONTRACTOR IS RESPONSIBLE TO HAVE ALL NON-PUBLIC UTILITIES LOCATED AT THEIR OWN EXPENSE.
- CONTRACTOR SHALL IMMEDIATELY INFORM CLIENT OF ANY ACCIDENTAL DAMAGE TO EXISTING UTILITIES VA PHONE OR EMAIL REGARDLESS OF ABILITY TO REPAIR OR MITIGATE. A FOLLOW-UP EMAIL REPORT WITH DIGITAL PHOTOS WILL BE REQUIRED DAILY UNTIL RESOLUTION HAS BEEN ACCEPTED BY CLIENT, AFFOCTED SERVICE PROVIDERS, AND RECIPIENTS. AT THEIR OWN EXPENSE, CONTRACTOR WILL EXERCISE ALL EFFORTS TO HAVE REPAIRS MADE BY QUALIFIED TECHNICIANS AS APPROVED BY SERVICE PROVIDER.
- REPAIRS MADE BY QUALIFIED TECHNICIANS AS APPRIVED BY SERVICE PROVIDER.

 6. CONTRACTOR SHALL VERIETY ALL EXISTING UTILITIES, BOTH HORIZONTAL AND VERTICALLY, PRIOR TO THE START OF CONSTRUCTION. ANY DISCREPANCIES OR DOUBTS AS TO THE INTERPERTATION OF PLANS SHOULD BE IMMEDIATELY REPORTED TO THE ARCHITECT/ENGINEER FOR RESOLUTION AND INSTRUCTION, AND NO FURTHER WORK SHALL BE REFORMED UNTIL THE DISCREPANCY IS CHECKED AND CORRECTED BY THE ARCHITECT/ENGINEER, FAILURE TO SECURE SUCH INSTRUCTION MEANS CONTRACTOR WILL HAVE WORKED AT HIS/HER OWN RISK AND EXPENSE.
- ALL NEW AND EXISTING UTILITY STRUCTURES ON SITE AND IN AREAS TO BE DISTURBED BY CONSTRUCTION SHALL BE ADJUSTED TO FINISH ELEVATIONS PRIOR TO FINAL INSPECTION OF WORK.
- 8 ANY DRAIN AND YOR FIELD THE ENCOUNTERED/DISTURBED DURING CONSTRUCTION SHALL ANT DRAIN AND TOR FIELD THE ENCOUNTERCY DISTORBED UNRING CONSIDERING THE BE RETURNED TO IT'S ORIGINAL CONDITION PRIOR TO COMPLETION OF WORK, SIZE, LOCATION AND TYPE OF ANY UNDERGROUND UTILITIES OR IMPROVEMENTS SHALL BE ACCURATELY NOTED AND PLACED ON "AS-BUILT" DRAWINGS BY GENERAL CONTRACTOR, AND ISSUED TO THE ARCHITECT OR ENGINEER AT COMPLETION OF PROJECT.
- ALL TEMPORARY EXCAVATIONS FOR THE INSTALLATION OF FOUNDATIONS, UTILITIES, ETC., SHALL BE PROPERLY LAID BACK OR BRACED IN ACCORDANCE WITH THE CORRECT OCCUPATIONAL SAFETY AND HEALTH ADMINISTRATION (OSHA) REQUIREMENTS.
- 10. NEW CONDUITS SHALL BE INSTALLED IN TRENCH SUCH THAT THE TOP OF CONDUIT SHALL HAVE A MINIMUM COVER OF 30-INCHES BELOW ADJACENT EDGE OF PAVEMENT OR ORIGINAL GROUND, WHICHEVER IS LOWER IN ELEVATION.
- ALL PULL BOXES SHALL BE PRECAST REINFORCED CONCRETE AND HAVE NON CONDUCTIVE LIDS. EXISTING PULL BOX COVERS THAT ARE MARKED INCORRECTLY SHALL BE REPLACED.
- 12. REGRADE LANDSCAPING AS NEEDED AND REPLACE DAMAGED IRRIGATION LINES WITHIN



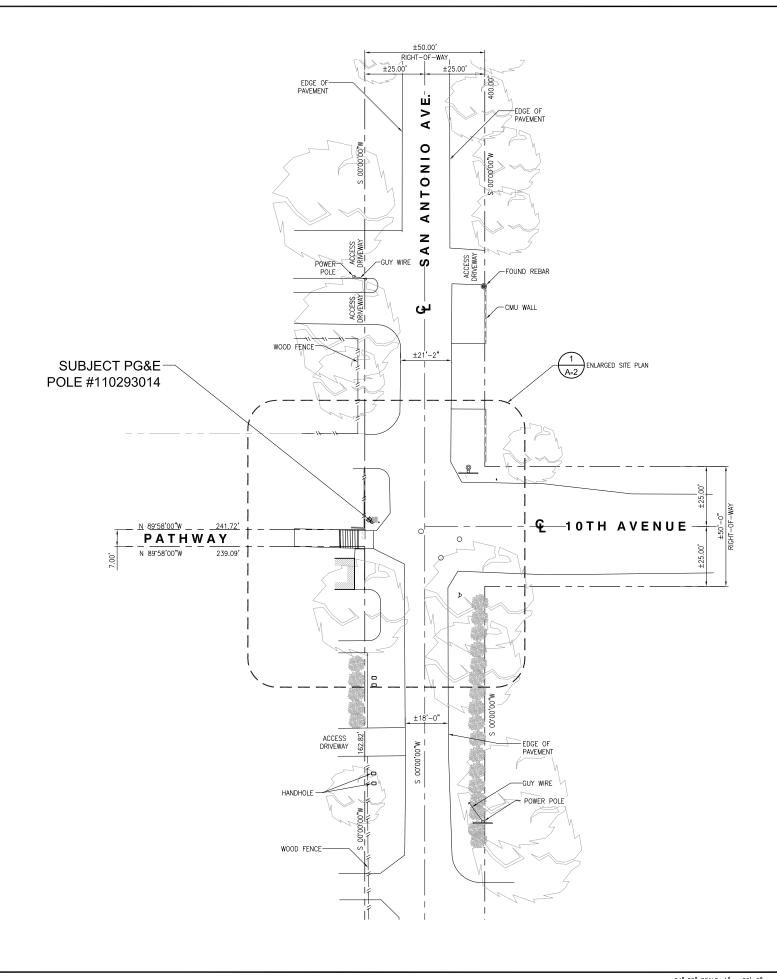







10650 SCRIPPS RANCH BLVD., SUITE 224 SAN DIEGO, CA 92131 tel: (858) 433-7173 / (858) 433-7176

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П			
	С	05/17/2019	SETBACK ADDED
	В	03/08/2019	100% CD'S SET
	A	01/30/2019	90% CD'S SET
П	REV	DATE	DESCRIPTION

ISSUED DATE: -

MAY 17, 2019

ISSUED FOR: -

100% CD SET

LICENSURE: 뮏 No. C 83930 (* \ Exp. 9 - 30 - 19

PROJECT INFORMATION:

SOUTH CARMEL 001 LOCATION CODE: 428216 IFO A2 LOT 11 SAN ANTONIO AVE.,

CARMEL, CA 93923

DRAWN BY: CHECKED BY:

SHEET TITLE: -

SITE PLAN

SHEET NUMBER:

A-1

SITE PLAN


11"x17" SCALE: 1" = 40'-0"


24"x36" SCALE: 1" = 20'-0"

UNDERGROUND UTILITIES NOTE:

ENLARGED SITE PLAN

UNDERGROUND UTILITIES NOTE:
ALL EXISTING SUB-SURFACE UTILITIES, FACILITIES, CONDITIONS, AND THEIR
DIMENSIONS SHOWN ON THE PLAN HAVE BEEN PLOTTED FROM FIELD SURVEY
AND/OR AVAILABLE RECORDS, THE ARCHITECT/ ENGINEER AND THE OWNER
ASSUME NO RESPONSIBILITY WHATSOEVER AS TO THE SUFFICIENCY OR THE
ACCURACY OF THE INFORMATION SHOWN ON THE PLANS, OR THE MANNER OF
THEIR REMOVAL OR ADJUSTMENT. CONTRACTORS SHALL BE RESPONSIBLE FOR
THEIR DETERMINING EXACT LOCATION OF ALL EXISTING UTILITIES AND FACILITIES
PRIOR TO START OF CONSTRUCTION. CONTRACTORS SHALL ALSO DETAIN FROM
EACH UTILITY COMPANY DETAILED INFORMATION RELATIVE TO WORKING
SCHEDULES AND METHODS OF REMOVING OR ADJUSTING EXISTING UTILITIES.
THERE MAY BE EXISTING UTILITIES OFTHER THAN THOSE SHOWN ON THIS PLAN.
THE CONTRACTOR IS REQUIRED TO TAKE PRECAUTIONARY MEASURES TO
PROTECT THE UTILITY LINE SHOWN AND ANY OTHER LINES NOT SHOWN ON
THIS PLAN.

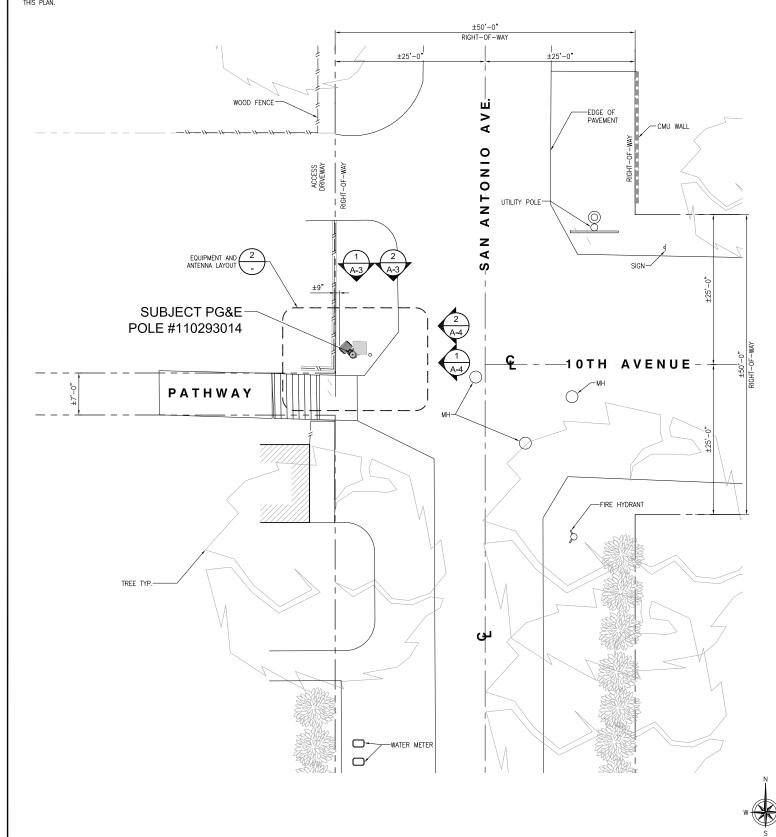

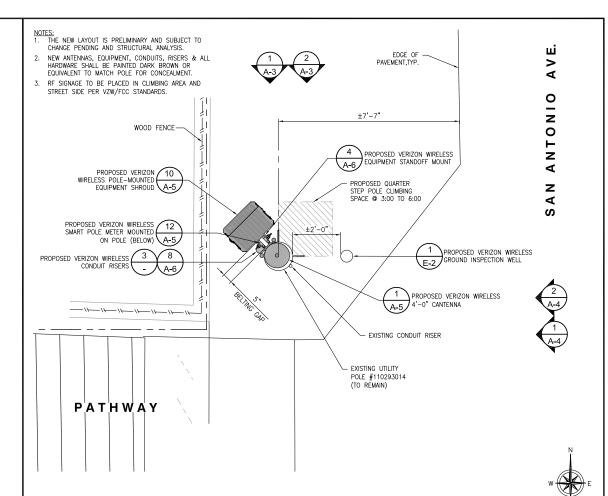

EQUIPMENT AND ANTENNA LAYOUT

24"x36" SCALE: 1/2" = 1'-0" 11"x17" SCALE: 1/4" = 1'-0"

2

ISSUED FOR: -

ISSUED DATE:

REV

100% CD SET

MAY 17, 2019

DESCRIPTION

DEPLOYMENT SERVICES, INC. 22471 ASPAN STREET, STE 290 LAKE FOREST, CA 92630

10650 SCRIPPS RANCH BLVD., SUITE 224 SAN DIEGO, CA 92131 tel: (858) 433-7173 / (858) 433-7176

C 05/17/2019 SETBACK ADDED

B 03/08/2019 100% CD'S SET

A 01/30/2019 90% CD'S SET

DATE

LICENSURE: No. C 83930 Exp. 9-30-19

SOUTH CARMEL 001 LOCATION CODE: 428216

FO A2 LOT 11 SAN ANTONIO AVE., CARMEL, CA 93923

DRAWN BY:

ENLARGED SITE PLAN AND EQUIPMENT ANTENNA LAYOUT


A-2

EXISTING POLE INFORMATION

POLE HEIGHT: 35 FT MATERIAL: POLE CLASS: UNKN YEAR SET: 2011

MAKE-READY SCOPE:

- 1. VERIZON TO INSTALL (1) SMART POLE METER ON STANDOFF MOUNT AT 1:30 POSITION.
- VERIZON TO INSTALL (1) DISTRIBUTION PANEL AND DISCONNECT SWITCH ON STANDOFF MOUNT AT 1:30 POSITION.
- VERIZON TO INSTALL (1) EQUIPMENT SHROUD ON STANDOFF MOUNT AT 1:30 POSITION.
- 4. VERIZON TO INSTALL (1) 4FT ANTENNA ON TOP OF PROPOSED 7'-0" HIGH POLE EXTENSION. VERIZON TO INSTALL 2" SCHEDULE 80 PVC POWER RISER MOUNTED ON CONDUIT STANDOFF AT 2:30 POSITION FROM
- SERVICE DROP TO METER. VERIZON TO INSTALL 4" SCHEDULE 80 PVC HYBRID RISER MOUNTED ON CONDUIT STANDOFF AT 12:30 POSITION FROM RRUS TO ANTENNA.
- INSTALL 2" SCHEDULE 80 PVC FIBER RISER MOUNTED ON CONDUIT STANDOFF AT 12:00 POSITION FROM SERVICE DROP TO EQUIPMENT CABINET.
- 8. VERIZON TO STEP POLE @ 3:00 TO 6:00

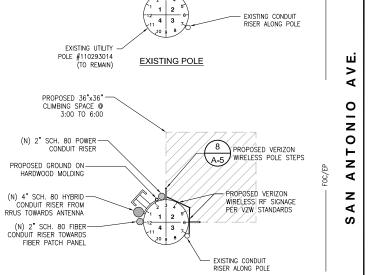


PROPOSED POLE

MAKE READY

8' 6' 4' 2' 0"

24"x36" SCALE: 1/8" = 1'-0" 11"x17" SCALE: 1/16" = 1'-0"


24"x36" SCALE: NTS 11"x17" SCALE: NTS

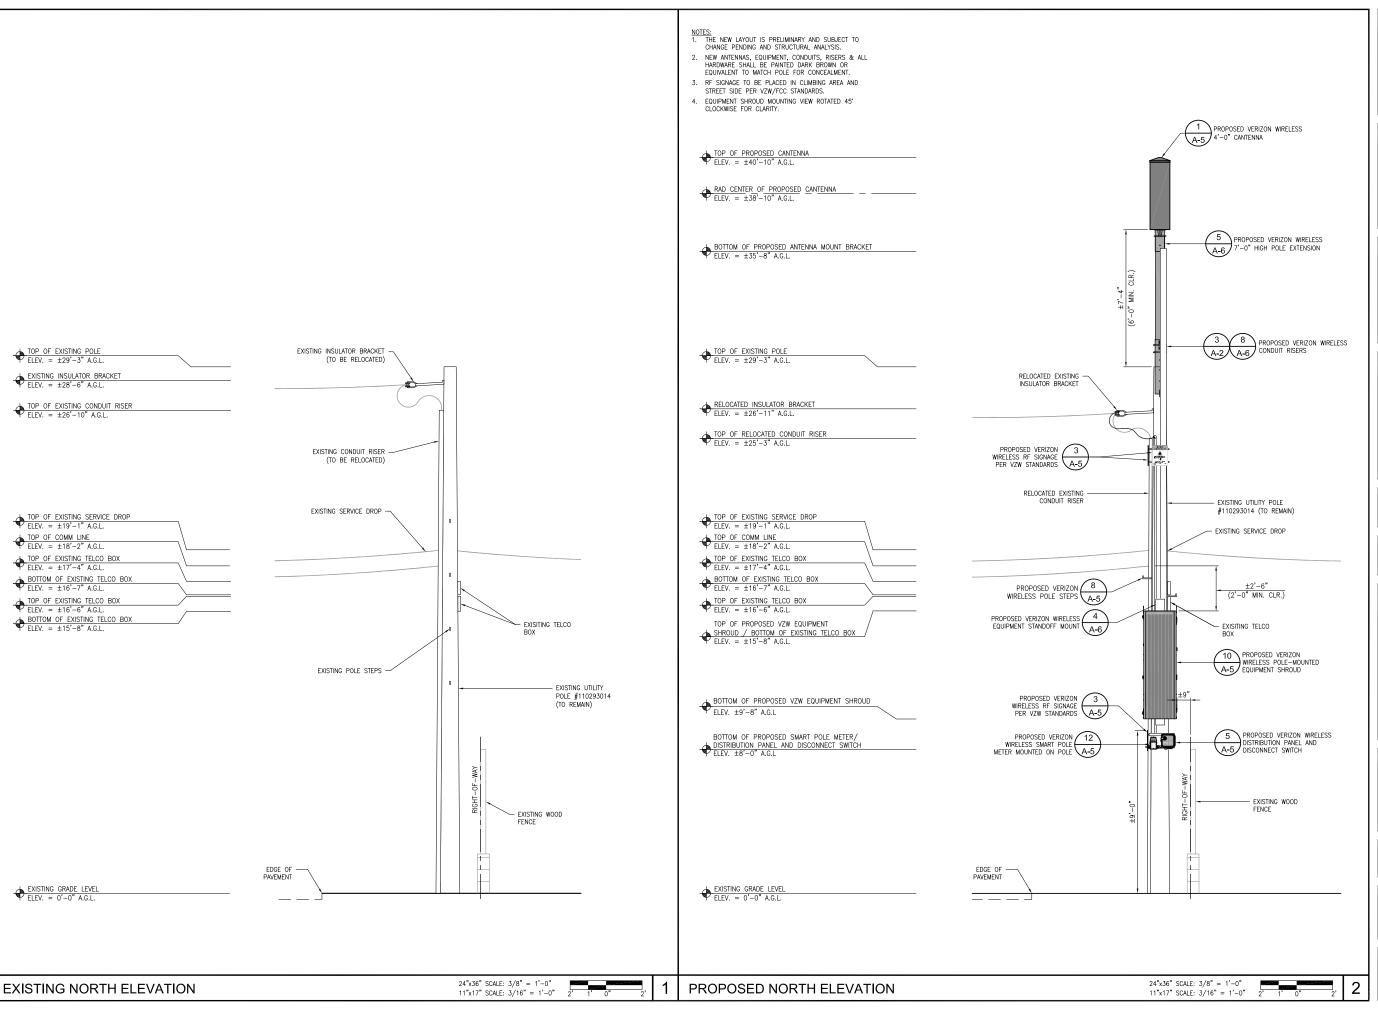







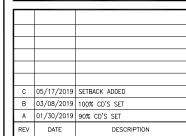

SSUED DATE: ----

MAY 17, 2019

ISSUED FOR: -

100% CD SET

No. C 83930 Exp. 9-30-19

PROJECT INFORMATION


SOUTH CARMEL 001
LOCATION CODE: 428216
IFO A2 LOT 11 SAN ANTONIO AVE.,
CARMEL, CA 93923

DRAWN BY:	SAC
CHECKED BY:	RGG

SHEET-TITLE:

ARCHITECTURAL ELEVATIONS

SHEET NUMBER: -

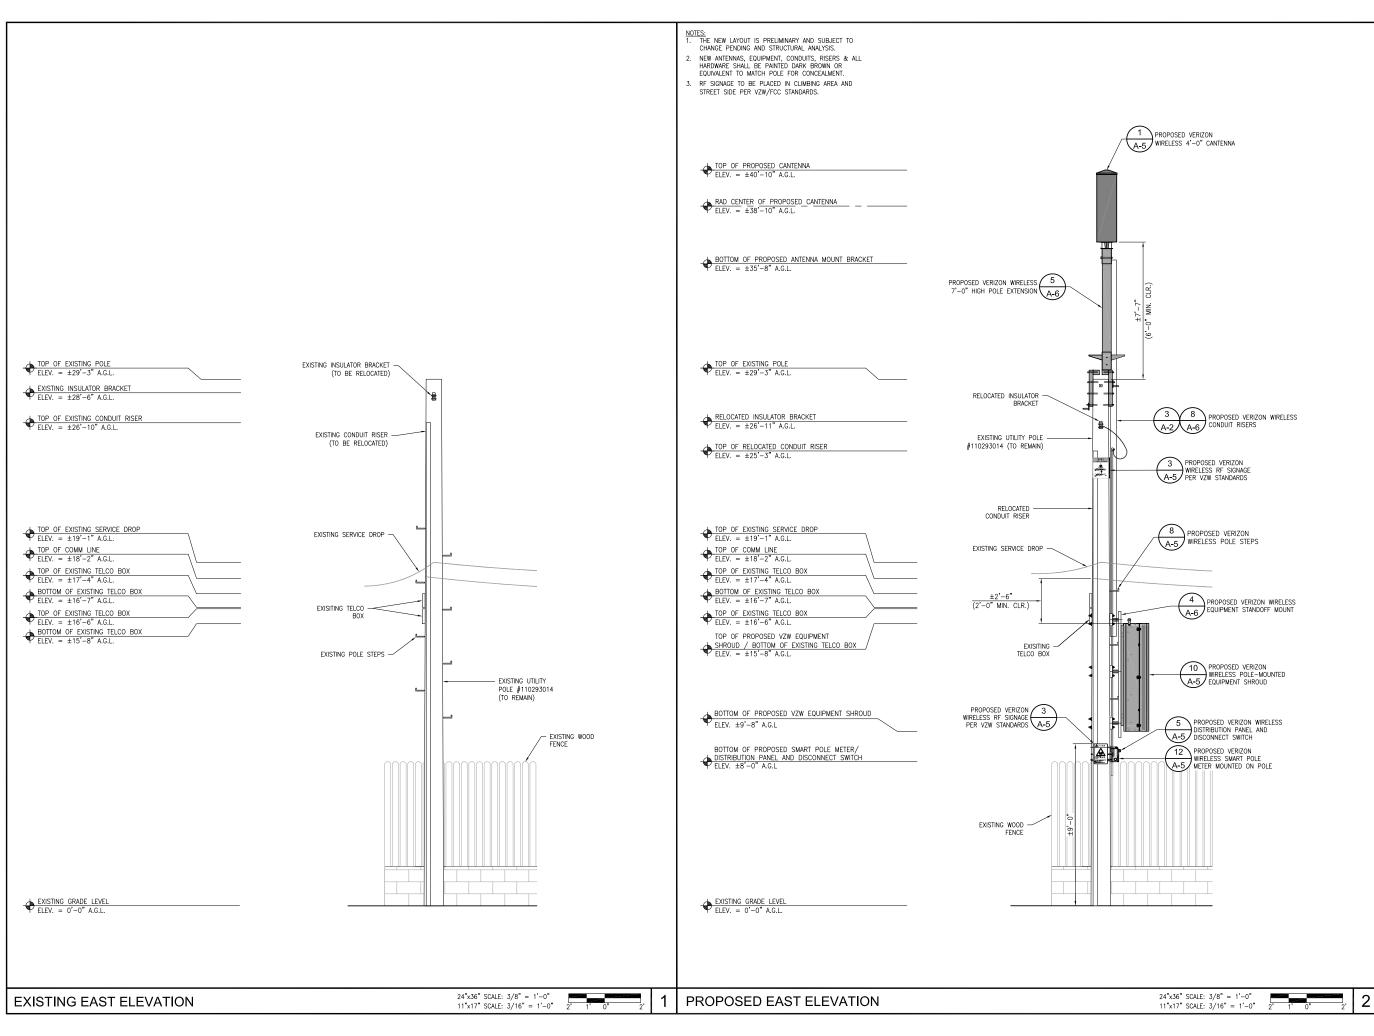







10650 SCRIPPS RANCH BLVD., SUITE 224 SAN DIEGO, CA 92131 tel: (858) 433-7173 / (858) 433-7176

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П	С	05/17/2019	SETBACK ADDED
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ISSUED DATE: •

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No. C 83930 Exp. 9-30-19

PROJECT INFORMATION:


SOUTH CARMEL 001
LOCATION CODE: 428216
IFO A2 LOT 11 SAN ANTONIO AVE.,
CARMEL, CA 93923

DRAWN BY:	SAC
CHECKED BY:	RGG

SHEET-TITLE:

ARCHITECTURAL ELEVATIONS

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C 05/17/2019 SETBACK ADDED B 03/08/2019 100% CD'S SET A 01/30/2019 90% CD'S SET REV DATE DESCRIPTION

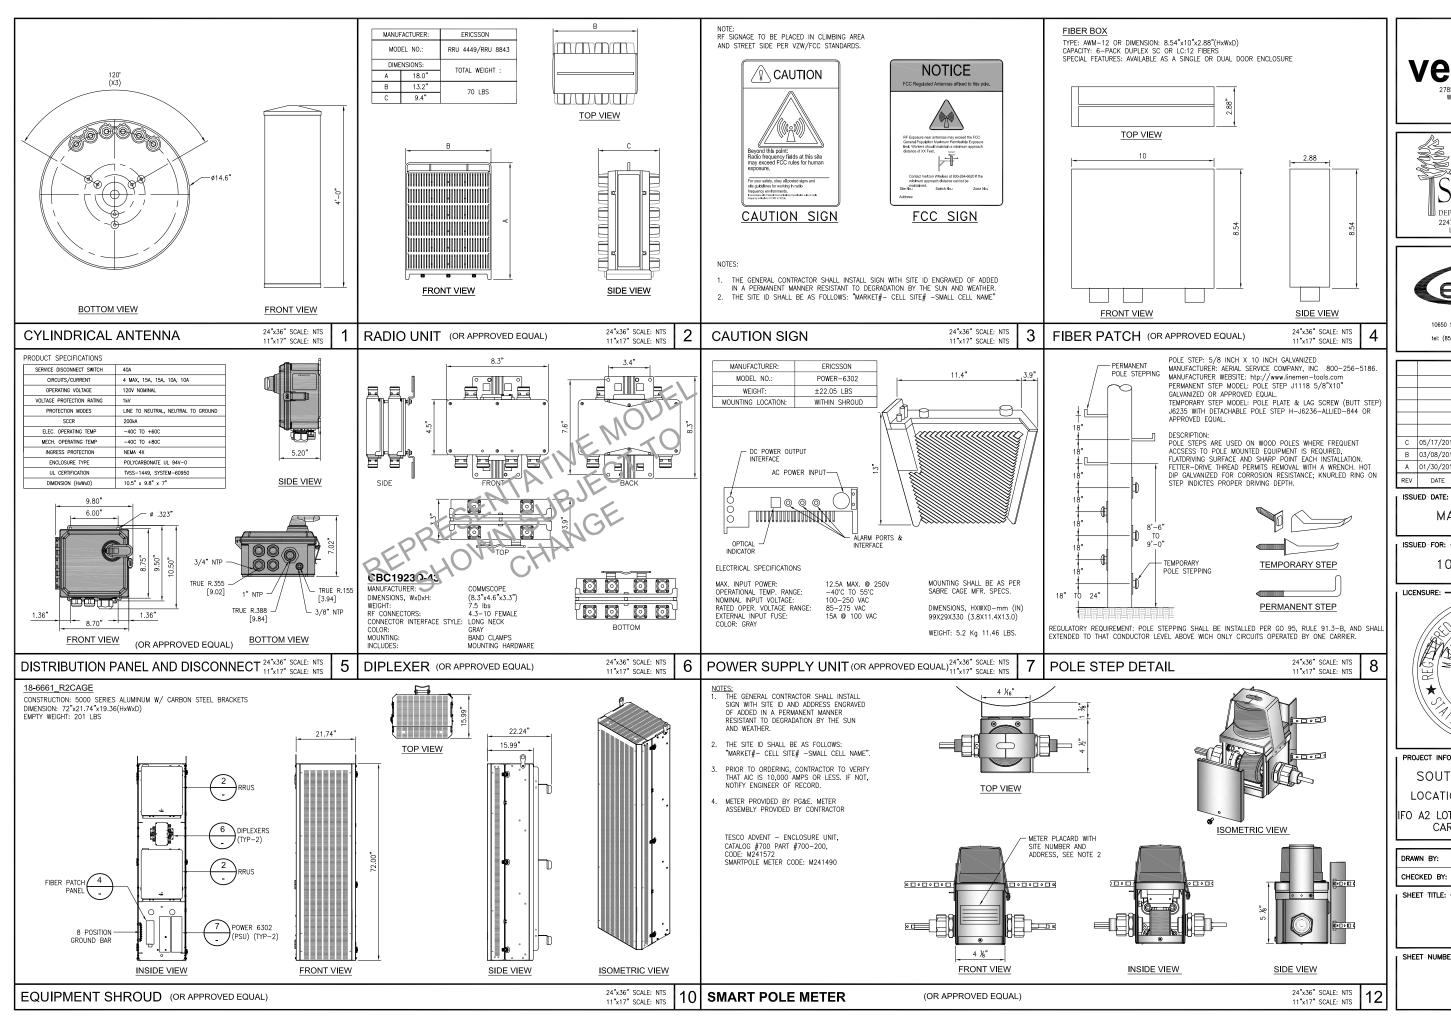MAY 17, 2019

100% CD SET




SOUTH CARMEL 001 LOCATION CODE: 428216

IFO A2 LOT 11 SAN ANTONIO AVE. CARMEL, CA 93923

DRAWN BY:	SAC
CHECKED BY:	RGG

DETAILS


SHEET NUMBER:

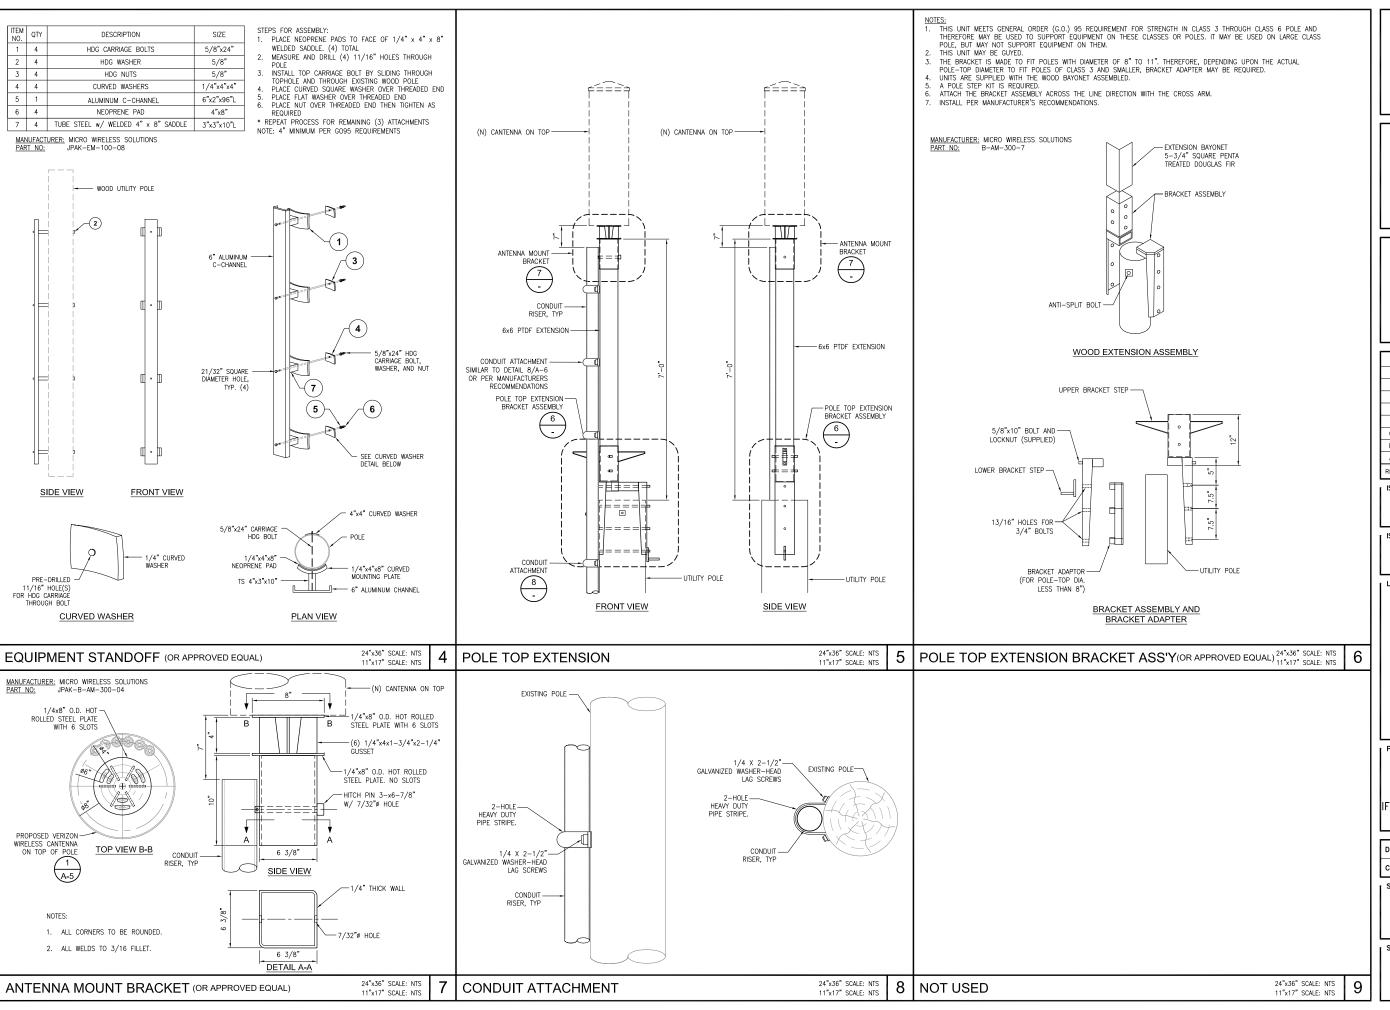







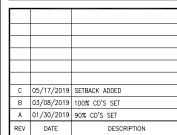

ISSUED DATE:

MAY 17, 2019

ISSUED FOR:

100% CD SET

No. C 83930 Exp. 9-30-19

PROJECT INFORMATION:

SOUTH CARMEL 001
LOCATION CODE: 428216
IFO A2 LOT 11 SAN ANTONIO AVE.
CARMEL, CA 93923

DRAWN BY: SAC CHECKED BY: RGG

SHEET-TITLE:

DETAILS

SHEET NUMBER:

ELECTRICAL NOTES

- THIS INSTALLATION SHALL COMPLY WITH THE CURRENTLY ADOPTED EDITION OF THE CALIFORNIA ELECTRICAL CODE (CEC), WITH THE UTILITY COMPANY AND LOCAL CODE RECHIREMENTS
- POWER, CONTROL AND FOUIPMENT GROUND WIRING IN CONDUIT SHALL BE SINGLE CONDUCTOR (#12 AWG AND LARGER), 600V, OIL RESISTANT THHN OR THWN-2, CLASS B STRANDED COPPER CABLE RATED FOR 90°C (WET AND DRY) OPERATION; LISTED OR LABELED FOR THE LOCATION AND RACEWAY SYSTEM USED.
- CUT, COIL AND TAPE A 3 FOOT PIGTAIL FROM END OF LFMC FOR TERMINATING AT EQUIPMENT, IF REQUIRED.
- SUPPLEMENTAL EQUIPMENT GROUND WIRING LOCATED OUTDOORS OR BELOW GRADE SHALL BE SINGLE CONDUCTOR #2 AWG SOLID, TINNED, COPPER WIRE
- ALL POWER AND GROUNDING CONNECTIONS SHALL BE CRIMP STYLE, COMPRESSION, WIRE LUGS AND WIRENUTS BY THOMAS AND BETTS (OR EQUAL). LUGS AND WIRENUTS SHALL BE RATED FOR OPERATION AT NO LESS THAN 75°C.
- ALL ELECTRICAL COMPONENTS SHALL BE CLEARLY LABELED WITH ENGRAVED LAMINATED PLASTIC LABELS. ALL EQUIPMENT SHALL BE LABELED WITH THEIR VOLTAGE RATING, PHASE CONFIGURATION, WIRE CONFIGURATION, POWER OR AMPACITY RATING AND BRANCH CIRCUIT ID NUMBERS (PANELBOARD AND CIRCUIT IDENTIFICATION).
- 7. ALL CONDUIT RUN ABOVE GROUND OR EXPOSED SHALL BE RIGID STEEL.
- CABINETS, BOXES AND WIREWAYS SHALL BE LISTED OR LABELED FOR ELECTRICAL USE IN ACCORDANCE WITH NEMA, UL, ANSI/IEEE AND CEC.
- PROVIDE NECESSARY TAGGING ON THE BREAKERS CARLES AND DISTRIBUTION PANELS N ACCORDANCE WITH APPLICABLE CODES AND STANDARDS TO SAFEGUARD LIFE AND
- ALL ELECTRODE SYSTEMS (INCLUDING TELECOMMUNICATION, RADIO, LIGHTNING PROTECTION AND AC POWER) SHALL BE BONDED TOGETHER AT OR BELOW GRADE BY TWO OR MORE COPPER BONDING CONDUCTORS IN ACCORDANCE WITH THE CEC.
- PERFORM IFFE FALL-OF-POTENTIAL RESISTANCE TO FARTH TESTING (PER IFFE 1100 PERFORM IEEE FALL—OF—POTAINER RESISTANCE TO EARTH TESTING FOR THEE THOU AND 81) FOR NEW GROUND ELECTRODE SYSTEMS. THE CONTRACTOR SHALL FURNISH AND INSTALL SUPPLEMENTAL GROUND ELECTRODES AS NEEDED TO ACHIEVE A TEST RESULT OF 5 OHMS OR LESS.
- METAL RACEWAY SHALL NOT BE USED AS THE CEC REQUIRED EQUIPMENT GROUND CONDUCTOR. STRANDED COPPER CONDUCTORS WITH GREEN INSULATION SIZED IN ACCORDANCE WITH THE CEC SHALL BE FURNISHED AND INSTALLED WITH THE POWER CIRCUITS TO FQUIPMENT.
- 13. EXPOSED GROUND CONNECTIONS SHALL BE MADE WITH COMPRESSION CONNECTORS WHICH ARE THEN BOLTED TO EQUIPMENT USING STAINLESS STEEL HARDWARE. INSTALLATION TORQUE SHALL BE PER MANUFACTURER'S REQUIREMENTS.
- PROVIDE SUPPORTING DEVICES FOR MEMORY ACCOUNTENTS. REQUIREMENT, FIXTURES, BOXES, PANEL, ETC., SUPPORT LUMINARIES FROM UNDERSIDE OF STRUCTURAL CEILING, EQUIPMENT SHALL BE BRACED TO WITHSTAND HORIZONTAL FORCES IN ACCORDANCE WITH STATE AND LOCAL CODE REQUIREMENTS. PROVIDE PRIOR ALIGNMENT AND LEVELING OF ALL DEVICES AND FIXTURES.

POLE CONSTRUCTION NOTES:

- METER SHALL NOT FACE THE STREET, ALLEY, OR PROPERTY SIDE OF THE POLE.
- METER BASE AND DISCONNECT SHALL BE BONDED TO A SEPARATE GROUND FROM THE POLE GROUND WITH CONDUCTOR HAVING A CURRENT CAPACITY THAN NO LESS THAN #6 SOLID COPPER CONDUCTOR.
- 3. EQUIPMENT CANNOT OVERHANG THE ROADWAY.
- 4. VERIFY AND RECORD ALL CHANGES AND FOOTAGES IN FIELD ON THE FINAL AS-BUILT DRAWINGS
- 5. GROUNDS ARE TO BE TESTED: REQUIRES 5 OHMS OR LESS RESISTANCE.
- 6. ALL LANDSCAPING TO BE RESTORED TO ORIGINAL CONDITION. 7. NOTIFY PROPERTY OWNER BEFORE WORKING ON OR AROUND PRIVATE PROPERTY.
- 8. OBTAIN SPECIAL PERMITS AND PAY FEES AS REQUIRED WHEN WORKING ON CITY AND
- COUNTY HIGHWAY SITES.
- 9. MAINTAIN 36" MINIMUM COVER IN PARKWAY.
- 10. MAINTAIN 30" MINIMUM COVER BELOW GUTTER GRADE ON SURFACE STREETS.
- 11. CONDUITS MAY BE MOUNTED DIRECTLY TO THE POLE OR U-GUARD MAY BE USED IF THE POLE IS WITHIN 15" OF A BUCKET TRUCK ACCESSIBLE PAVED ROAD. IF NOT ACCESSIBLE AND THE CONDUIT IS GREATER THAN 1-1/2", THE CONDUIT IS TO BE MOUNTED WITH A STANDOFF BRACKET THAT PROVIDES 7" CLEARANCE FROM THE POLE TO THE CONDUIT.
- 12. CONTRACTOR TO PROVIDE MOUNTS OR ADDITIONAL HARDWARE IF REQUIRED FOR INSTALLATION OF PROPOSED ANTENNAS.
- 13. <u>Conduit requirements:</u>
 UNDERGROUND SCHEDULE 40 PVC OR BETTER
 RISERS SCHEDULE 80 PVC WITH FIRST 10' ABOVE GROUND LEVEL TO BE RGS FOR PROTECTION PURPOSES. ALL CONDUITS WILL BE MANDRELED AND EQUIPPED WITH 3/8" PULL ROPE AND MEASURE TAPE IF REQUIRED.

GROUNDING NOTES

- ALL DETAILS ARE SHOWN IN GENERAL TERMS. ACTUAL GROUNDING INSTALLATION REQUIREMENTS AND CONSTRUCTION SHALL BE ACCORDING TO SITE CONDITIONS.
- ALL GROUNDING CONDUCTORS: #2 AWG SOLID BARE TINNED COPPER WIRE UNLESS OTHERWISE NOTED.
- GROUND BAR LOCATED IN BASE OF EQUIPMENT WILL BE PROVIDED, FURNISHED AND INSTALLED BY THE VENDOR.
- ALL BELOW GRADE CONNECTIONS: EXOTHERMIC WELD TYPE, ABOVE GRADE CONNECTIONS: MECHANICAL/ CONNECTIONS U.N.O.
- INSTALL GROUND CONDUCTORS AND GROUND ROD MINIMUM OF 1'-0" FROM EQUIPMENT CONCRETE SLAB, SPREAD FOOTING, OR FENCE.
- ALL GROUNDING INSTALLATIONS AND CONNECTIONS SHALL BE MADE BY ELECTRICAL ALL GROUNDING FOR ANTENNAS SHALL BE CONNECTED SO THAT IT WILL BY-PASS
- MAIN BUSS BAR USE SEPARATE HOLES FOR GROUNDING AT BUSS BAR, NO "DOUBLE-UP" OR
- BACK TO BACK LUGS. NO LB'S ALLOWED ON GROUNDING.
- PROVIDE STAINLESS STEEL CLAMP AND BRASS TAGS ON ANY COAX AT ANTENNAS AND RADIOS.
- ALL ELECTRICAL AND GROUNDING AT THE CELL SITE SHALL COMPLY WITH THE CALIFORNIA ELECTRICAL CODE (CEC).
- EXOTHERMIC WELDING IS REQUIRED FOR GROUNDING BELOW GRADE CONNECTIONS
- MECHANICAL, ABOVE GRADE CONNECTIONS MAY BE MADE USING COMPRESSION TYPE-2 HOLES. LONG BARREL LUGS OR DOUBLE CRIMP CLAMP "C" CLAMP. THE COPPER CABLES SHALL BE COATED WITH ANTIOXIDANT (COPPER SHIELD) BEFORE MAKING THE CONNECTIONS. THE MANUFACTURER'S TORQUE RECOMMENDATIONS ON THE BOLT ASSEMBLY TO SECURE CONNECTIONS SHALL BE FOLLOWED. ALL TWO HOLE LONG BARREL LUGS SHALL HAVE VIEW PORTS TO ENSURE PROPER
- PROVIDE PVC SLEEVES FOR GROUNDING CONDUCTORS AS NEEDED.
- 15. GROUND ANTENNA BASES, FRAMES, CABLE RACKS AND OTHER METALLIC COMPONENTS WITH #2 GROUNDING CONDUCTORS AND CONNECT TO INSULATED SURFACE MOUNTED GROUND BARS. CONNECTION DETAILS SHALL FOLLOW MANUFACTURER'S SPECIFICATIONS FOR GROUNDING
- 16. PERFORM IEEE FALL-OF-POTENTIAL RESISTANCE TO EARTH TESTING (PER IEEE 1100 AND 81) FOR NEW GROUND ELECTRODE SYSTEMS. THE SUBCONTRACTOR SHALL FURNISH AND INSTALL SUPPLEMENTAL GROUND ELECTRODES AS NEEDED TO ACHIEVE A TEST RESULT OF 5 OHMS OR LESS.
- 17. SURFACES TO BE CONNECTED TO GROUND CONDUCTORS SHALL BE CLEANED TO A BRIGHT SURFACE AT ALL CONNECTIONS.

18 GROUND REQUIREMENTS:

GROUND REQUIREMENTS:
5/8" SS, COPPER CLAD GROUNDING ROD—10' LENGTH
GROUND TESTED AT 5 OHMS OR LESS
#2 GROUND WIRE, SOLID, TINNED

#2 GROUND MICLDING, STAPLED TO POLE EVERY 2'-0" AND AT EACH END GROUND RODS MUST BE 24" FROM POLE AND THE TOP OF ROD MUST BE BELOW GRADE LEVEL PER PLAN DETAILS.

M UTILITY METER

FUSE

CIRCUIT BREAKER

DUPLEX RECEPTACLE WITH GFCI

IN WEATHERPROOF ENCLOSURE

CLAMP OR DOUBLE HOLE LUG

TYPE GROUND CONNECTION

EXOTHERMIC CONNECTION TO

DISCONNECT SWITCH

LEGEND SYMBOLS:

GROUNDING WIRE, DASHED LINE

AC POWER LINE, DASHED INDICATES UNDERGROUND DC POWER LINE, DASHED INDICATES UNDERGROUND

TELEPHONE LINE, DASHED LINE

INDICATES UNDERGROUND COAXIAL CABLE, DASHED LINE INDICATES UNDERGROUND

FIBER CABLE, DASHED LINE INDICATES UNDERGROUND

DETAIL REFERENCE DETAIL NO. 2 ON SHEET E3


 $\frac{2}{E3}$ \otimes GROUND ROD

 \boxtimes

GROUND ROD WITH ACCESS

- . ALL CONDUIT ROUTING IS SCHEMATIC. CONTRACTOR SHALL INSTALL CONDUITS SO THAT ACCESS TO EQUIPMENT IS NOT IMPEDED.
- 2 CONDUIT SIZES INDICATED ON THE DRAWINGS ARE NOT NECESSARILY BASED ON THE MINIMUM CONDUIT SIZES INDICATED ON THE DRAWINGS ARE NOT NECESSARILE BASED ON THE MINIMUM SIZE ALLOWED BY THE CEC AND MAY BE PURPOSELY OVERSIZED FOR FUTURE CONDUCTORS OR TO AVOID CONDUCTOR HEATING. CONDUIT SIZES NOT CALLED OUT ON THE DRAWINGS SHALL BE SIZED BY THE CONTRACTOR, BASED ON THE ACTUAL NUMBER OF CONDUCTORS TO BE INSTALLED, USING THE CEC AS A GUIDE. IN NO CASE SHALL CONDUIT SIZES BE SMALLER THAN 1/2
- 3. THE CONTRACTOR SHALL PROVIDE AND INSTALL ALL JUNCTION AND PULLBOXES REQUIRED FOR THE INSTALLATION OF ELECTRICAL DEVICES AND ENDIAGE. WHETHER OR NOT SPECIFICALLY INDICATED ON THE PLANS. SIZING OF THESE BOXES SHALL BE PER THE CEC.
- ALL ELECTRICAL WORK SHALL BE CONSTRUCTED IN ACCORDANCE WITH PROJECT SPECIFICATIONS AND ALL APPLICABLE LOCAL CODES AND REGULATIONS.
- UTILITY ELECTRICAL SERVICE WILL BE 120/240 VOLTS OR 120/208 VOLTS, SINGLE PHASE, MIN. 30 AMPS CAPACITY. SEE PLANS FOR DETAILS.
- 6 PROJECT CONDITIONS MAY REQUIRE REARRANGEMENT OF ELECTRICAL WORK. THE SUBCONTRACTOR SHALL INDICATE SUCH CHANGES ON THE AS-BUILT DRAWINGS. WHERE CHANGES REQUIRE ALTERNATE METHODS TO THOSE SPECIFIED IN THE PLANS, THE SUBCONTRACTOR SHALL REQUEST APPROVAL. AND SHALL NOT PROCEED UNTIL APPROVAL IS OBTAINED.
- CONTRACTOR SHALL PAINT ALL EXPOSED EXTERIOR CONDUITS AND JUNCTION BOXES TO MATCH EXISTING FINISH ON WHICH THEY ARE ATTACHED.
- 8 FIRER TRUNKS AND/OR BACKHAUL LENGTHS AND ROLLTES ARE NOT VERIFIED DURING THE SITE WALK CONTRACTOR TO VERIFY ACTUAL ROUTE AND TRUNK LENGTH DURING PRE-CONSTRUCTION WALF
- O. CONTRACTOR SHALL COORDINATE WITH UTILITY COMPANY FOR FINAL AND EXACT WORK/MATERIALS REQUIREMENTS AND CONSTRUCT TO UTILITY ENGINEERING PLANS AND SPECIFICATIONS ONLY WHERE APPLICABLE PER PROJECT SCOPE OF WORK.
- 10. CONTRACTOR SHALL FURNISH AND INSTALL CONDUIT, PULL WIRES, CABLE PULL BOXES, CONCRETE ENCASEMENT OF CONDUIT, TRANSFORMER PAD, BARRIERS, POLE RISER TRENCHING, BACK FILL, AND UTILITY FEES, AND INCLUDE REQUIREMENTS IN SCOPE.
- 11. TEST ALL ELECTRICAL & GROUNDING SYSTEMS (CONTINUITY, MEGGER, ETC.) UPON COMPLETION OF INSTALLATION PRIOR TO FINALIZING WORK.
- CONTRACTOR TO VERIFY ALL CONDUIT ROUTING FOR, (N) VZW METER AND (N) GROUND ROD LOCATION WITH LANDLORD AND UTILITY COORDINATOR IN FIELD.
- 13. CONDUIT REQUIREMENTS (TYP., U.N.O.): UNDERGROUND: PVC (SCHED. 40 OR 80). INDOOR: EMT (RGS TRAFFIC AREAS). OUTDOOR: (ABOVE GRADE) RGS.
- 14. PROVIDE A MIN. 36" WORK CLEARANCE IN FRONT OF PANELS/ ELECTRICAL EQUIPMENT.

	BREAKER LE	GEND	
CIRCUIT #	DESCRIPTION	ACB /	#POLES
1	PSU #1	15A 1P	10A 2P
2	PSU #2	15A 1P	10A 2P
3	SPARE	10A 1P	-
,	SPAIL	TUA IF	-
4	SPARE	10A 1P	-
*	SPARE	TUA IF	_

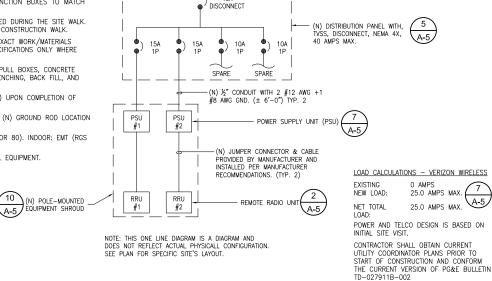

PG&E POWER SOURCE 120 VAC, 1PHASE 40 AMPS MIN.

(FROM PG&E SERVICE DROP ON POLE) A-3

PG&E REQUIREMENTS FOR

ASSEMBLY GROUND METER PER

METER ASSEMBLY GROUND LUG.

MANUFACTURER RECOMMENDATIONS ON

(N) SMART POLE WATTHOUR (SMART POLE METER), 3-WIRE 1-PHASE 120/240v 60 AMP CT METER WITH POLE MOUNT

(N) OVER HEAD SERVICE





_		
С	05/17/2019	SETBACK ADDED
В	03/08/2019	100% CD'S SET
Α	01/30/2019	90% CD'S SET
REV	DATE	DESCRIPTION
1001	ED DATE	

ISSUED DATE:

A-5

AVAILABLE FAULT CURRENT PER LITHLITY

24"x36" SCALE: NTS

11"x17" SCALE: NTS

24"x36" SCALE: NTS

11"x17" SCALE: NTS

2

MAY 17, 2019

ISSUED-FOR: -

100% CD SET

LICENSURE:



SOUTH CARMEL 001 LOCATION CODE: 428216

IFO A2 LOT 11 SAN ANTONIO AVE. CARMEL, CA 93923

DRAWN BY: SAC

SHEET-TITLE: ELECTRICAL NOTES, SINGLE LINE DIAGRAM &


SHEET-NUMBER:

E-1

SINGLE LINE DIAGRAM

PG&E DESIGN

NOT USED

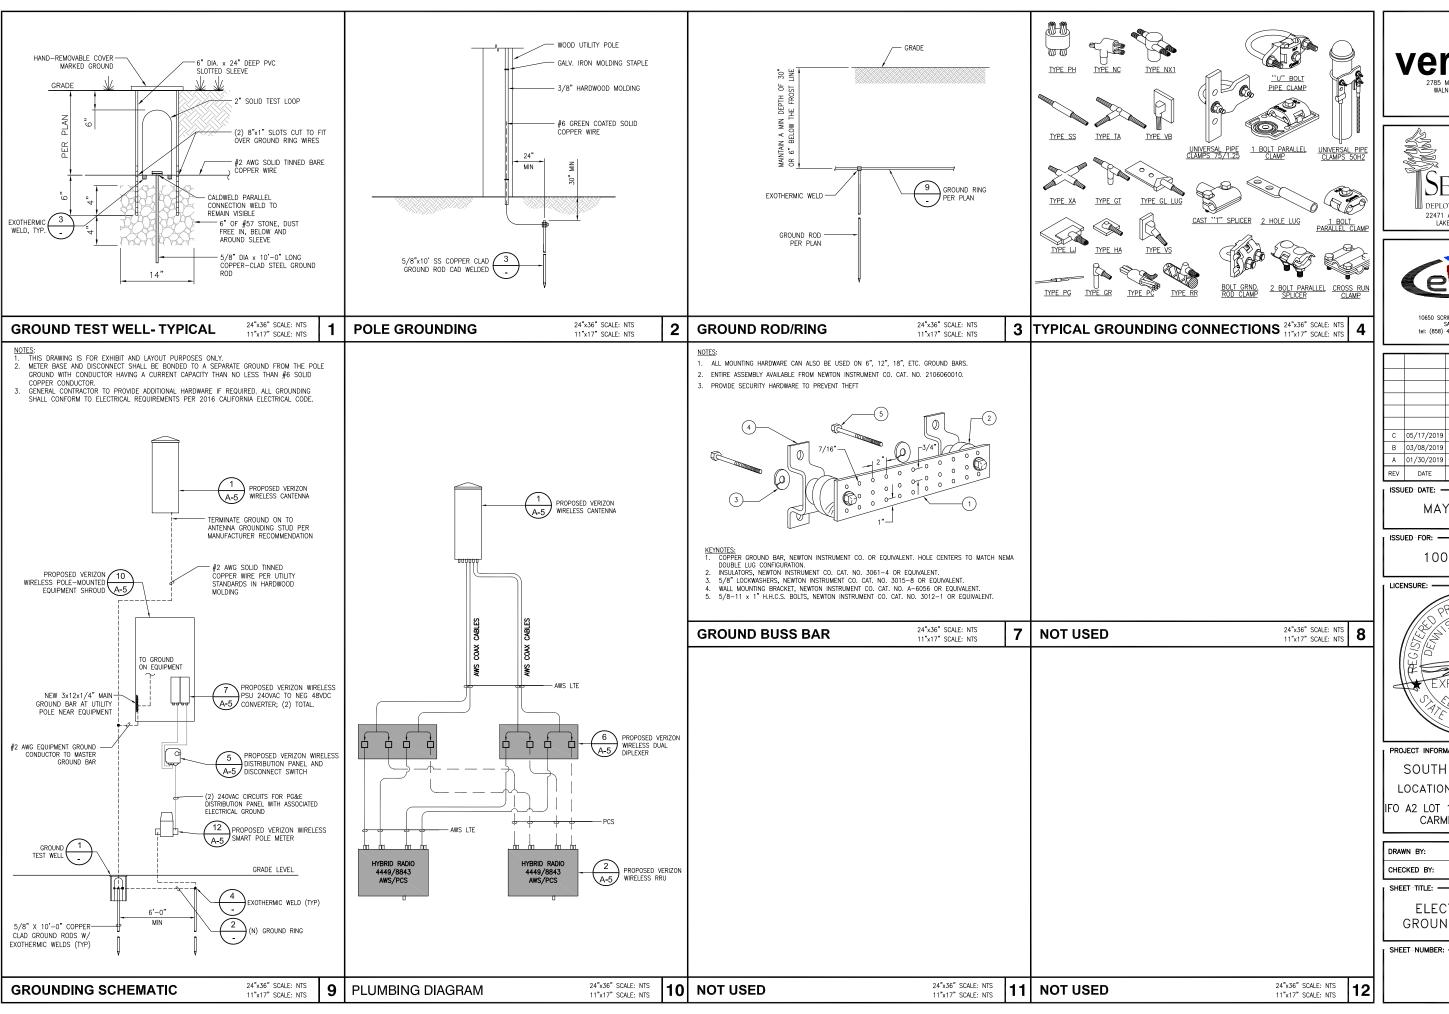







Ι.			
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П			
П			
П	С	05/17/2019	SETBACK ADDED
П	В	03/08/2019	100% CD'S SET
П	Α	01/30/2019	90% CD'S SET
Н	REV	DATE	DESCRIPTION

ISSUED DATE:

MAY 17, 2019

ISSUED FOR: -

100% CD SET

LICENSURE:



SOUTH CARMEL 001 LOCATION CODE: 428216

IFO A2 LOT 11 SAN ANTONIO AVE., CARMEL, CA 93923

DRAWN BY:	SAC
CHECKED BY:	RGG

SHEET-TITLE: -

ELECTRICAL AND GROUNDING DETAILS

SHEET NUMBER:

E-2



SITE INFORMATION

PACIFIC GAS & ELECTRIC 245 MARKET ST., MAIL CODE N10D SAN FRANCISCO, CA 94105 CONTACT: DAVID ZENNER PH: (415) 847-0283

APPLICANT:

VERIZON WIRELESS 2785 MITCHELL DRIVE, BLDG. 9 WALNUT CREEK, CA 94598 36' 32' 44.72" N

121' 55' 40.02" W

LATITUDE (NAD 83): LONGITUDE (NAD 83): GROUND ELEVATION

+56.93' AMSI CITY OF CARMEL BY THE SEA ZONING JURISDICTION

PROPOSED USE

PROJECT TEAM

TRAFFIC CONTROL NOTE

APPLICANT:
VERIZON WIRELESS
2785 MITCHELL DRIVE, BLDG. 9
WALNUT CREEK, CA 94598
CONTACT: MICHELLE MARTINEA
PHONE: (925) 588-9840
EMAIL: michelle.martinea@verizonwireless.com

RF ENGINEER:
VERIZON WIRELESS
2785 MITCHELL DRIVE, BLDG. 9
WALNUT CREEK, CA 94598
CONTACT: DEWAYNE BONHAM PHONE: (510) 414-8896

ARCHITECT/ENGINEERING: CELLSITE CONCEPTS 10650 SCRIPPS RANCH BLVD., SUITE 224 SAN DIEGO, CA 92131 CONTACT: REGGIE GABRIEI PHONE: (619) 200-7190 EMAIL: reggie.gabriel@cellsite.net

<u>SITE ACQUISITION:</u> SEQUOIA DEPLOYMENT SERVICES, INC.

UNMANNED TELECOMMUNICATIONS FACILITY

22471 ASPAN ST., SUITE #290 LAKE FOREST, CA 92630 CONTACT: CHELSEA MANUTO PHONE: (760) 445-1985 EMAIL: chelsea.manuto@seauoia-ds.con

CONSTRUCTION: SEQUOIA DEPLOYMENT SERVICES, INC. 22471 ASPAN ST., SUITE #290 LAKE FOREST, CA 92630 CONTACT: PETE SHUBIN PHONE: (714) 478-3197 EMAIL: pete.shubin@sequoia-ds.com

ZONING: SEQUOIA DEPLOYMENT SERVICES, INC. 22471 ASPAN ST., SUITE #290 LAKE FOREST, CA 92630 CONTACT: MICHAEL NAZAROFF PHONE: (562) 237-6380
EMAIL: michael.nazaroff@sequoia-ds.com



	DRAWING INDEX
HEET NO:	SHEET TITLE
T-1	TITLE SHEET
T-2	NOTES AND SPECIFICATIONS
LS-1	TOPOGRAPHIC SURVEY
A-1	SITE PLAN
A-2	ENLARGED SITE PLAN AND EQUIPMENT / ANTENNA LAYOUTS
A-3	ARCHITECTURAL ELEVATIONS
A-4	ARCHITECTURAL ELEVATIONS
A-5	DETAILS
A-6	DETAILS
E-1	ELECTRICAL NOTES AND SINGLE LINE DIAGRAM
E-2	ELECTRICAL AND GROUNDING DETAILS

PROJECT DESCRIPTION

THE PROJECT CONSISTS OF INSTALLATIONS OF TELECOMMUNICATIONS EQUIPMENT FOR VERIZON WIRELESS TO COLLOCATE ON NEW PG&E POLE. THE INSTALLATIONS ENTAILS:

- REMOVE EXISTING 40' POLE IN RIGHT OF WAY
- INSTALL (1) PROPOSED 50'-0" CLASS 3 WOOD POLE IN RIGHT OF WAY
 INSTALL (1) PROPOSED VERIZON WIRELESS 4'-0" HIGH CANTENNA ON POLE
- PROPOSED VERIZON WIRELESS CANTENNA MOUNTING BRACKET
- PROPOSED VERIZON WIRELESS EQUIPMENT STANDOFF
- PROPOSED VERIZON WIRELESS EQUIPMENT SHROUD WITH REMOTE RADIO UNITS (RRU), INSTALL (1
- DIPLEXER(S), PSU(S) AND FIBER DEMARC. INSTALL (1) PROPOSED VERIZON WIRELESS SMART POLE METER
- (1) PROPOSED VERIZON WIRELESS DISTRIBUTION PANEL AND DISCONNECT SWITCH

THE CONTRACTOR SHALL SUBMIT A TRAFFIC CONTROL PLAN (11"X17") FOR APPROVAL PRIOR TO STARTING WORK. THE PLAN SHOULD BE SUBMITTED TO THE TRAFFIC CONTROL PERMIT COUNTER. CONTRACTOR SHALL OBTAIN A TRAFFIC CONTROL PERMIT A MINIMUM OF TWO (2) WORKING DAYS PRIOR TO STARTING WORK, AND A MINIMUM OF FIVE (5) DAYS IF WORK WILL AFFECT A BUS STOP OR AN EXISTING TRAFFIC SIGNAL, OR IF WORK WILL REQUIRE A ROAD OR ALLEY CLOSURE.

- CITY/COUNTY ORDINANCES
- ANSI/EIA-222-G LIFE SAFETY CODE NFPA-101 2016 CALIFORNIA ELECTRICAL CODE
- CA PUBLIC UTILITIES COMMISSION ORDER (GO 95 AND GO 128)

Verizon

PROJECT TYPE: POLYGON **SOUTH CARMEL 002**

IFO SAN ANTONIO AVE., 3SE 13TH AVE., **CARMEL, CA 93923**

LOCATION CODE: 428217

SITE: (PG&E POLE # TBD)

GENERAL NOTES

- LOCATIONS OF UNDERGROUND UTILITIES SHOWN ON THE DRAWINGS WERE OBTAINED BY A SEARCH OF AVAILABLE RECORDS. NEITHER THE OWNER NOR THE ENGINEER ASSUMES ANY RESPONSIBILITY FOR UTILITIES OR STRUCTURES NOT SHOWN OR NOT IN THE LOCATION SHOWN ON THE DRAWINGS.
- THE CONTRACTORS SHALL INSTALL ALL EQUIPMENT AND MATERIALS IN ACCORDANCE WITH MANUFACTURER'S RECOMMENDATIONS UNLESS SPECIFICALLY INDICATED OTHERWISE, OR WHERE LOCAL CODES OR REGULATIONS TAKE PRECEDENCE.
- APPROVAL OF THESE PLANS BY THE CITY ENGINEER DOES NOT AUTHORIZE ANY WORK TO BE PERFORMED UNTIL A PERMIT HAS BEEN ISSUED.
- UPON ISSUANCE OF A PERMIT, NO WORK WILL BE PERMITTED ON WEEKENDS OR HOLIDAYS WITHOUT PERMISSION FROM THE ENGINEERING DEPARTMENT
- THE CONTRACTOR SHALL TAKE ALL PRECAUTIONARY MEASURES NECESSARY TO PROTECT FROM DAMAGING EXISTING IMPROVEMENTS WHICH ARE TO REMAIN IN PLACE. CONTRACTOR SHALL, AT HIS OWN EXPENSE, REPAIR, REPLACE OR RECONSTRUCT ALL SUCH IMPROVEMENTS OR OTHER STRUCTURES DAMAGED BY HIS WORK, TO THE ENGINEER'S SATISFACTION.
- THE CONTRACTOR SHALL BE RESPONSIBLE FOR SURVEY MONUMENTS AND/OR VERTICAL CONTROL BENCHMARKS WHICH ARE DISTURBED OR DESTROYED BY CONSTRUCTION. A LAND SURVEYOR MUST FILED LOCATE, REFERENCE, AND/OR PRESERVE ALL HISTORICAL OR CONTROLLING MONUMENTS PRIOR TO ANY EARTHWORK, IP DESTROYED, SUCH MONUMENTS SHALL BE REPLACED WITH APPROPRIATE MONUMENTS BY A LAND SURVEYOR A CORNER RECORD OF SURVEY, AS APPROPRIATE, SHALL BE FIELD AS REQUIRED BY THE PROFESSIONAL LAND SURVEYORS ACT. IF ANY VERTICAL CONTROL IS TO BE DISTURBED OR DESTROYED, THE JURISDICTION'S FIELD SURVEY DIVISION MUST BE NOTIFIED, IN WRITING, AT LEAST 3 DAYS FROM OCCURRENCE. THE CONTRACTOR WILL BE RESPONSIBLE FOR THE COST OF REPLACING ANY VERTICAL CONTROL BENCHMARKS DESTROYED BY THE CONSTRUCTION
- CONTRACTOR SHALL BE RESPONSIBLE FOR THE POTHOLE AND LOCATING OF ALL EXISTING UTILITIES THAT CROSS THE PROPOSITENCH LINE AND MUST MAINTAIN 1 FOOT MINIMUM VERTICAL
- DO NOT EXCAVATE OR DISTURB BEYOND THE PROPERTY LINES OR LEASE LINES, UNLESS OTHERWISE NOTED.
- CONTRACTOR SHALL REPLACE OR REPAIR ALL TRAFFIC SIGNAL

- 10. CONTRACTOR SHALL NOTIFY THE JURISDICTION A MINIMUM OF 48 HOURS PRIOR TO COMMENCING WORK WITHIN 10 FEET OF ALL SEWER, WATER, AND STORM DRAIN MAIN
- 11 "PUBLIC IMPROVEMENT SUBJECT TO DESUETUDE OR DAMAGE." IF REPAIR OR REPLACEMENT OF SUCH PUBLIC IMPROVEMENTS IS REQUIRED, THE OWNER SHALL OBTAIN THE REQUIRED PERMITS FOR WORK IN PUBLIC RIGHT-OF-WAY, SATISFACTORY TO THE PERMIT-ISSUING AUTHORITY.
- 12. THE CONTRACTOR SHALL MAKE ARRANGEMENTS FOR A PRE-CONSTRUCTION MEETING WITH THE CITY FIELD ENGINEERING DIVISION PRIOR TO ANY DISTURBANCE TO THE SITE, EXCLUDING UTILITY MARK-OUTS AND SURVEYING.
- 13. MANHOLES OR COVERS SHALL BE LABELLED "NAME OF COMPANY"
- 14. CONTRACTOR SHALL IMPLEMENT AN EROSION AND SEDIMENT CONTROL PROGRAM DURING THE PROJECT CONSTRUCTION ACTIVITIES. THE PROGRAM SHALL MEET THE APPLICABLE REQUIREMENTS OF THE STATE WATER RESOURCE CONTROL
- 15. THE CONTRACTOR SHALL HAVE EMERGENCY MATERIALS AND EQUIPMENT ON HAND FOR UNFORESEEN STUATIONS, SUCH AS DAMAGE TO UNDERGROUND WATER, SEWER, AND STORM DRAIN FACILITIES WHEREBY FLOWS MAY GENERATE EROSION AND SEDIMENT POLLUTION.
- 16. THE CONTRACTOR SHALL VERIEY LOCATION ALL EXISTING UNDERGROUND UTILITIES INCLUDING SEWER LATERALS & WATER SERVICES TO INDIVIDUAL LOTS OF BOTH VERTICAL AND HORIZONTAL PRIOR TO COMMENCING IMPROVEMENTS OPERATIONS.
- LOCATION AND ELEVATIONS OF IMPROVEMENTS, TO BE MET BY WORK, SHALL BE CONFIRMED BY FIELD MEASUREMENTS PRIOF TO CONSTRUCTION OF NEW WORK.
- 18. GRADES SHOWN ARE FINISH GRADES, CONTRACTOR SHALL
 DETERMINE NECESSARY SUB GRADE ELEVATIONS AND SHALL
 CONSTRUCT SMOOTH TRANSITION BETWEEN FINISH GRADES
- 19. THE CONTRACTOR SHALL SUBMIT WORK PLANS FOR ALL BORE OPERATIONS TWO WEEKS PRIOR TO COMMENCING WORK
- 20. THE CONTRACTOR SHALL BE TOTALLY RESPONSIBLE FOR COMPLIANCE WITH THE PROVISIONS OF THE STATE OF

- 21. CONTRACTOR AGREES THAT HE SHALL ASSUME SOLE
 RESPONSIBILITY FOR JOB SITE CONDITION DURING THE COURSE
 OF CONSTRUCTION OF THIS PROJECT, INCLUDING SAFETY OF ALL
 PERSONS AND PROPERTY; THAT THIS EQUIPMENT SHALL APPLY PERSONS AND PROPERTY: THAT THIS EQUIPMENT SHALL APPLY CONTINUOUSLY AND NOT BE LIMITED TO NORMAL WORKING HOURS; AND THAT THE CONTRACTOR SHALL DEFEND, INDEMNIFY AND HOLD THE OWNER AND THE ENGINEER HARMLESS FROM AND AND ALL LUABILITY, REAL OR ALLEGED IN CONNECTION WITH THE PERFORMANCE OF WORK ON THIS PROJECT, EXCEPTING FOR LIABILITY ARISING FROM SOLE NEGLIGENCE OF THE OWNER OR THE PROJECT, EXCEPTING FOR THE ENGINEER.
- 22. THE LOCATIONS OF ALL EXISTING UTILITIES SHOWN ON THESE THE LOCATIONS OF ALL EXISTING UTILITIES SHOWN ON THESE PLANS ARE FROM EXISTING RECORDS AND CORROBORATED, WHERE POSSIBLE WITH FIELD TIES. THE CONTRACTOR IS RESPONSIBLE FOR CONFIRMING THE LOCATIONS SHOWN, BOTH HORIZONTALLY AND VERTICALLY PRIOR TO CONSTRUCTION. IF EXISTING LOCATIONS VARY SUBSTANTIALLY FROM THE PLANS, THE ENGINEER SHOULD BE NOTIFIED TO MAKE ANY CONSTRUCTION CHANGES REQUIRED.
- AS-BUILT DRAWINGS MUST BE SUBMITTED TO THE CITY ENGINEER PRIOR TO ACCEPTANCE OF THIS PROJECT.
- 24. ALL NEW AND EXISTING UTILITY STRUCTURES ON SITE AND IN AREAS TO BE DISTURBED BY CONSTRUCTION SHALL BE ADJUSTED TO FINISH ELEVATIONS PRIOR TO FINAL INSPECTION OF WORK.
- 25. ANY DRAIN AND/OR FIELD TILE ENCOUNTERED/DISTURBED DURING CONSTRUCTION SHALL BE RETURNED TO IT'S ORIGINAL CONDITION PRIOR TO COMPLETION OF WORK, SIZE, LOCATION AND TYPE OF ANY UNDERGROUND UTILITIES OR IMPROVEMENTS SHALL BE ACCURATELY NOTED AND PLACED ON "AS-BUILT" DRAWINGS BY GENERAL CONTRACTOR, AND ISSUED TO THE ARCHITECT OR ENGINEER AT COMPLETION OF PROJECT.
- 26. ALL TEMPORARY EXCAVATIONS FOR THE INSTALLATION OF FOUNDATIONS, UTILITIES, ETC., SHALL BE PROPERLY LAID BACK OR BRACED IN ACCORDANCE WITH THE CORRECT OCCUPATIONAL SAFETY AND HEALTH ADMINISTRATION (OSHA) REQUIREMENTS.

Dig Alert

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Know what's below.
Call before you dig.







C 05/17/2019 SETBACK ADDED

B 03/08/2019 100% CD'S SET

A 02/01/2019 90% CD'S SET

REV DATE

MAY 17, 2019

DESCRIPTION

100% CD SET

LICENSURE No. C 83930 Exp. 9-30-19

SOUTH CARMEL 002 LOCATION CODE: 428217 IFO SAN ANTONIO AVF... 3SE 13TH AVE.,

DRAWN BY:		
CHECKED BY:	RO	

CARMEL, CA 93923

TITLE SHEET

T-1

811 / 800-227-2600

APPLICABLE CODES

NLL WORK AND MATERIALS SHALL BE PERFORMED AND INSTALLED IN ACCORDANCE WITH THE CURRENT EDITIONS OF THE FOLLOWING CODES AS ADOPTED BY THE LOCAL GOVERNING AUTHORITIES

CALIFORNIA ADMINISTRATIVE CODE (INCL TITLE 24 & 25)
2016 CALIFORNIA BUILDING CODE
LOCAL BUILDING CODE

CALIFORNIA BUILDING CODE SECTION 1105B.3.4, AND/OR 11B-203.5 OF 2016 CALIFORNIA BUILDING CODE, EXCEPTION 1, THIS FACILITY SHALL BE EXEMPTED FROM ALL TITLE 24 ACCESS

DO NOT SCALE **ACCESSIBILITY NOTE DRAWINGS**

THE FACILITY IS UNMANNED AND NOT FOR HUMAN HABITATION. HANDICAPPED ACCESS REQUIREMENTS ARE NOT REQUIRED IN ACCORDANCE WITH THE 2016 CALIFORNIA BUILDING CODE. A TECHNICIAN WILL VISIT THE SITE AS REQUIRED FOR ROUTINE MAINTENANCE. THE PROJECT WILL NO RESULT IN ANY SIGNIFICANT DISTURBANCE OR EFFECT ON DRAINGE; NO SANITARY SEWER SERVICE. POTABLE WATER, OR TRASH DISPOSAL IS REQUIRED AND NO COMMERCIAL SIGNAGE IS NEW. THE TELECOMMUNICATIONS EQUIPMENT SPACE SHOWN ON THESE PLANS IS NOT CUSTOMARILY OCCUPIED. WORK TO BE PERFORMED IN THIS FACILITY CANNOT REASONABLY BE PERFORMED BY PERSONS WITH A SEVERE IMPAIRMENT: MOBILITY, SIGHT, AND/OR HEARING. THEREFORE, PER 2016

WORK OR BE RESPONSIBLE FOR SAME. IF USING 11"X17" PLOT, DRAWINGS WILL BE HALF SCALE.

SUBCONTRACTOR SHALL VERIEY ALL PLANS

ABBREVIATIONS

AĎJ A.F.F. ARCH	ANCHOR BOLT ASPHALTIC CONCRETE AIR CONDITIONING ADJUSTABLE ABOVE FINISH FLOOR APPROXIMATELY APPROXIMATELY	JT LAM LBS LT LA LNA	JOINT LAMINATED POUNDS LIGHT LIGHTNING ARRESTOR LOW NOISE AMPLIFIER
A.G.L.	ABOVE GRADE LEVEL ABOVE MEAN SEA LEVEL	MFR MAT MAX	MANUFACTURER MATERIAL MAXIMUM
BOT	BOARD BULLDING BULCKING BOTTOM BASEMENT BASE TRANSCEIVER STATION COURSE(S) CEMENT CHAIN LINK CELLING CLEAR COLUMN CONVERTE	MECH MIN MISC ML MO MS MTD MTL	MECHANICAL MINIMUM MISCELLANEOUS METAL LATH MASONRY OPENING
C CEM CL CLG CLR COL	COURSE(S) CEMENT CHAIN LINK CEILING CLEAR COLUMN	(N) NIC NO NTS	NEW NOT IN CONTRACT NUMBER NOT TO SCALE
CONC CONST CONT CORR CO	COLOMN CONCRETE CONSTRUCTION CONTINUOUS CONTINUOUS CONDUIT ONLY	OA O.C. OPNG OPP	OVERALL ON CENTER OPENING OPPOSITE
CO	CONDOIT ONLY	PARTN	PARTITION

PARTN

PL PLAS PLYWD POC PROP PT

R REQD RD RM RMS RO

SC SCHED SECT SHT SIM SPECS SS STL STOR STOR STUCT SUSP SW SWBO

THK TI

UNO

VCT VERT V.I.F. VG

XFMR

@

SYMBOLS:

DTL DWG

GA GALV

GYP GFCI

GND

HSS

HT HV

EXISTING

EVATION OUIPMENT

FACE OF STUDS FINISH SURFACE FOOT, FEET

FINISH WALL FINISH GRADE FUTURE

GAUGE GALVANIZED GLASS

GROLIND

GROUND FAULT CIRCUIT

HOLLOW CORE
HARDWARE
HEATER
HOLLOW METAL
HORIZONTAL
HOUR
HOLLOW STRUCTURAL
SECTION
HEIGHT

HIGH VOLTAGE

INSIDE DIMENSION INSULATION INTERIOR

SECTION NUMBER

- SHEET NUMBER

- DETAIL NUMBER

- SHEET NUMBER

- SECTION NUMBER

- SHEET NUMBER

- DETAIL NUMBER

- SHEET NUMBER

— F— F— F—

----E/F----E/F----

\x-x

PARTITION

RISER REQUIRED ROOF DRAIN

ROOMS ROUGH OPENING

SOLID CORE SCHEDULE SECTION SHEET SIMILAR SPECIFICATIONS STAINLESS STEEL STEFI

TRUCTURAL SUSPENDED

SWITCH SWITCHBOARD

UNLESS NOTED OTHERWISE

VERIFY IN FIELD VERTICAL GRAIN

TRANSFORMER

CHANNEL

ANGLE PROPERTY LINE

BUILDING SECTION REFERENCE

DETAIL REFERENCE

DETAIL SECTION

EXTERIOR FLEVATION

PROPERTY LINE

FLECTRICAL SERVICE

ELECTRICAL/FIBER SERVICE

FIBER SERVICE

FENCING

REFERENCE

CENTERLINE

ΑT

THICK
TENANT IMPROVEMENT
TOWER MOUNTED AMPLIFIER
TOP OF SURFACE
TUBE STEEL
TYPICAL

VINYL COMPOSITION TILE VERTICAL

RESISTANT

PLATE
PLASTER
PLYWOOD
POINT OF CONNECTION
PROPERTY
PRESSURE TREATED

- WILL HAVE WORKED AT HIS/HER OWN HISH AND EXPENSE.

 CONTRACTOR SHALL DETERMINE ACTUAL ROUTING OF CONDUIT, POWER, T1 OR FIBER CABLES, GROUNDING CABLES AS SHOWN ON THE POWER, GROUNDING AND TELCO PLAN DRAWING. CONTRACTOR SHALL UNILIZE EXISTING TRAYS AND/OR SHALL ADD NEW TRAYS AS NECESSARY. CONTRACTOR SHALL CONTRINE THE ACTUAL ROUTING WITH THE CONTRACTOR. ROUTING OF TRENCHING SHALL BE APPROVED BY CONTRACTOR ALL MATERIALS AND CONSTRUCTION SHALL BE IN CONFORMANCE WITH THE BUILDING CODE AND ALL OTHER GOVERNING CODES. THESE NOTES SHALL BE CONSIDERED A PART OF THE WRITTEN SPECIFICATIONS.
 - THE CONTRACTOR SHALL NOTIFY ARCHITECT/ENGINEER OF ANY ERRORS, OMISSIONS, OR DISCREPANCIES AS THEY MAY BE DISCOVERED IN THE PLANS, SPECIFICATIONS, & NOTES PRIOR TO STARTING CONSTRUCTION, INCLUDING BUT NOT LIMITED BY DEMOLITION. THE CONTRACTOR SHALL BE RESPONSIBLE FOR CORRECTING ANY ERROR, OMISSION, OR INCONSISTENCY AFTER THE START OF CONSTRUCTION WHICH HAS NOT OMISSION, ON INCOMPRISED A TEATH OF CONTROLLING MINISTRUS MINISTRUS MEETING METHOD OF THE ARCHITECT/ENGINEER AND SHALL INCUR ANY EXPENSES TO RECTIFY THE SITUATION. THE METHOD OF CORRECTION SHALL BE APPROVED BY THE ARCHITECT/ENGINEER.
 - APPROVED BY THE ARCHITECT/ENGINEER.
 PRIOR TO STARTING CONSTRUCTION THE CONTRACTOR HAS THE RESPONSIBILITY TO LOCATE ALL EXISTING UTILITIES, WHETHER OR NOT SHOWN ON THE PLANS, AND TO PROTECT THEM FROM DAMAGE. THE CONTRACTOR OR SUBCONTRACTOR SHALL BEAR THE EXPENSE OF REPARING OR REPLACING ANY DAMAGE TO THE UTILITIES CAUSED DURING THE EXECUTION OF THE WORK. WHERE REQUIRED FOR THE PROPER EXECUTION OF THE WORK, UTILITIES SHALL BE RELOCATED AS DIRECTED BY ENGINEERS. EXTREME CAUTION SHOULD BE USED BY THE CONTRACTOR WHEN EXCAVATING OR PIER DRILLING AROUND OR NEAR UTILITIES. CONTRACTOR SHALL PROVIDE SAFETY TRAINING FOR THE WORKING CREW.
 - 7. ALL EXISTING INACTIVE SEWER, WATER, GAS, ELECTRIC AND OTHER UTILITIES, WHICH INTERFERE WITH THE EXECUTION OF THE WORK, SHALL BE REMOVED AND SHALL BE CAPPED, PLUGGED OR OTHERWISE DISCONTINUED AT POINTS WHICH WILL NOT INTERFERE WITH THE EXECUTION OF THE WORK, SUBJECT TO THE APPROVAL OF THE
 - ENGINEER.

 8. A COPY OF THE APPROVED PLANS SHALL BE KEPT IN A PLACE SPECIFIED BY THE GOVERNING AGENCY, AND BY LAW SHALL BE AVAILABLE FOR INSPECTION AT ALL TIMES. IT IS THE CONTRACTOR'S RESPONSIBILITY TO ENSURE ALL CONSTRUCTION SET REFLECT THE SAME INFORMATION AS THE APPROVED PLANS. THE CONTRACTOR SHALL ALSO MAINTAIN ONE SET OF PLANS AT THE SITE FOR THE PURPOSE OF DOCUMENTING ALL AS—BULLT (FANNES, REVISIONS, ADDEDNUMS, OR CHANGE ORDERS. THE CONTRACTOR SHALL FORWARD THE AS—BULLT/HIRED DRAWINGS TO THE ARCHITECT/ENGINEER AT THE CONCLUSION OF THE PROJECT.
 - 9. THE CONTRACTOR SHALL BE RESPONSIBLE FOR THE COMPLETE SECURITY OF THE SITE WHILE THE WORK IS IN PROGRESS UNTIL THE JOB IS COMPLETE.

 - THE CONTRACTOR IS RESPONSIBLE TO PROVIDE TEMPORARY POWER, WATER, AND TOILET FACILITIES AS REQUIRED BY THE PROPERTY OWNER OR GOVERNING AGENCY.

 THE CONTRACTOR SHALL BE RESPONSIBLE FOR COMPLYING WITH ALL SAFETY PRECAUTIONS AND REGULATIONS DURING THE WORK. THE ENGINEER WILL NOT ADVISE ON, NOR PROVIDE DIRECTION, AS TO SAFETY PRECAUTIONS AND PROGRAMS.
 - 12. THE CONTRACTOR IS SOLELY RESPONSIBLE FOR ALL CONSTRUCTION MEANS, METHODS, TECHNIQUES, PROCEDURES, SEQUENCING, AND COORDINATING ALL PORTIONS OF THE WORK UNDER THE PROJECT. FURTHERMORE, THE STRUCTURE IS DESIGNED AS A UNIT UPON COMPLETION. THE CONTRACTOR IS RESPONSIBLE FOR FURNISHING ALL TEMPORARY BRACING AND/OR SUPPORT THAT MAY BE REQUIRED AS THE RESULT OF THE CONTRACTOR'S CONSTRUCTION METHODS. THE INVESTIGATION, DESIGN, SAFETY, DEQUACY AND INSPECTION OF BRACING, SHORING, TEMPORARY SUPPORTS, ETC. IS HE SOLE RESPONSIBILITY OF THE CONTRACTOR.
 - 13. THE CONTRACTOR SHALL BE RESPONSIBLE TO OBTAIN AND PAY FOR ALL PERMITS, LICENSES AND INSPECTIONS WITH RESPECT TO THE WORK TO COMPLETE THE PROJECT. BUILDING PERMIT APPLICATIONS SHALL BE FILED BY THE OWNER OR HIS REPRESENTATIVE. CONTRACTOR SHALL OBTAIN THE PERMIT AND MAKE FINAL PAYMENT OF SAID DOCUMENT(S).
 - 14. ALL DIMENSIONS TAKE PRECEDENCE OVER SCALE UNLESS OTHERWISE NOTED.
 - THE CONTRACTOR SHALL PROVIDE ALL NECESSARY FRAMING, BACKING, HANGERS, BLOCKING OR SUPPORTS FOR INSTALLATION OF ITEMS INDICATED ON THE DRAWINGS.
 - NEW CONSTRUCTION ADDED TO EXISTING CONSTRUCTION SHALL BE MATCHED IN FORM, TEXTURE, MATERIAL AND PAINT COLOR EXCEPT AS NOTED IN THE PLANS.
 - WHERE SPECIFIED, MATERIALS TESTING SHALL BE TO THE LATEST STANDARDS AVAILABLE AS REQUIRED BY THE LOCAL GOVERNING AGENCY RESPONSIBLE FOR RECORDING THE RESULTS.
 - ALL GENERAL NOTES AND STANDARD DETAILS ARE THE MINIMUM REQUIREMENTS TO BE USED IN CONDITIONS WHICH ARE NOT SPECIFICALLY SHOWN OTHERWISE.
 - ALL SYMBOLS AND ABBREVIATIONS ARE CONSIDERED CONSTRUCTION INDUSTRY STANDARDS. IF A CONTRACTOR HAS A QUESTION REGARDING THEIR EXACT MEANING, THE ARCHITECT/ENGINEER SHALL BE NOTIFIED FOR CLARIFICATIONS.
 - CONTRACTORS SHALL VISIT THE SITE PRIOR TO BID TO ASCERTAIN CONDITIONS WHICH MAY ADVERSELY AFFECT THE WORK OR COST THEREOF.
 - 21. THE CONTRACTOR SHALL FIELD VERIFY THE DIMENSIONS, ELEVATIONS, ETC. NECESSARY FOR THE PROPER CONSTRUCTION AND ALIGNMENT OF THE NEW PORTION OF THE WORK TO THE EXISTING WORK.
 - 22. REPRESENTATIONS OF TRUE NORTH, OTHER THAN THOSE FOUND ON THE PLOT OF SURVEY DRAWING (SHEET LS1), SHALL NOT BE USED TO IDENTIFY OR ESTABLISH THE BEARING OF TRUE NORTH AT THE SITE. THE CONTRACTOR SHALL RELY SOLELY ON THE PLOT OF SURVEY DRAWING AND ANY SURVEYOR'S MARKINGS AT THE SITE FOR THE PLOT OF SURVEY DRAWING AND ANY SURVEYOR'S MARKINGS AT THE STIE FOR THE ESTABLISHMENT OF TRUE NORTH, AND SHALL NOTIFY THE ARCHITECT/ ENGINEER PRIOR TO PROCEEDING WITH THE WORK. IF ANY DISCREPANCY IS FOUND BETWEEN THE VARIOUS ELEMENTS OF THE WORKING DRAWINGS AND THE TRUE NORTH ORIENTATION AS DEPICTED ON THE CIVIL SURVEY, THE CONTRACTOR SHALL ASSUME SOLE LIABILITY FOR ANY FAILURE TO NOTIFY THE ARCHITECT/ENGINEER.
 - 23. NO CHANGES ARE TO BE MADE TO THESE PLANS WITHOUT THE KNOWLEDGE AND NO CHANGES ARE 10 BE MADE TO THESE PLANS WITHOUT THE KNOWLEDGE AND WRITTEN CONSENT OF THE ARCHITECT/ ENGINEER. UNAUTHORIZED CHANGES RENDER THESE DRAWINGS VOID. THIS INCLUDES THAT THE CONTRACTOR SHALL NOT BE RELIEVED OF ANY DEVIATION FROM THE PLANS BY THE PROFESSIONAL'S OF RECORD REVIEW OF SHOP DRAWINGS, PRODUCT DATA, ETC. UNLESS THE CONTRACTOR HAS SPECIFICALLY INFORMED THE PROFESSIONAL OF RECORD OF SUCH DEVIATION IN WRITING AT THE TIME OF SUBMISSION, AND THE PROFESSIONAL OF RECORD HAS GIVEN WRITTEN APPROVAL TO THE SPECIFIC DEVIATION.
 - 24. ANY REFERENCE TO THE WORDS "APPROVED" OR "APPROVAL" IN THESE DOCUMENTS SHALL BE HERE DEFINED TO MEAN CENERAL ACCEPTANCE OR REVIEW AND SHALL NOT RELIEVE THE CONTRACTOR AND/OR HIS SUB-CONTRACTORS OF ANY LIABILITY IN FURNISHING THE REQUIRED MATERIALS OR LABOR SPECIFIED.
 - 25. KEEP GENERAL AREA CLEAN, HAZARD FREE, AND DISPOSE OF ALL DIRT, DEBRIS, RUBBISH AND REMOVE EQUIPMENT NOT SPECIFIED AS REMAINING ON THE PROPERTY. LEAVE PREMISES IN CLEAN CONDITION AND FREE FROM PAINT SPOTS, DUST OR SMUDGES OF ANY NATURE

CONTRACTOR NOTES: **EQUIPMENT LOCATION**

. PLANS ARE INTENDED TO BE DIAGRAMMATIC OUTLINE ONLY, UNLESS NOTED OTHERWISE.
THE WORK SHALL INCLUDE FURNISHING MATERIALS, EQUIPMENT, APPURTENANCES AND
LABOR NECESSARY TO COMPLETE ALL INSTALLATIONS AS INDICATED ON THE DRAWINGS.

LABOR NECESSARY TO COMPLETE ALL INSTALLATIONS AS INDICATED ON THE DRAWINGS.

2. ALL EXISTING UTILITIES, FACILITIES, CONDITIONS, AND THEIR DIMENSIONS SHOWN ON THE PLAN HAVE BEEN PLOTTED FROM AVAILABLE RECORDS. THE ARCHITECT/ENGINEER AND THE OWNER ASSUME NO RESPONSIBILITY WHATSOEVER AS TO THE SUFFICIENCY OR THE ACCURACY OF THE INFORMATION SHOWN ON THE PLANS, OR THE MANNER OF THEIR REMOVAL, OR ADJUSTMENT. CONTRACTORS SHALL BE RESPONSIBLE FOR DETERMINING EXACT LOCATION OF ALL EXISTING UTILITIES AND FACILITIES PRIOR TO START OF CONSTRUCTION. CONTRACTORS SHALL ALSO OBTAIN FROM EACH UTILITY COMPANY DETAILED INFORMATION RELATIVE TO WORKING SCHEDULES AND METHODS OF REMOVING OR ADJUSTING EXISTING UTILITIES. ANY DISCREPANCIES OR DOUBTS AS TO THE INTERPRETATION OF PLANS SHOULD BE IMMEDIATELY REPORTED TO THE ARCHITECT/ENGINEER FOR RESOLUTION AND INSTRUCTION. AND NO FURTHER WORK

ARCHITECT/ENGINEER FOR RESOLUTION AND INSTRUCTION, AND NO FURTHER WORK SHALL BE PERFORMED UNTIL THE DISCREPANCY IS CHECKED AND CORRECTED BY THE ARCHITECT/ENGINEER. FALUER TO SECURE SUCH INSTRUCTION MEANS CONTRACTOR WILL HAVE WORKED AT HIS/HER OWN RISK AND EXPENSE.

- THE DRAWINGS INDICATE DIAGRAMMATICALLY THE DESIRED LOCATIONS OR ARRANGEMENTS OF CONDUIT RUNS, OUTLETS, EQUIPMENT, ETC., AND ARE TO BE FOLLOWED AS CLOSELY AS POSSIBLE. PROPER DIDDEGMENT MUST BE EXERCISED IN EXECUTING THE WORK SO AS TO SECURE THE BEST POSSIBLE INSTALLATION IN THE AVAILABLE SPACE LIMITATIONS OR INTERFERENCE OF STRUCTURE CONDITIONS
- ENCOUNTERED.

 IN THE EVENT CHANGES IN THE INDICATED LOCATIONS OR ARRANGEMENTS ARE NECESSARY, DUE TO FIELD CONDITIONS IN THE BUILDING CONSTRUCTION OR REARRANGEMENT OF FURNISHINGS OR EQUIPMENT, SUCH CHANGES SHALL BE MADE WITHOUT COST, PROVIDING THE CHANGE IS ORDERED BEFORE THE CONDUIT RUNS, ETC., AND WORK DIRECTLY CONNECTED TO THE SAME IS INSTALLED AND NO EXTRA MATERIALS ARE REQUIRED.
- 3. COORDINATE THE WORK OF THIS SECTION WITH THAT OF ALL OTHER TRADES, WHERE CONFLICTS OCCUR, CONSULT WITH THE RESPECTIVE CONTRACTOR AND COME TO AGREEMENT AS TO CHANGES NECESSARY, OBTAIN WRITTEN ACCEPTANCE FROM ENGINEER FOR THE PROPOSED CHANGES BEFORE

UTILITY SERVICE

- TELEPHONE AND ELECTRICAL METERING FACILITIES SHALL CONFORM TO THE
 REQUIREMENTS OF THE SERVING UTILITY COMPANIES. CONTRACTOR SHALL VERIFY SERVICE
 LOCATIONS AND REQUIREMENTS. SERVICE INFORMATION WILL BE FURNISHED BY THE SERVING UTILITIES.
- 2. CONFORM TO ALL REQUIREMENTS OF THE SERVING UTILITY COMPANIES







C 05/17/2019 SETBACK ADDED B 03/08/2019 100% CD'S SET A 02/01/2019 90% CD'S SET REV DATE DESCRIPTION

ISSUED DATE:

MAY 17, 2019

ISSUED-FOR: -

100% CD SET

LICENSURE: PROFESS/ON WAREL B. 뮏 No. C 83930 (★) * Exp. 9-30-19OF CAL

PROJECT INFORMATION: SOUTH CARMEL 002 LOCATION CODE: 428217 IFO SAN ANTONIO AVE.. 3SE 13TH AVE., CARMEL, CA 93923

DRAWN BY SAM CHECKED BY

SHEET-TITLE:

NOTES AND **SPECIFICATIONS**

SHEET-NUMBER:


T-2



NOTES:

1. THIS IS NOT A BOUNDARY SURVEY. THIS IS A SPECIALIZED TOPOGRAPHIC MAP. THE PROPERTY LINES AND EASEMENTS SHOWN HEREON ARE FROM RECORD INFORMATION AS NOTED HEREON. CELLSITE CONCEPTS TRANSLATED THE TOPOGRAPHIC SURVEY TO RECORD INFORMATION USING FOUND MONUMENTS SHOWN HEREON. THE LOCATION OF PROPERTY LINES SHOWN HEREON ARE APPROXIMATE AND FOR INFORMATIONAL PURPOSES ONLY. THEY ARE NOT TO BE RELIED UPON AS THE ACTUAL BOUNDARY LINES.

- 2. ANY CHANGES MADE TO THE INFORMATION ON THIS PLAN, WITHOUT THE WRITTEN CONSENT OF CELLSITE CONCEPTS, RELIEVES CELLSITE CONCEPTS OF ANY AND ALL LIABILITY.
- 3. THE HEIGHTS AND ELEVATIONS FOR THE TREES, BUSHES AND OTHER LIVING PLANTS SHOWN HEREON, SHOULD BE CONSIDERED APPROXIMATE (+/-) AND ONLY FOR THE DATE OF THIS SURVEY. THEY ARE PROVIDED AS A GENERAL REFERENCE AND SHOULD NOT BE USED FOR DESIGN PURPOSES.
- 4. RIGHT-OF-WAY WAS ESTABLISHED BY LOCATING FOUND CENTERLINE CITY OR COUNTY MONUMENTS. IF CENTERLINE MONUMENTS WERE NOT LOCATABLE, THE CENTERLINE OFFSET TIES WERE USED TO ESTABLISH THE INTERSECTIONS. IF NEITHER CENTERLINE TIES OR CENTERLINE INTERSECTION MONUMENTS WERE LOCATABLE, EXISTING IMPROVEMENTS WERE USED TO ESTABLISH RIGHT—OF—WAY.
- 5. ALL SHOWN RIGHT-OF-WAY WERE BASED UPON RESEARCH AT COUNTY OR CITY FILES AND REFLECT THE LATEST RECORDED MAPS, RECORDS OF SURVEY, PARCEL MAPS OR OTHER RECORDS. RICHT-OF-WAY WILL NOT REFLECT ANY DEDICATION, TAKEN OR OFFERED AFTER THE THE RECORD MAP USED. ALL SURVEYS WERE COMPLETED WITHOUT THE BENEFIT OF A CURRENT TITLE REPORT AND MAY NOT SHOW ADDITIONAL DEDICATIONS NOT SHOWN ON THE RECORD MAPS USED.
- 6. WRITTEN DIMENSIONS SHALL TAKE PREFERENCE OVER SCALED & SHALL BE VERIFIED ON THE JOB SITE. ANY DISCREPANCY SHALL BE BROUGHT TO THE NOTICE OF THE SURVEYOR PRIOR TO COMMENCEMENT OF ANY WORK.
- 7. FIELD SURVEY COMPLETED ON DECEMBER 16, 2018

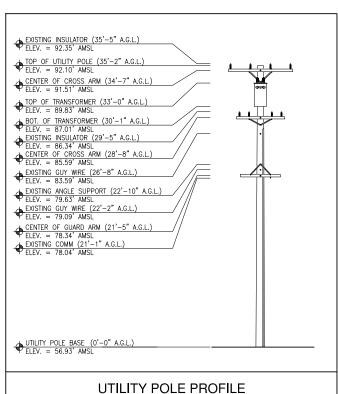

BASIS OF BEARING


THE CENTERLINE OF <u>SAN ANTONIO AVENUE</u> BEARING <u>SOUTH</u> WAS USED AS BASIS OF BEARING FOR THIS SURVEY.

BASIS OF ELEVATIONS: (NAVD 1988)

ELEVATIONS ARE BASED ON CALVRS G.P.S. BROADCAST COORDINATE VALUES FOR 2017, NAVD 88

FLOOD ZONE

SITE IS LOCATED IN FLOOD ZONE "X" AS PER F.I.R.M. MAP NO. 06053C0316H EFFECTIVE DATE 06/21/2017

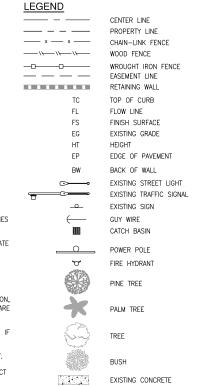


MONUMENTS


COORDINATES

LATITUDE: 36'32'44.72"N (36.545756) LONGITUDE: 121°55'40.02"W (-121.927783)

EXISTING GRASS/TURF

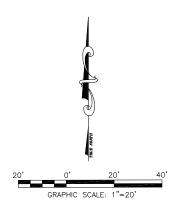

PROPERTY LINES ARE BASED FROM R.O.S. NO. 14-131 DATED JULY 30, 1986 R.O.S. NO. 26-40 DATED FEBRUARY 10, 2003 R.O.S. NO. 21-40 DATED SEPTEMBER 03, 1997 R.O.S. NO. 21-50 DATED 1, 1997

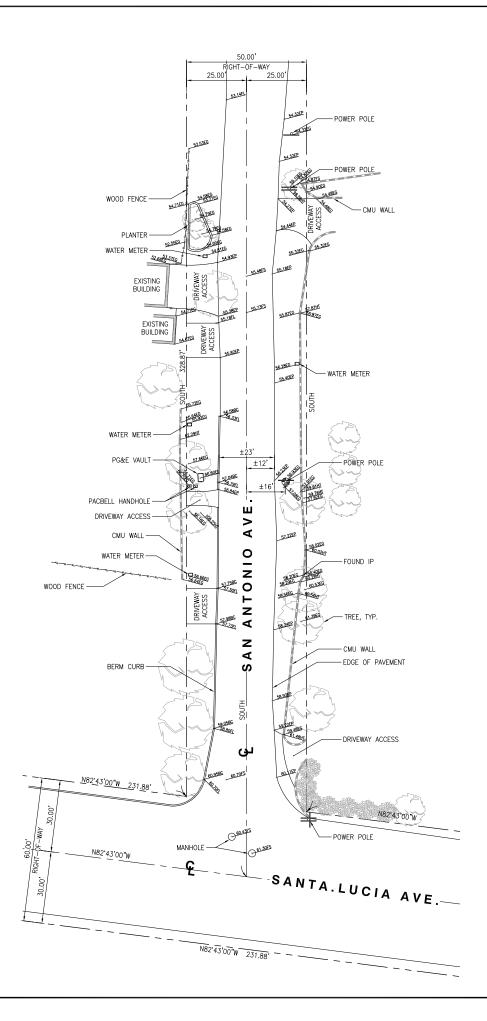







1 | 12/18/2018 | FINAL SURVEY REV DATE DESCRIPTION

ISSUED-DATE: DECEMBER 18, 2018

ISSUED-FOR: -

FINAL SURVEY

LICENSURE: L.S. 8780 Exp. 12/31/20

SOUTH CARMEL 002 LOCATION CODE: 428217 IFO SAN ANTONIO AVE., 3SE 13TH AVE., CARMEL, CA 93923

DRAWN BY

SHEET-TITLE:

TOPOGRAPHIC SURVEY

SHEET-NUMBER:


LS-1

SITE NOTES:

- 1. REPRESENTATIONS OF TRUE NORTH, OTHER THAN THOSE FOUND ON THE PLOT OF SURVEY DRAWINGS SHALL NOT BE USED TO IDENTIFY OR ESTABLISH BEARING OF TRUE NORTH AT THE SITE. THE CONTRACTOR SHALL RELY SOLELY ON THE PLOT OF SURVEY DRAWING AND ANY SURVEYOR'S MARKINGS AT THE SITE FOR THE ESTABLISHMENT OF DRAWING AND AND SHALL NOTIFY THE ARCHITECT/ENGINEER PRIOR TO PROCEEDING WITH THE WORK IF ANY DISCREPANCY IS FOUND BETWEEN THE VARIOUS ELEMENTS OF THE WORKING DRAWINGS AND THE TIVE NORTH ORIENTATION AS DEPICTED ON THE CIVIL SURVEY. THE CONTRACTOR SHALL ASSUME SOLE LIABILITY FOR ANY FAILURE TO NOTIFY THE ARCHITECT/ ENGINEER.
- CONTRACTOR TO VERIFY LOCAL UTILITY REQUIREMENTS FOR DEPTH, SIZES, AND SEPARATION OF CONDUITS PRIOR TO INSTALLATION. NOTIFY CONSTRUCTION MANAGER IMMEDIATELY OF ANY DISCREPANCIES.
- PROPOSED UTILITY SERVICES SHOWN NEED TO BE VERIFIED AND APPROVED BY UTILITY COMPANIES BEFORE START OF CONSTRUCTION. CONTRACTOR TO VERIFY WITH CLIENT PROJECT MANAGER TO OBTAIN FINAL APPROVAL.
- 4. VERIFY, LOCATE, AND PROTECT ALL EXISTING SUBSTRUCTURES AS REQUIRED, CALL DIG ALERT ® (800) 227–2600 48 HOURS BEFORE ANY EXCAVATION. CONTRACTOR IS RESPONSIBLE TO HAVE ALL NON-PUBLIC UTILITIES LOCATED AT THEIR OWN EXPENSE.
- CONTRACTOR SHALL IMMEDIATELY INFORM CLIENT OF ANY ACCIDENTAL DAMAGE TO EXISTING UTILITIES VA PHONE OR EMAIL REGARDLESS OF ABILITY TO REPAIR OR MITIGATE. A FOLLOW-UP EMAIL REPORT WITH DIGITAL PHOTOS WILL BE REQUIRED DAILY UNTIL RESOLUTION HAS BEEN ACCEPTED BY CLIENT, AFFOCTED SERVICE PROVIDERS, AND RECIPIENTS. AT THEIR OWN EXPENSE, CONTRACTOR WILL EXERCISE ALL EFFORTS TO HAVE REPAIRS MADE BY QUALIFIED TECHNICIANS AS APPROVED BY SERVICE PROVIDER.
- REPAIRS MADE BY QUALIFIED TECHNICIANS AS APPRIVED BY SERVICE PROVIDER.

 6. CONTRACTOR SHALL VERIETY ALL EXISTING UTILITIES, BOTH HORIZONTAL AND VERTICALLY, PRIOR TO THE START OF CONSTRUCTION. ANY DISCREPANCIES OR DOUBTS AS TO THE INTERPERTATION OF PLANS SHOULD BE IMMEDIATELY REPORTED TO THE ARCHITECT/ENGINEER FOR RESOLUTION AND INSTRUCTION, AND NO FURTHER WORK SHALL BE REFORMED UNTIL THE DISCREPANCY IS CHECKED AND CORRECTED BY THE ARCHITECT/ENGINEER, FAILURE TO SECURE SUCH INSTRUCTION MEANS CONTRACTOR WILL HAVE WORKED AT HIS/HER OWN RISK AND EXPENSE.
- ALL NEW AND EXISTING UTILITY STRUCTURES ON SITE AND IN AREAS TO BE DISTURBED BY CONSTRUCTION SHALL BE ADJUSTED TO FINISH ELEVATIONS PRIOR TO FINAL INSPECTION OF WORK.
- 8 ANY DRAIN AND YOR FIELD THE ENCOUNTERED/DISTURBED DURING CONSTRUCTION SHALL ANY DRAIN AND /OR FIELD TILE ENCOUNTERED/DISTURBED DURING CONSTRUCTION SHALL
 BE RETURNED TO IT'S ORIGINAL CONDITION PRIOR TO COMPLETION OF WORK, SIZE,
 LOCATION AND TYPE OF ANY UNDERGROUND UTILITIES OR IMPROVEMENTS SHALL BE
 ACCURATELY NOTED AND PLACED ON "AS-BUILT" DRAWINGS BY GENERAL CONTRACTOR,
 AND ISSUED TO THE ARCHITECT OR ENGINEER AT COMPLETION OF PROJECT.
 ALL TEMPORARY EXCAVATIONS FOR THE INSTALLATION OF FOUNDATIONS, UTILITIES, ETC.,
 SHALL BE PROPERLY LAID BACK OR BRACED IN ACCORDANCE WITH THE CORRECT
- OCCUPATIONAL SAFETY AND HEALTH ADMINISTRATION (OSHA) REQUIREMENTS.
- 10. NEW CONDUITS SHALL BE INSTALLED IN TRENCH SUCH THAT THE TOP OF CONDUIT SHALL HAVE A MINIMUM COVER OF 30-INCHES BELOW ADJACENT EDGE OF PAVEMENT OR ORIGINAL GROUND, WHICHEVER IS LOWER IN ELEVATION.
- ALL PULL BOXES SHALL BE PRECAST REINFORCED CONCRETE AND HAVE NON CONDUCTIVE LIDS. EXISTING PULL BOX COVERS THAT ARE MARKED INCORRECTLY SHALL BE REPLACED.
- 12. REGRADE LANDSCAPING AS NEEDED AND REPLACE DAMAGED IRRIGATION LINES WITHIN 24 HOURS.



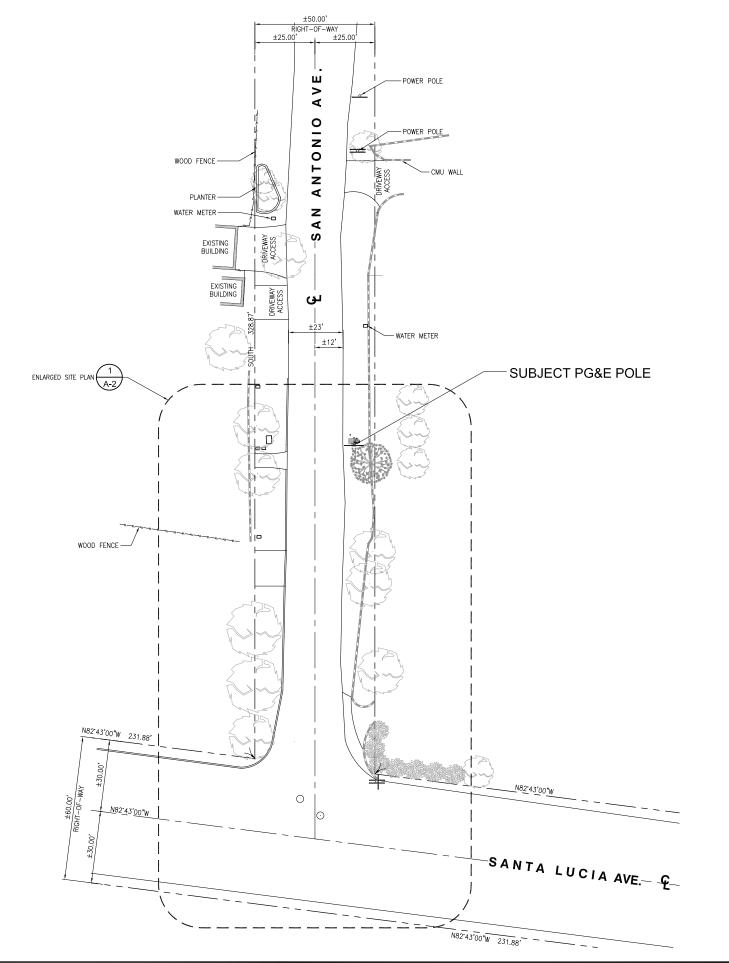







C 05/17/2019 SETBACK ADDED B 03/08/2019 100% CD'S SET A 02/01/2019 90% CD'S SET REV DATE DESCRIPTION

MAY 17, 2019

ISSUED DATE:

ISSUED FOR: -

100% CD SET

LICENSURE: 뮏 No. C 83930 \★\ Exp. 9-30-19

LOCATION CODE: 428217 IFO SAN ANTONIO AVE.. 3SE 13TH AVE., CARMEL, CA 93923

DRAWN BY: CHECKED BY:

SHEET TITLE: -

SITE PLAN

SHEET-NUMBER

A-1


SITE PLAN


24"x36" SCALE: 1" = 20'-0" 11"x17" SCALE: 1" = 40'-0"

UNDERGROUND UTILITIES NOTE:

ENLARGED SITE PLAN

UNDERGROUND UTILITIES NOTE:
ALL EXISTING SUB-SURFACE UTILITIES, FACILITIES, CONDITIONS, AND THEIR
DIMENSIONS SHOWN ON THE PLAN HAVE BEEN PLOTTED FROM FIELD SURVEY
AND/OR AVAILABLE RECORDS, THE ARCHITECT/ ENGINEER AND THE OWNER
ASSUME NO RESPONSIBILITY WHATSOEVER AS TO THE SUFFICIENCY OR THE
ACCURACY OF THE INFORMATION SHOWN ON THE PLANS, OR THE MANNER OF
THEIR REMOVAL OR ADJUSTMENT. CONTRACTORS SHALL BE RESPONSIBLE FOR
THEIR DETERMINING EXACT LOCATION OF ALL EXISTING UTILITIES AND FACILITIES
PRIOR TO START OF CONSTRUCTION. CONTRACTORS SHALL ALSO DETAIN FROM
EACH UTILITY COMPANY DETAILED INFORMATION RELATIVE TO WORKING
SCHEDULES AND METHODS OF REMOVING OR ADJUSTING EXISTING UTILITIES.
THERE MAY BE EXISTING UTILITIES OFTHER THAN THOSE SHOWN ON THIS PLAN.
THE CONTRACTOR IS REQUIRED TO TAKE PRECAUTIONARY MEASURES TO
PROTECT THE UTILITY LINE SHOWN AND ANY OTHER LINES NOT SHOWN ON
THIS PLAN.

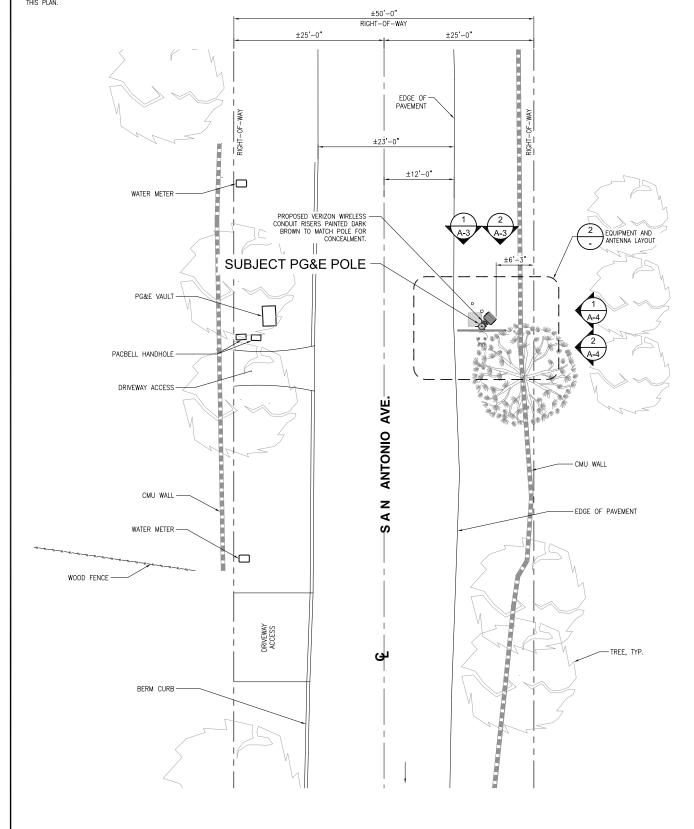

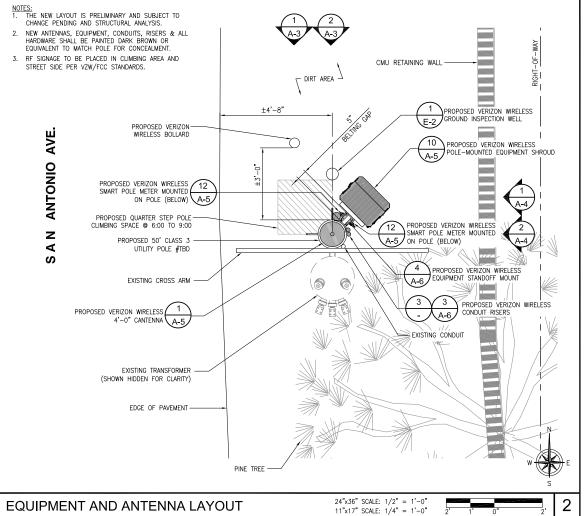

EXISTING POLE INFORMATION PROPOSED POLE INFORMATION POLE HEIGHT: POLE HEIGHT: MATERIAL: MATERIAL: POLE CLASS: POLE TYPE: JOINT UTILITY POLE -EXISTING UTILITY PG&E POLE #TBD TO BE REMOVED AND REPLACED POLE CLASS: YEAR SET: 1966 YEAR SET TRD MAKE-READY SCOPE: VERIZON TO INSTALL (1) SMART POLE METER ON POLE AT 10:30 POSITION. ANTONIO

3. VERIZON TO INSTALL (1) EQUIPMENT SHROUD ON STANDOFF MOUNT AT 10:30 POSITION. 4. VERIZON TO INSTALL (1) POLE TOP MOUNTING BRACKET.

VERIZON TO INSTALL (1) DISTRIBUTION PANEL AND DISCONNECT SWITCH ON STANDOFF MOUNT AT 10:30

5. VERIZON TO INSTALL (1) CANTENNA MOUNTING BRACKET.

6. VERIZON TO INSTALL (1) 4FT CANTENNA ON TOP OF

VERIZON TO INSTALL 2" SCHEDULE 80 PVC POWER RISER AT 12:00 POSITION FROM SERVICE DROP TO

8. VERIZON TO INSTALL 4" SCHEDULE 80 PVC HYBRID RISER AT 9:30 POSITION FROM SHROUD TO ANTENNA.

9. INSTALL 2" SCHEDULE 80 PVC FIBER RISER AT 11:30 POSITION FROM SERVICE DROP TO EQUIPMENT CABINET.

10. VERIZON TO STEP POLE @ 6:00 TO 9:00

11. VERIZON TO PULL, TRANSPORT AND DISPOSE EXISTING


(E) TRANSFORMER GROUND -CONDUIT RISER ALONG POLE **EXISTING POLE** PROPOSED 36"x36" STEE (N) 4" SCH. 80 HYBRID CONDUIT RISER FROM RRUS TOWARDS ANTENNA AVE. (N) 2" SCH. 80 FIBER CONDUIT RISER TOWARDS FIBER PATCH PANEL ANTONIO -(N) 2" SCH, 80 POWER PROPOSED VERIZON
WIRELESS POLE STEPS
A-5 CONDUIT RISER (E) CONDUIT RISER ALONG POLE PROPOSED VERIZON -(E) TRANSFORMER GROUND WIRELESS RF SIGNAGE PER SAN CONDUIT RISER ALONG POLE VZW STANDARDS (2) TOTAL PROPOSED 50' CLASS 3 -UTILITY POLE, # TBD

PROPOSED POLE







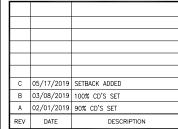

ISSUED DATE: MAY 17, 2019

ISSUED FOR: -

(E) CONDUIT RISER

ALONG POLE

24"x36" SCALE: NTS

11"x17" SCALE: NTS

100% CD SET

LICENSURE: 뮏 No. C 83930 (★) Exp. 9 - 30 - 19

PROJECT INFORMATION: SOUTH CARMEL 002 LOCATION CODE: 428217 IFO SAN ANTONIO AVE.. 3SE 13TH AVE., CARMEL, CA 93923


CHECKED BY:

ENLARGED SITE PLAN AND EQUIPMENT ANTENNA LAYOUT

SHEET-NUMBER

A-2

8' 6' 4' 2' 0"

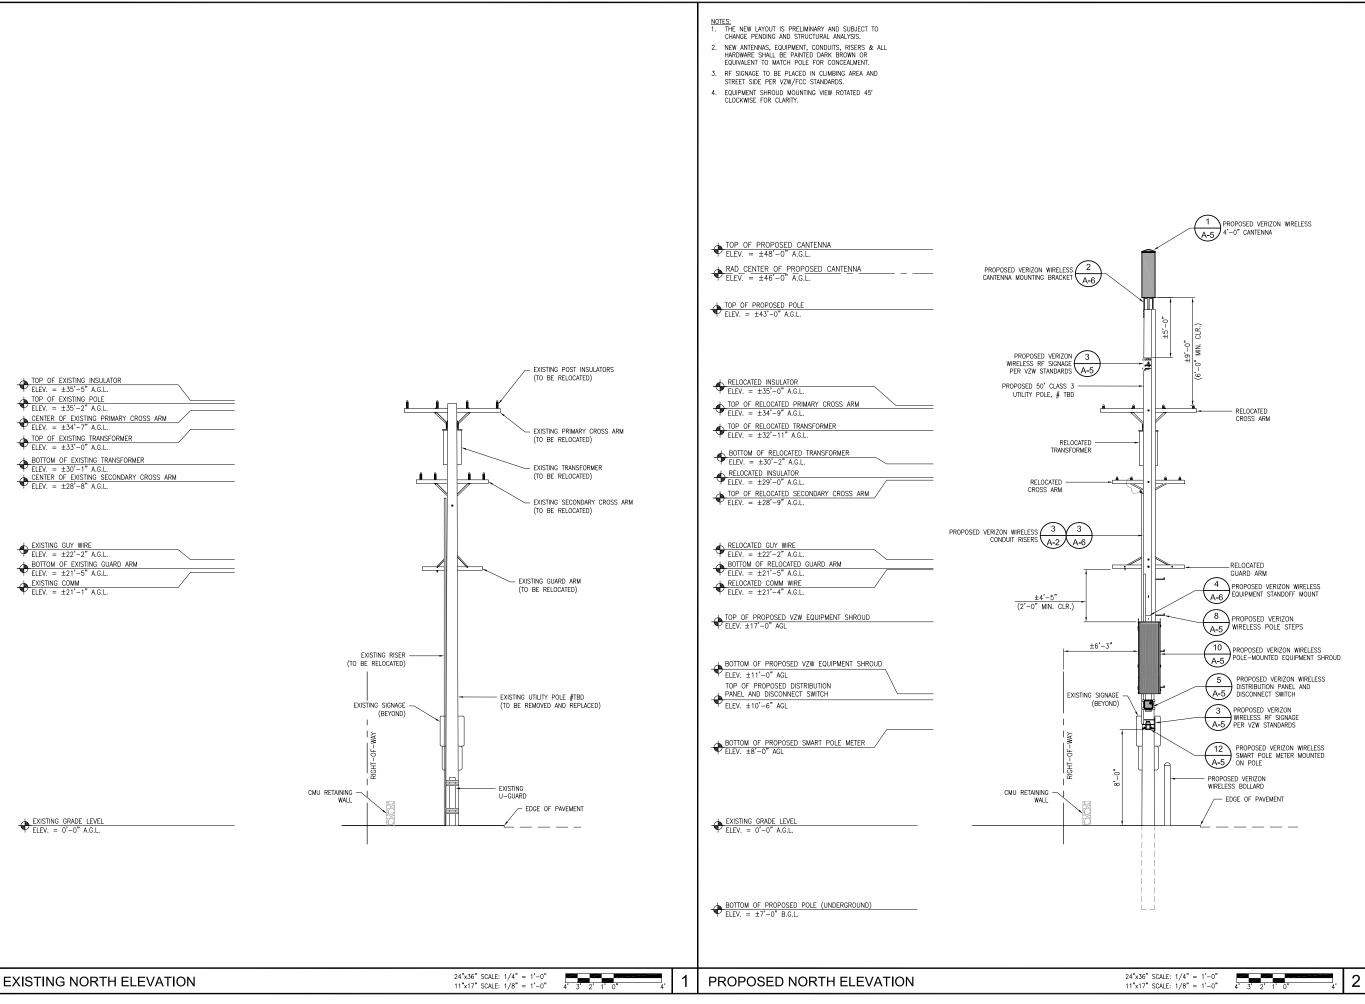







C 05/17/2019 SETBACK ADDED
B 03/08/2019 100% CD'S SET
A 02/01/2019 90% CD'S SET
REV DATE DESCRIPTION

MAY 17, 2019

ISSUED FOR: -

100% CD SET

No. C 83930 Exp. 9-30-19 ★

PROJECT INFORMATION:

SOUTH CARMEL 002

LOCATION CODE: 428217

IFO SAN ANTONIO AVE.,

3SE 13TH AVE.,


CARMEL, CA 93923

	DRAWN BY:	SAM
	CHECKED BY:	RGG
Ι΄	OUEST TITLE	

SHEET-TITLE:

ARCHITECTURAL ELEVATIONS

SHEET NUMBER: -

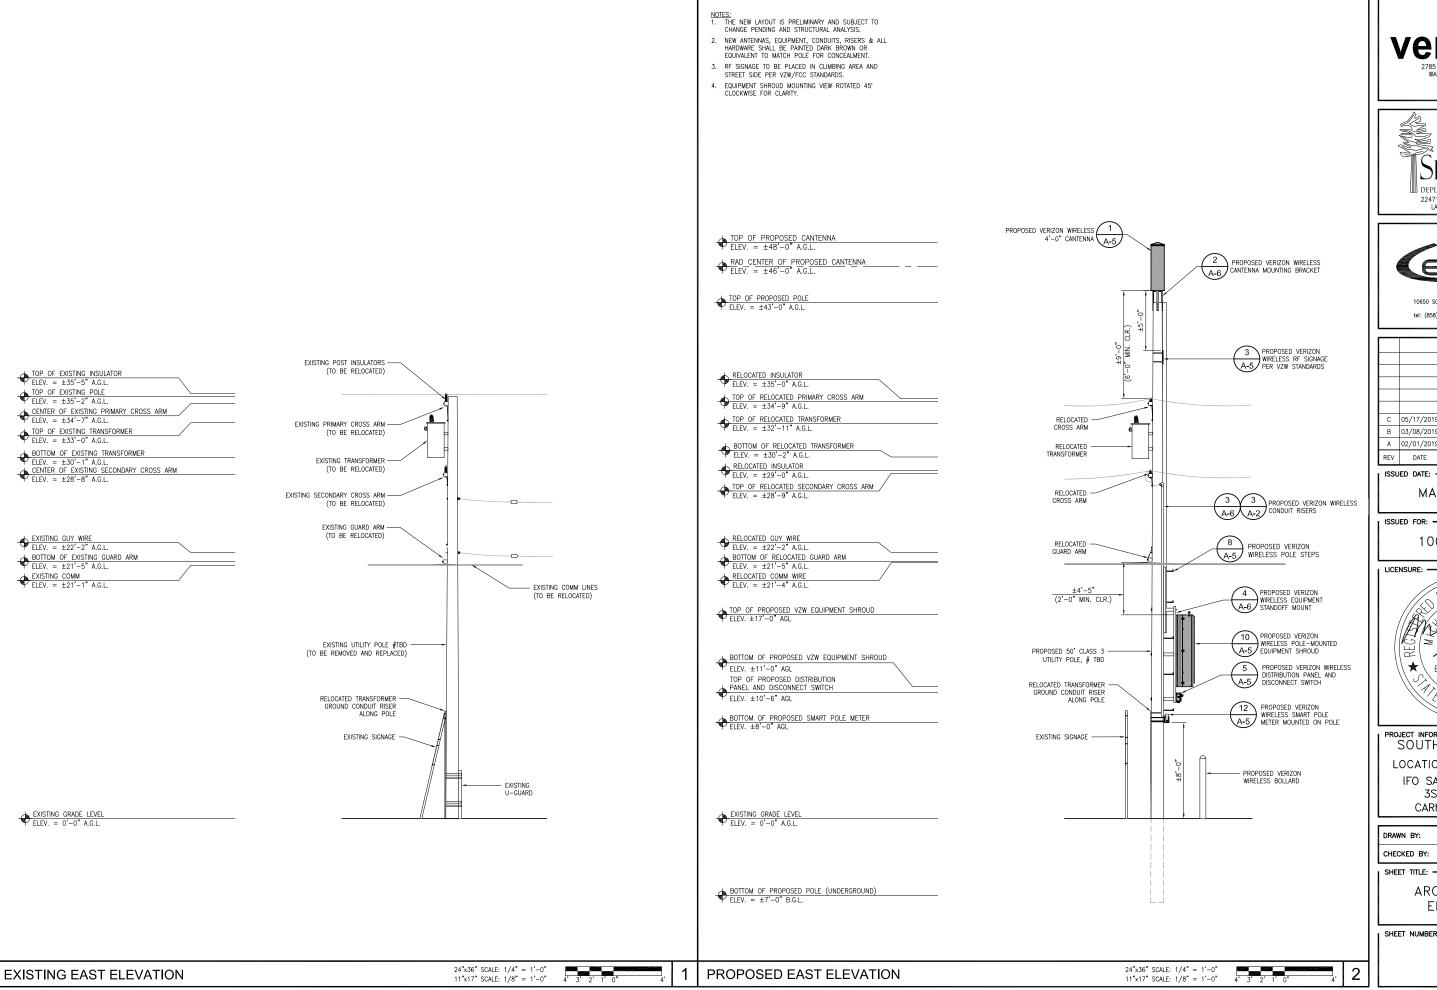







C 05/17/2019 SETBACK ADDED B 03/08/2019 100% CD'S SET A 02/01/2019 90% CD'S SET REV DATE DESCRIPTION

MAY 17, 2019

100% CD SET

LICENSURE: -PROFESS/ON B. B. 묎 No. C 83930 (★\ Exp. 9-30-19 / OF CALIFORNIA


PROJECT INFORMATION: -SOUTH CARMEL 002 LOCATION CODE: 428217 IFO SAN ANTONIO AVE., 3SE 13TH AVE., CARMEL, CA 93923

DRAWN BY:	SAM
CHECKED BY:	RGG

SHEET-TITLE: -

ARCHITECTURAL ELEVATIONS

SHEET-NUMBER:

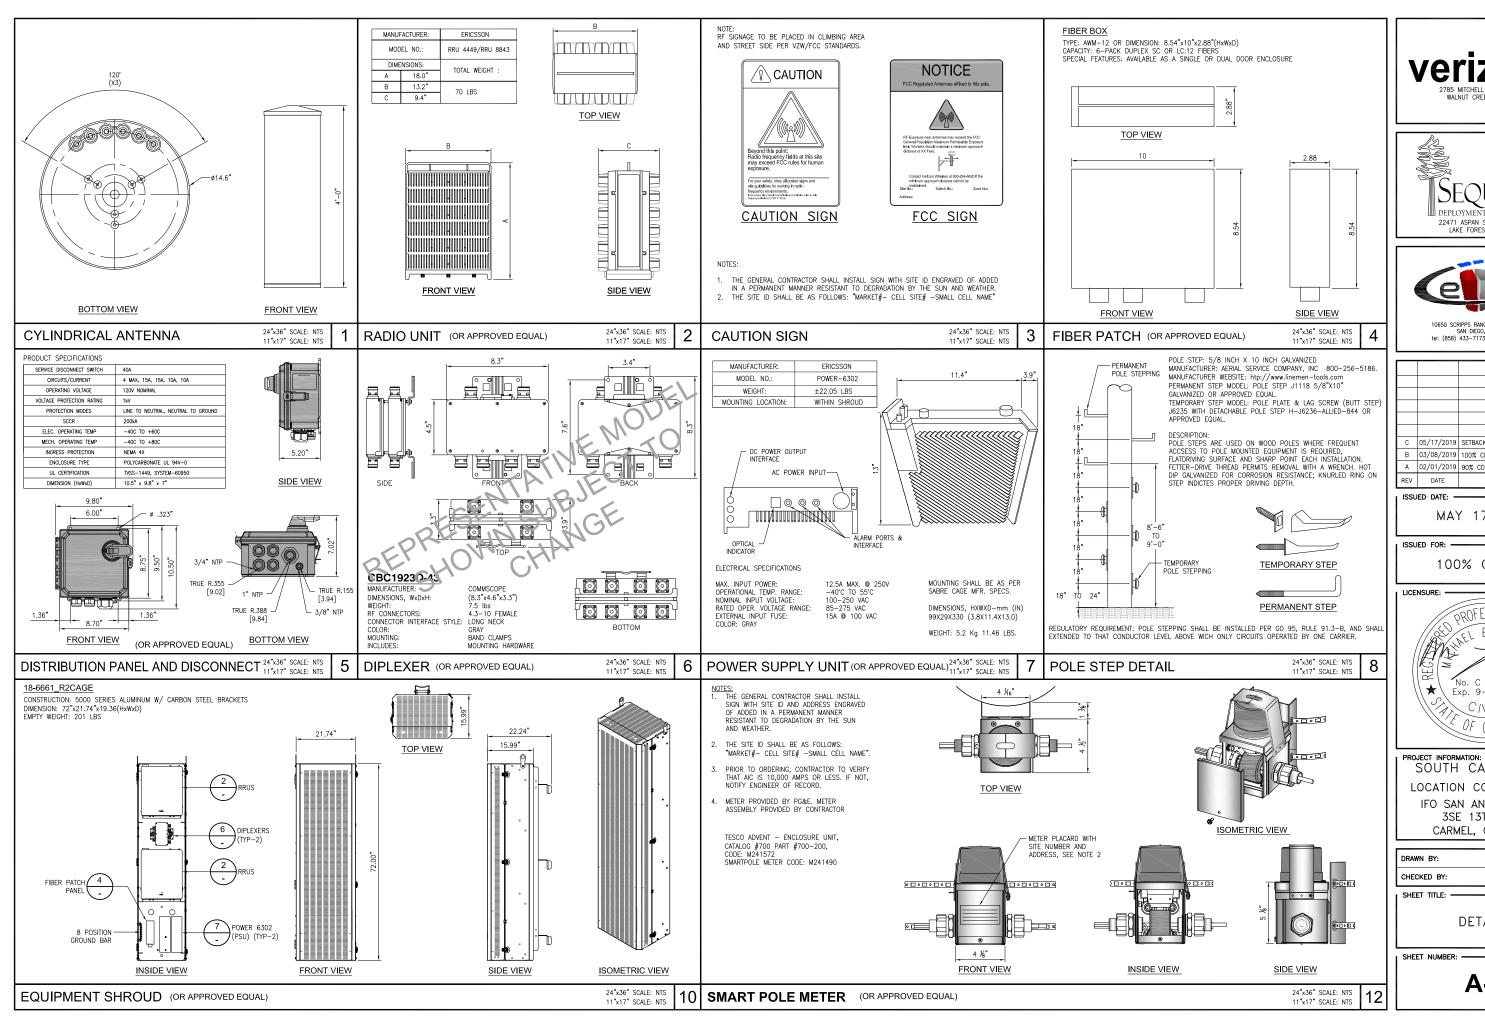





C 05/17/2019 SETBACK ADDED B 03/08/2019 100% CD'S SET A 02/01/2019 90% CD'S SET DESCRIPTION

MAY 17, 2019


100% CD SET

No. C 83930 Exp. 9 - 30 - 19

SOUTH CARMEL 002 LOCATION CODE: 428217 IFO SAN ANTONIO AVE.. 3SE 13TH AVE., CARMEL, CA 93923

DRAWN BY:	SAM
CHECKED BY:	RGG
. CHEET TITLE.	

DETAILS

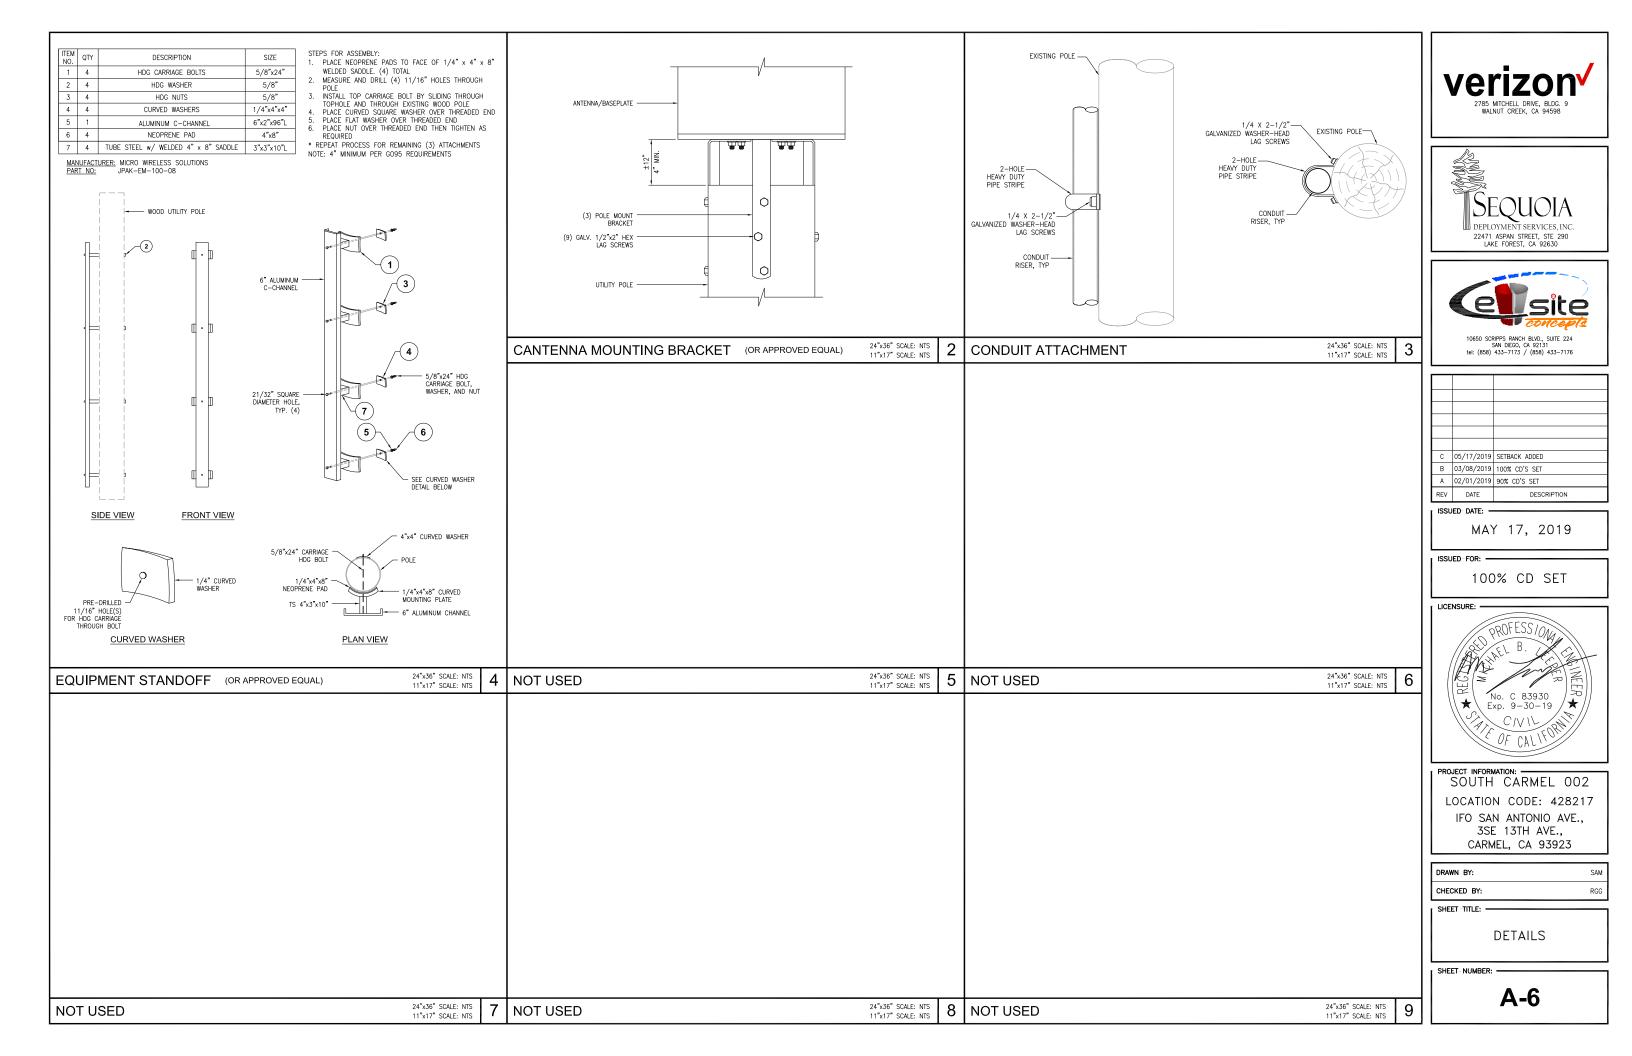

ELECTRICAL NOTES

- THIS INSTALLATION SHALL COMPLY WITH THE CURRENTLY ADOPTED EDITION OF THE CALIFORNIA ELECTRICAL CODE (CEC), WITH THE UTILITY COMPANY AND LOCAL CODE RECHIREMENTS
- POWER, CONTROL AND FOUIPMENT GROUND WIRING IN CONDUIT SHALL BE SINGLE CONDUCTOR (#12 AWG AND LARGER), 600V, OIL RESISTANT THHN OR THWN-2, CLASS B STRANDED COPPER CABLE RATED FOR 90°C (WET AND DRY) OPERATION; LISTED OR LABELED FOR THE LOCATION AND RACEWAY SYSTEM USED.
- CUT, COIL AND TAPE A 3 FOOT PIGTAIL FROM END OF LFMC FOR TERMINATING AT EQUIPMENT, IF REQUIRED.
- SUPPLEMENTAL EQUIPMENT GROUND WIRING LOCATED OUTDOORS OR BELOW GRADE SHALL BE SINGLE CONDUCTOR #2 AWG SOLID, TINNED, COPPER WIRE
- ALL POWER AND GROUNDING CONNECTIONS SHALL BE CRIMP STYLE, COMPRESSION, WIRE LUGS AND WIRENUTS BY THOMAS AND BETTS (OR EQUAL). LUGS AND WIRENUTS SHALL BE RATED FOR OPERATION AT NO LESS THAN 75°C.
- ALL ELECTRICAL COMPONENTS SHALL BE CLEARLY LABELED WITH ENGRAVED LAMINATED PLASTIC LABELS. ALL EQUIPMENT SHALL BE LABELED WITH THEIR VOLTAGE RATING, PHASE CONFIGURATION, WIRE CONFIGURATION, POWER OR AMPACITY RATING AND BRANCH CIRCUIT ID NUMBERS (PANELBOARD AND CIRCUIT IDENTIFICATION).
- 7. ALL CONDUIT RUN ABOVE GROUND OR EXPOSED SHALL BE RIGID STEEL.
- CABINETS, BOXES AND WIREWAYS SHALL BE LISTED OR LABELED FOR ELECTRICAL USE IN ACCORDANCE WITH NEMA, UL, ANSI/IEEE AND CEC.
- PROVIDE NECESSARY TAGGING ON THE BREAKERS CARLES AND DISTRIBUTION PANELS N ACCORDANCE WITH APPLICABLE CODES AND STANDARDS TO SAFEGUARD LIFE AND
- ALL ELECTRODE SYSTEMS (INCLUDING TELECOMMUNICATION, RADIO, LIGHTNING PROTECTION AND AC POWER) SHALL BE BONDED TOGETHER AT OR BELOW GRADE BY TWO OR MORE COPPER BONDING CONDUCTORS IN ACCORDANCE WITH THE CEC.
- PERFORM IFFE FALL-OF-POTENTIAL RESISTANCE TO FARTH TESTING (PER IFFE 1100 PERFORM IEEE FALL—OF—POTAINER RESISTANCE TO EARTH TESTING FER IEEE THOU AND 81) FOR NEW GROUND ELECTRODE SYSTEMS. THE CONTRACTOR SHALL FURNISH AND INSTALL SUPPLEMENTAL GROUND ELECTRODES AS NEEDED TO ACHIEVE A TEST RESULT OF 5 OHMS OR LESS.
- METAL RACEWAY SHALL NOT BE USED AS THE CEC REQUIRED EQUIPMENT GROUND CONDUCTOR. STRANDED COPPER CONDUCTORS WITH GREEN INSULATION SIZED IN ACCORDANCE WITH THE CEC SHALL BE FURNISHED AND INSTALLED WITH THE POWER CIRCUITS TO FOUIPMENT.
- 13. EXPOSED GROUND CONNECTIONS SHALL BE MADE WITH COMPRESSION CONNECTORS WHICH ARE THEN BOLTED TO EQUIPMENT USING STAINLESS STEEL HARDWARE. INSTALLATION TORQUE SHALL BE PER MANUFACTURER'S REQUIREMENTS.
- PROVIDE SUPPORTING DEVICES FOR ALL ELECTRICAL EQUIPMENT, FIXTURES, BOXES, PANEL, FIC., SUPPORT LUMINARIES FROM UNDERSIDE OF STRUCTURAL CELIAGO, EQUIPMENT SHALL BE BRACED TO WITHSTAND HORIZONTAL FORCES IN ACCORDANCE WITH STATE AND LOCAL CODE REQUIREMENTS. PROVIDE PRIOR ALIGNMENT AND LEVELING OF ALL DEVICES AND FIXTURES.

POLE CONSTRUCTION NOTES:

- METER SHALL NOT FACE THE STREET, ALLEY, OR PROPERTY SIDE OF THE POLE.
- METER BASE AND DISCONNECT SHALL BE BONDED TO A SEPARATE GROUND FROM THE POLE GROUND WITH CONDUCTOR HAVING A CURRENT CAPACITY THAN NO LESS THAN #6 SOLID COPPER CONDUCTOR.
- 3. EQUIPMENT CANNOT OVERHANG THE ROADWAY.
- 4. VERIFY AND RECORD ALL CHANGES AND FOOTAGES IN FIELD ON THE FINAL AS-BUILT DRAWINGS.
- 5. GROUNDS ARE TO BE TESTED: REQUIRES 5 OHMS OR LESS RESISTANCE.
- 6. ALL LANDSCAPING TO BE RESTORED TO ORIGINAL CONDITION. 7. NOTIFY PROPERTY OWNER BEFORE WORKING ON OR AROUND PRIVATE PROPERTY.
- 8. OBTAIN SPECIAL PERMITS AND PAY FEES AS REQUIRED WHEN WORKING ON CITY AND
- 9. MAINTAIN 36" MINIMUM COVER IN PARKWAY
- 10. MAINTAIN 30" MINIMUM COVER BELOW GUTTER GRADE ON SURFACE STREETS.
- 11. CONDUITS MAY BE MOUNTED DIRECTLY TO THE POLE OR U-GUARD MAY BE USED IF THE POLE IS WITHIN 15" OF A BUCKET TRUCK ACCESSIBLE PAVED ROAD. IF NOT ACCESSIBLE AND THE CONDUIT IS GREATER THAN 1-1/2", THE CONDUIT IS OF BE MOUNTED WITH A STANDOFF BRACKET THAT PROVIDES 7" CLEARANCE FROM THE POLE TO THE CONDUIT.
- 12. CONTRACTOR TO PROVIDE MOUNTS OR ADDITIONAL HARDWARE IF REQUIRED FOR INSTALLATION OF PROPOSED ANTENNAS.

13. <u>CONDUIT REQUIREMENTS:</u>
UNDERGROUND — SCHEDULE 40 PVC OR BETTER
RISERS — SCHEDULE 80 PVC WITH FIRST 10' ABOVE GROUND LEVEL TO BE RGS FOR PROTECTION PURPOSES. ALL CONDUITS WILL BE MANDRELED AND EQUIPPED WITH 3/8" PULL ROPE AND MEASURE TAPE IF REQUIRED.

GROUNDING NOTES

- ALL DETAILS ARE SHOWN IN GENERAL TERMS. ACTUAL GROUNDING INSTALLATION REQUIREMENTS AND CONSTRUCTION SHALL BE ACCORDING TO SITE CONDITIONS.
- ALL GROUNDING CONDUCTORS: #2 AWG SOLID BARE TINNED COPPER WIRE UNLESS OTHERWISE NOTED.
- GROUND BAR LOCATED IN BASE OF FOUIPMENT WILL BE PROVIDED. FURNISHED AND INSTALLED BY THE VENDOR
- ALL BELOW GRADE CONNECTIONS: EXOTHERMIC WELD TYPE, ABOVE GRADE CONNECTIONS: MECHANICAL/ CONNECTIONS U.N.O.
- INSTALL GROUND CONDUCTORS AND GROUND ROD MINIMUM OF 1'-0" FROM EQUIPMENT CONCRETE SLAB, SPREAD FOOTING, OR FENCE.
- ALL GROUNDING INSTALLATIONS AND CONNECTIONS SHALL BE MADE BY ELECTRICAL
- ALL GROUNDING FOR ANTENNAS SHALL BE CONNECTED SO THAT IT WILL BY-PASS MAIN BUSS BAR.
- USE SEPARATE HOLES FOR GROUNDING AT BUSS BAR. NO "DOUBLE-UP" OR BACK TO BACK LUGS.
- NO LB'S ALLOWED ON GROUNDING.
- PROVIDE STAINLESS STEEL CLAMP AND BRASS TAGS ON ANY COAX AT ANTENNAS AND RADIOS.
- ALL ELECTRICAL AND GROUNDING AT THE CELL SITE SHALL COMPLY WITH THE CALIFORNIA ELECTRICAL CODE (CEC).
- EXOTHERMIC WELDING IS REQUIRED FOR GROUNDING BELOW GRADE CONNECTIONS
- MECHANICAL, ABOVE GRADE CONNECTIONS MAY BE MADE USING COMPRESSION TYPE-2 HOLES. LONG BARREL LUGS OR DOUBLE CRIMP CLAMP "C" CLAMP. THE COPPER CABLES SHALL BE COATED WITH ANTIOXIDANT (COPPER SHIELD) BEFORE MAKING THE CONNECTIONS. THE MANUFACTURER'S TORQUE RECOMMENDATIONS ON THE BOLT ASSEMBLY TO SECURE CONNECTIONS SHALL BE FOLLOWED. ALL TWO HOLE LONG BARREL LUGS SHALL HAVE VIEW PORTS TO ENSURE PROPER
- PROVIDE PVC SLEEVES FOR GROUNDING CONDUCTORS AS NEEDED.
- 15. GROUND ANTENNA BASES, FRAMES, CABLE RACKS AND OTHER METALLIC COMPONENTS WITH #2 GROUNDING CONDUCTORS AND CONNECT TO INSULATED SURFACE MOUNTED GROUND BARS. CONNECTION DETAILS SHALL FOLLOW MANUFACTURER'S SPECIFICATIONS FOR GROUNDING
- 16. PERFORM IEEE FALL-OF-POTENTIAL RESISTANCE TO EARTH TESTING (PER IEEE 1100 AND 81) FOR NEW GROUND ELECTRODE SYSTEMS. THE SUBCONTRACTOR SHALL FURNISH AND INSTALL SUPPLEMENTAL GROUND ELECTRODES AS NEEDED TO ACHIEVE A TEST RESULT OF 5 OHMS OR LESS.
- 17. SURFACES TO BE CONNECTED TO GROUND CONDUCTORS SHALL BE CLEANED TO A BRIGHT SURFACE AT ALL CONNECTIONS.

18 GROUND REQUIREMENTS:

GROUND REQUIREMENTS:
5/8" SS, COPPER CLAD GROUNDING ROD—10' LENGTH
GROUND TESTED AT 5 OHMS OR LESS
#2 GROUND WIRE, SOLID, TINNED

HARDWOOD MOLDING, STAPLED TO POLE EVERY 2'-0" AND AT EACH END GROUND RODS MUST BE 24" FROM POLE AND THE TOP OF ROD MUST BE BELOW GRADE LEVEL PER PLAN DETAILS.

M UTILITY METER

FUSE

CIRCUIT BREAKER

■ DUPLEX RECEPTACLE WITH GFCI

IN WEATHERPROOF ENCLOSURE

CLAMP OR DOUBLE HOLE LUG

TYPE GROUND CONNECTION

EXOTHERMIC CONNECTION TO

DISCONNECT SWITCH

LEGEND SYMBOLS:

GROUNDING WIRE, DASHED LINE

AC POWER LINE, DASHED INDICATES UNDERGROUND

DC POWER LINE, DASHED INDICATES UNDERGROUND TELEPHONE LINE, DASHED LINE

INDICATES UNDERGROUND COAXIAL CABLE, DASHED LINE NDICATES UNDERGROUND

FIBER CABLE, DASHED LINE INDICATES UNDERGROUND

 $\frac{2}{E3}$

DETAIL REFERENCE DETAIL NO. 2 ON SHEET E3


 \otimes GROUND ROD

 \boxtimes GROUND ROD WITH ACCESS

- . ALL CONDUIT ROUTING IS SCHEMATIC. CONTRACTOR SHALL INSTALL CONDUITS SO THAT ACCESS TO EQUIPMENT IS NOT IMPEDED.
- 2 CONDUIT SIZES INDICATED ON THE DRAWINGS ARE NOT NECESSARILY BASED ON THE MINIMUM CONDUIT SIZES INDICATED ON THE DRAWINGS ARE NOT NECESSARILE BASED ON THE MINIMUM SIZE ALLOWED BY THE CEC AND MAY BE PURPOSELY OVERSIZED FOR FUTURE CONDUCTORS OR TO AVOID CONDUCTOR HEATING. CONDUIT SIZES NOT CALLED OUT ON THE DRAWINGS SHALL BE SIZED BY THE CONTRACTOR, BASED ON THE ACTUAL NUMBER OF CONDUCTORS TO BE INSTALLED, USING THE CEC AS A GUIDE. IN NO CASE SHALL CONDUIT SIZES BE SMALLER THAN 1/2
- 3. THE CONTRACTOR SHALL PROVIDE AND INSTALL ALL JUNCTION AND PULLBOXES REQUIRED FOR THE INSTALLATION OF ELECTRICAL DEVICES AND EQUIPMENT, WHETHER OR NOT SPECIFICALLY INDICATED ON THE PLANS. SIZING OF THESE BOXES SHALL BE PER THE CEC.
- ALL ELECTRICAL WORK SHALL BE CONSTRUCTED IN ACCORDANCE WITH PROJECT SPECIFICATIONS AND ALL APPLICABLE LOCAL CODES AND REGULATIONS.
- UTILITY ELECTRICAL SERVICE WILL BE 120/240 VOLTS OR 120/208 VOLTS, SINGLE PHASE, MIN. 30 AMPS CAPACITY. SEE PLANS FOR DETAILS.
- 6 PROJECT CONDITIONS MAY REQUIRE REARRANGEMENT OF ELECTRICAL WORK. THE SUBCONTRACTOR SHALL INDICATE SUCH CHANGES ON THE AS-BUILT DRAWINGS. WHERE CHANGES REQUIRE ALTERNATE METHODS TO THOSE SPECIFIED IN THE PLANS, THE SUBCONTRACTOR SHALL REQUEST APPROVAL. AND SHALL NOT PROCEED UNTIL APPROVAL IS OBTAINED.
- CONTRACTOR SHALL PAINT ALL EXPOSED EXTERIOR CONDUITS AND JUNCTION BOXES TO MATCH EXISTING FINISH ON WHICH THEY ARE ATTACHED.
- 8 FIRER TRUNKS AND/OR BACKHAUL LENGTHS AND ROLLTES ARE NOT VERIFIED DURING THE SITE WALK CONTRACTOR TO VERIFY ACTUAL ROUTE AND TRUNK LENGTH DURING PRE-CONSTRUCTION WALF
- O. CONTRACTOR SHALL COORDINATE WITH UTILITY COMPANY FOR FINAL AND EXACT WORK/MATERIALS REQUIREMENTS AND CONSTRUCT TO UTILITY ENGINEERING PLANS AND SPECIFICATIONS ONLY WHERE APPLICABLE PER PROJECT SCOPE OF WORK.
- 10. CONTRACTOR SHALL FURNISH AND INSTALL CONDUIT, PULL WIRES, CABLE PULL BOXES, CONCRETE ENCASEMENT OF CONDUIT, TRANSFORMER PAD, BARRIERS, POLE RISER TRENCHING, BACK FILL, AND UTILITY FEES, AND INCLUDE REQUIREMENTS IN SCOPE.
- 11. TEST ALL ELECTRICAL & GROUNDING SYSTEMS (CONTINUITY, MEGGER, ETC.) UPON COMPLETION OF INSTALLATION PRIOR TO FINALIZING WORK.
- CONTRACTOR TO VERIFY ALL CONDUIT ROUTING FOR, (N) VZW METER AND (N) GROUND ROD LOCATION WITH LANDLORD AND UTILITY COORDINATOR IN FIELD.
- 13. CONDUIT REQUIREMENTS (TYP., U.N.O.): UNDERGROUND: PVC (SCHED. 40 OR 80). INDOOR: EMT (RGS TRAFFIC AREAS). OUTDOOR: (ABOVE GRADE) RGS.
- 14. PROVIDE A MIN. 36" WORK CLEARANCE IN FRONT OF PANELS/ ELECTRICAL EQUIPMENT.

BREAKER LEGEND					
CIRCUIT #	CUIT # DESCRIPTION ACB /		#POLES		
1	PSU #1	15A 1P	10A 2P		
2	PSU #2	15A 1P	10A 2P		
3	SPARE	10A 1P	-		
,	SPAIL	TUA IF	-		
4	SPARE	10A 1P	-		
*	SPARE	TOA IF	_		

SINGLE LINE DIAGRAM

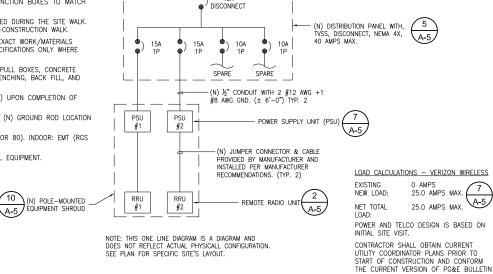

PG&E POWER SOURCE 120 VAC, 1PHASE 40 AMPS MIN. (FROM PG&E SERVICE DROP ON POLE)

A-3

PG&E REQUIREMENTS FOR

(N) SMART POLE WATTHOUR (SMART POLE METER), 3-WIRE 1-PHASE 120/240v 12

TD-027911B-002

AVAILABLE FAULT CURRENT PER LITHLITY

24"x36" SCALE: NTS

11"x17" SCALE: NTS

60 AMP CT METER WITH POLE MOUNT

MANUFACTURER RECOMMENDATIONS ON

ASSEMBLY GROUND METER PER

(N) OVER HEAD SERVICE







C 05/17/2019 SETBACK ADDED B 03/08/2019 100% CD'S SET A 02/01/2019 90% CD'S SET REV DATE DESCRIPTION

ISSUED DATE:

A-5

MAY 17, 2019

ISSUED-FOR: -

100% CD SET

LICENSURE:



PROJECT INFORMATION: SOUTH CARMEL 002 LOCATION CODE: 428217 IFO SAN ANTONIO AVF.. 3SE 13TH AVE., CARMEL, CA 93923

DRAWN RY SAN CHECKED BY

SHEET-TITLE:


ELECTRICAL NOTES AND SINGLE LINE DIAGRAM

SHEET NUMBER:

E-1

11"x17" SCALE: NTS

24"x36" SCALE: NTS **NOT USED** 2

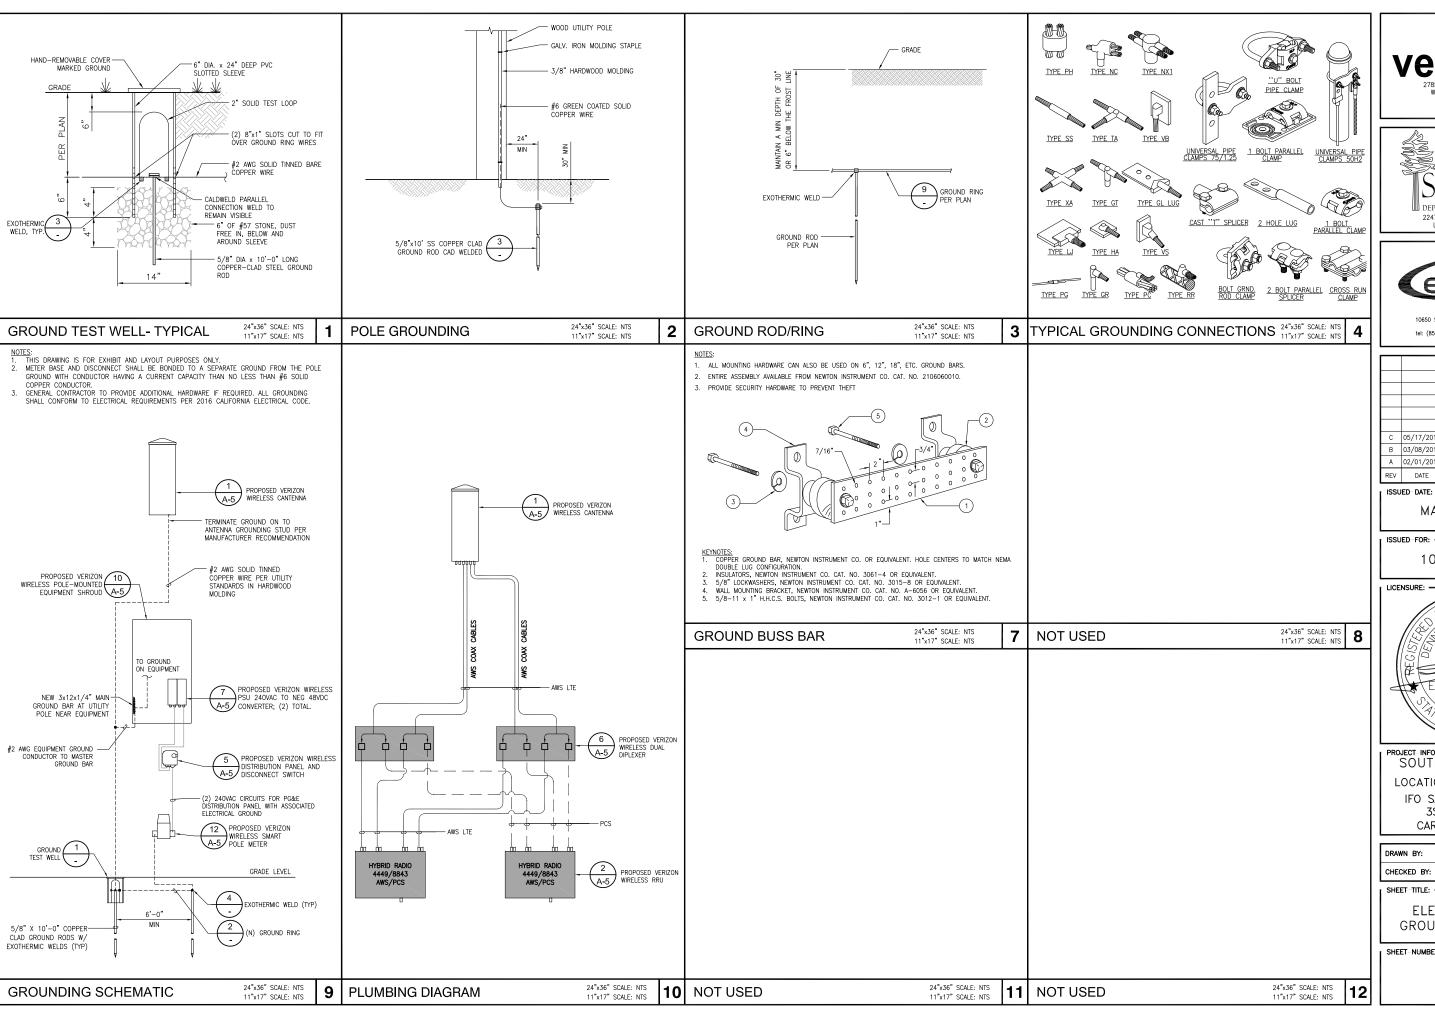







Ι.			
П			
П			
П	С	05/17/2019	SETBACK ADDED
П	В	03/08/2019	100% CD'S SET
П	Α	02/01/2019	90% CD'S SET

ISSUED DATE:

MAY 17, 2019

DESCRIPTION

ISSUED FOR: -

100% CD SET



SOUTH CARMEL 002 LOCATION CODE: 428217 IFO SAN ANTONIO AVE.. 3SE 13TH AVE., CARMEL, CA 93923

DRAWN BY:	SAM
CHECKED BY:	RGG

SHEET TITLE: -

ELECTRICAL AND GROUNDING DETAILS

SHEET NUMBER:

E-2



SITE INFORMATION

PACIFIC GAS & ELECTRIC 245 MARKET ST., MAIL CODE N10D SAN FRANCISCO, CA 94105 CONTACT: DAVID ZENNER PH: (415) 847-0283

APPLICANT:

VERIZON WIRELESS 2785 MITCHELL DRIVE, BLDG. 9 WALNUT CREEK, CA 94598

LATITUDE (NAD 83): LONGITUDE (NAD 83): GROUND ELEVATION

±169.31' AMSI CITY OF CARMEL BY THE SEA ZONING JURISDICTION UNMANNED TELECOMMUNICATIONS FACILITY

PROPOSED USE

PROJECT TEAM

TRAFFIC CONTROL NOTE

36'33'0.45" N

121'55'23.23" W

APPLICANT:
VERIZON WIRELESS
2785 MITCHELL DRIVE, BLDG. 9
WALNUT CREEK, CA 94598
CONTACT: MICHELLE MARTINEA
PHONE: (925) 588-9840
EMAIL: michelle.martinea@verizonwireless.com

RF ENGINEER:
VERIZON WIRELESS
2785 MITCHELL DRIVE, BLDG. 9
WALNUT CREEK, CA 94598
CONTACT: DEWAYNE BONHAM PHONE: (510) 414-8896

ARCHITECT/ENGINEERING: CELLSITE CONCEPTS 10650 SCRIPPS RANCH BLVD., SUITE 224 SAN DIEGO, CA 92131 CONTACT: REGGIE GABRIEI PHONE: (619) 200-7190 EMAIL: reggie.gabriel@cellsite.net

<u>SITE ACQUISITION:</u> SEQUOIA DEPLOYMENT SERVICES, INC.

22471 ASPAN ST., SUITE #290 LAKE FOREST, CA 92630 CONTACT: CHELSEA MANUTO PHONE: (760) 445-1985 EMAIL: chelsea.manuto@seauoia-ds.con

CONSTRUCTION: SEQUOIA DEPLOYMENT SERVICES, INC. 22471 ASPAN ST., SUITE #290 LAKE FOREST, CA 92630 CONTACT: PETE SHUBIN PHONE: (714) 478-3197 EMAIL: pete.shubin@sequoia-ds.com

ZONING: SEQUOIA DEPLOYMENT SERVICES, INC. 22471 ASPAN ST., SUITE #290 LAKE FOREST, CA 92630 CONTACT: MICHAEL NAZAROFF PHONE: (562) 237-6380
EMAIL: michael.nazaroff@sequoia-ds.com



DRAWING INDEX				
SHEET NO: SHEET TITLE				
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LS-1	TOPOGRAPHIC SURVEY			
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PROJECT DESCRIPTION

THE PROJECT CONSISTS OF INSTALLATION OF TELECOMMUNICATIONS EQUIPMENT FOR VERIZON WIRELESS T COLLOCATE ON EXISTING PG&E POLE. THE INSTALLATION ENTAILS:

- INSTALL (1) PROPOSED VERIZON WIRELESS 4'-0" HIGH CANTENNA ON EXISTING POLE
- PROPOSED VERIZON WIRELESS 7'-0" HIGH POLE TOP EXTENSION
 PROPOSED VERIZON WIRELESS EQUIPMENT STANDOFF
- INSTALL (1) PROPOSED VERIZON WIRELESS EQUIPMENT SHROUD WITH REMOTE RADIO UNITS (RRU).
- DIPLEXER(S), PSU(S) AND FIBER DEMARC.
 INSTALL (1) PROPOSED VERIZON WIRELESS SMART POLE METER ON EXISTING POLE

-) PROPOSED VERIZON WIRELESS DISTRIBUTION PANEL AND DISCONNECT SWITCH ON T STANDOFF
- INSTALL ASSOCIATED CABLING AND GROUNDING

APPLICABLE CODES

NLL WORK AND MATERIALS SHALL BE PERFORMED AND INSTALLED IN ACCORDANCE WITH THE CURRENT EDITIONS OF THE FOLLOWING CODES AS ADOPTED BY THE LOCAL GOVERNING AUTHORITIES THE CONTRACTOR SHALL SUBMIT A TRAFFIC CONTROL PLAN (11"X17") FOR APPROVAL PRIOR TO STARTING WORK. THE PLAN SHOULD BE SUBMITTED TO THE TRAFFIC CONTROL PERMIT COUNTER. CONTRACTOR SHALL OBTAIN A TRAFFIC CONTROL PERMIT A MINIMUM OF TWO (2) WORKING DAYS CALIFORNIA ADMINISTRATIVE CODE (INCL TITLE 24 & 25)
2016 CALIFORNIA BUILDING CODE
LOCAL BUILDING CODE PRIOR TO STARTING WORK, AND A MINIMUM OF FIVE (5) DAYS IF WORK WILL AFFECT A BUS STOF OR AN EXISTING TRAFFIC SIGNAL, OR IF WORK WILL REQUIRE A ROAD OR ALLEY CLOSURE.

- CITY/COUNTY ORDINANCES
- ANSI/EIA-222-G LIFE SAFETY CODE NFPA-101 2016 CALIFORNIA ELECTRICAL CODE
- CA PUBLIC UTILITIES COMMISSION ORDER (GO 95 AND GO 128)

Verizon

PROJECT TYPE: POLYGON **SOUTH CARMEL 003**

IN FRONT OF 10TH AVE. 1 NW DOLORES ST., **CARMEL, CA 93923**

LOCATION CODE: 428218

SITE: (PG&E POLE # 110309726)

GENERAL NOTES

- LOCATIONS OF UNDERGROUND UTILITIES SHOWN ON THE DRAWINGS WERE OBTAINED BY A SEARCH OF AVAILABLE RECORDS. NEITHER THE OWNER NOR THE ENGINEER ASSUMES ANY RESPONSIBILITY FOR UTILITIES OR STRUCTURES NOT SHOWN OR NOT IN THE LOCATION SHOWN ON THE DRAWINGS.
- THE CONTRACTORS SHALL INSTALL ALL EQUIPMENT AND MATERIALS IN ACCORDANCE WITH MANUFACTURER'S RECOMMENDATIONS UNLESS SPECIFICALLY INDICATED OTHERWISE, OR WHERE LOCAL CODES OR REGULATIONS TAKE PRECEDENCE.
- APPROVAL OF THESE PLANS BY THE CITY ENGINEER DOES NOT AUTHORIZE ANY WORK TO BE PERFORMED UNTIL A PERMIT HAS BEEN ISSUED.
- UPON ISSUANCE OF A PERMIT, NO WORK WILL BE PERMITTED ON WEEKENDS OR HOLIDAYS WITHOUT PERMISSION FROM THE ENGINEERING DEPARTMENT
- THE CONTRACTOR SHALL TAKE ALL PRECAUTIONARY MEASURES NECESSARY TO PROTECT FROM DAMAGING EXISTING IMPROVEMENTS WHICH ARE TO REMAIN IN PLACE. CONTRACTOR SHALL, AT HIS OWN EXPENSE, REPAIR, REPLACE OR RECONSTRUCT ALL SUCH IMPROVEMENTS OR OTHER STRUCTURES DAMAGED BY HIS WORK, TO THE ENGINEER'S SATISFACTION.
- THE CONTRACTOR SHALL BE RESPONSIBLE FOR SURVEY MONUMENTS AND/OR VERTICAL CONTROL BENCHMARKS WHICH ARE DISTURBED OR DESTROYED BY CONSTRUCTION. A LAND SURVEYOR MUST FILED LOCATE, REFERENCE, AND/OR PRESERVE ALL HISTORICAL OR CONTROLLING MONUMENTS PRIOR TO ANY EARTHWORK, IP DESTROYED, SUCH MONUMENTS SHALL BE REPLACED WITH APPROPRIATE MONUMENTS BY A LAND SURVEYOR A CORNER RECORD OF SURVEY, AS APPROPRIATE, SHALL BE FIELD AS REQUIRED BY THE PROFESSIONAL LAND SURVEYORS ACT. IF ANY VERTICAL CONTROL IS TO BE DISTURBED OR DESTROYED, THE JURISDICTION'S FIELD SURVEY DIVISION MUST BE NOTIFIED, IN WRITING, AT LEAST 3 DAYS FROM OCCURRENCE. THE CONTRACTOR WILL BE RESPONSIBLE FOR THE COST OF REPLACING ANY VERTICAL CONTROL BENCHMARKS DESTROYED BY THE CONSTRUCTION
- CONTRACTOR SHALL BE RESPONSIBLE FOR THE POTHOLE AND LOCATING OF ALL EXISTING UTILITIES THAT CROSS THE PROPOSITENCH LINE AND MUST MAINTAIN 1 FOOT MINIMUM VERTICAL CLEARANCE.
- DO NOT EXCAVATE OR DISTURB BEYOND THE PROPERTY LINES OR LEASE LINES, UNLESS OTHERWISE NOTED.
- CONTRACTOR SHALL REPLACE OR REPAIR ALL TRAFFIC SIGNAL CONSTRUCTION.

- 10. CONTRACTOR SHALL NOTIFY THE JURISDICTION A MINIMUM OF 48 HOURS PRIOR TO COMMENCING WORK WITHIN 10 FEET OF ALL SEWER, WATER, AND STORM DRAIN MAIN
- 11 "PUBLIC IMPROVEMENT SUBJECT TO DESUETUDE OR DAMAGE." IF REPAIR OR REPLACEMENT OF SUCH PUBLIC IMPROVEMENTS IS REQUIRED, THE OWNER SHALL OBTAIN THE REQUIRED PERMITS FOR WORK IN PUBLIC RIGHT-OF-WAY, SATISFACTORY TO THE PERMIT-ISSUING AUTHORITY.
- 12. THE CONTRACTOR SHALL MAKE ARRANGEMENTS FOR A PRE-CONSTRUCTION MEETING WITH THE CITY FIELD ENGINEERING DIVISION PRIOR TO ANY DISTURBANCE TO THE SITE, EXCLUDING UTILITY MARK-OUTS AND SURVEYING.
- 13. MANHOLES OR COVERS SHALL BE LABELLED "NAME OF COMPANY"
- 14. CONTRACTOR SHALL IMPLEMENT AN EROSION AND SEDIMENT CONTROL PROGRAM DURING THE PROJECT CONSTRUCTION ACTIVITIES. THE PROGRAM SHALL MEET THE APPLICABLE REQUIREMENTS OF THE STATE WATER RESOURCE CONTROL
- 15. THE CONTRACTOR SHALL HAVE EMERGENCY MATERIALS AND EQUIPMENT ON HAND FOR UNFORESEEN STUATIONS, SUCH AS DAMAGE TO UNDERGROUND WATER, SEWER, AND STORM DRAIN FACILITIES WHEREBY FLOWS MAY GENERATE EROSION AND SEDIMENT POLLUTION.
- 16. THE CONTRACTOR SHALL VERIEY LOCATION ALL EXISTING UNDERGROUND UTILITIES INCLUDING SEWER LATERALS & WATER SERVICES TO INDIVIDUAL LOTS OF BOTH VERTICAL AND HORIZONTAL PRIOR TO COMMENCING IMPROVEMENTS OPERATIONS.
- LOCATION AND ELEVATIONS OF IMPROVEMENTS, TO BE MET BY WORK, SHALL BE CONFIRMED BY FIELD MEASUREMENTS PRIOF TO CONSTRUCTION OF NEW WORK.
- 18. GRADES SHOWN ARE FINISH GRADES, CONTRACTOR SHALL DETERMINE NECESSARY SUB GRADE ELEVATIONS AND SHALL CONSTRUCT SMOOTH TRANSITION BETWEEN FINISH GRADES
- 19. THE CONTRACTOR SHALL SUBMIT WORK PLANS FOR ALL BORE OPERATIONS TWO WEEKS PRIOR TO COMMENCING WORK
- 20. THE CONTRACTOR SHALL BE TOTALLY RESPONSIBLE FOR COMPLIANCE WITH THE PROVISIONS OF THE STATE OF

- 21. CONTRACTOR AGREES THAT HE SHALL ASSUME SOLE
 RESPONSIBILITY FOR JOB SITE CONDITION DURING THE COURSE
 OF CONSTRUCTION OF THIS PROJECT, INCLUDING SAFETY OF ALL
 PERSONS AND PROPERTY; THAT THIS EQUIPMENT SHALL APPLY PERSONS AND PROPERTY: THAT THIS EQUIPMENT SHALL APPLY CONTINUOUSLY AND NOT BE LIMITED TO NORMAL WORKING HOURS; AND THAT THE CONTRACTOR SHALL DEFEND, INDEMNIFY AND HOLD THE OWNER AND THE ENGINEER HARMLESS FROM AND AND ALL LUABILITY, REAL OR ALLEGED IN CONNECTION WITH THE PERFORMANCE OF WORK ON THIS PROJECT, EXCEPTING FOR LIABILITY ARISING FROM SOLE NEGLIGENCE OF THE OWNER OR THE PROJECT, EXCEPTING FOR THE ENGINEER.
- 22. THE LOCATIONS OF ALL EXISTING UTILITIES SHOWN ON THESE THE LOCATIONS OF ALL EXISTING UTILITIES SHOWN ON THESE PLANS ARE FROM EXISTING RECORDS AND CORROBORATED, WHERE POSSIBLE WITH FIELD TIES. THE CONTRACTOR IS RESPONSIBLE FOR CONFIRMING THE LOCATIONS SHOWN, BOTH HORIZONTALLY AND VERTICALLY PRIOR TO CONSTRUCTION. IF EXISTING LOCATIONS VARY SUBSTANTIALLY FROM THE PLANS, THE ENGINEER SHOULD BE NOTIFIED TO MAKE ANY CONSTRUCTION CHANGES REQUIRED.
- 23. AS-BUILT DRAWINGS MUST BE SUBMITTED TO THE CITY ENGINEER PRIOR TO ACCEPTANCE OF THIS PROJECT.
- 24. ALL NEW AND EXISTING UTILITY STRUCTURES ON SITE AND IN AREAS TO BE DISTURBED BY CONSTRUCTION SHALL BE ADJUSTED TO FINISH ELEVATIONS PRIOR TO FINAL INSPECTION OF WORK.
- 25. ANY DRAIN AND/OR FIELD TILE ENCOUNTERED/DISTURBED DURING CONSTRUCTION SHALL BE RETURNED TO IT'S ORIGINAL CONDITION PRIOR TO COMPLETION OF WORK, SIZE, LOCATION AND TYPE OF ANY UNDERGROUND UTILITIES OR IMPROVEMENTS SHALL BE ACCURATELY NOTED AND PLACED ON "AS-BUILT" DRAWINGS BY GENERAL CONTRACTOR, AND ISSUED TO THE ARCHITECT OR ENGINEER AT COMPLETION OF PROJECT.
- 26. ALL TEMPORARY EXCAVATIONS FOR THE INSTALLATION OF FOUNDATIONS, UTILITIES, ETC., SHALL BE PROPERLY LAID BACK OR BRACED IN ACCORDANCE WITH THE CORRECT OCCUPATIONAL SAFETY AND HEALTH ADMINISTRATION (OSHA) REQUIREMENTS.







SAN DIEGO, CA 92131 tel: (858) 433-7173 / (858) 433-7176

D	05/17/2019	SETBACK ADDED
С	03/08/2019	100% CD'S SET
В	01/29/2019	100% CD'S SET
Α	01/16/2019	DESIGN DEVELOPMENT
REV	DATE	DESCRIPTION
	C B	C 03/08/2019 B 01/29/2019 A 01/16/2019

MAY 17, 2019

100% CD SET

LICENSURE: No. C 83930 Exp. 9-30-19

SOUTH CARMEL 003 LOCATION CODE: 428218

IN FRONT OF 10TH AVE. 1 NW DOLORES ST., CARMEL, CA 93923

TITLE SHEET

T-1

ACCESSIBILITY NOTE

HE FACILITY IS UNMANNED AND NOT FOR HUMAN HABITATION. HANDICAPPED ACCESS REQUIREMENTS ARE NOT REQUIRED IN ACCORDANCE WITH THE 2016 CALIFORNIA BUILDING CODE. A TECHNICIAN WILL VISIT THE SITE AS REQUIRED FOR ROUTINE MAINTENANCE. THE PROJECT WILL NO RESULT IN ANY SIGNIFICANT DISTURBANCE OR EFFECT ON DRAINGE; NO SANITARY SEWER SERVICE. POTABLE WATER, OR TRASH DISPOSAL IS REQUIRED AND NO COMMERCIAL SIGNAGE IS NEW.

THE TELECOMMUNICATIONS EQUIPMENT SPACE SHOWN ON THESE PLANS IS NOT CUSTOMARILY OCCUPIED. WORK TO BE PERFORMED IN THIS FACILITY CANNOT REASONABLY BE PERFORMED BY PERSONS WITH A SEVERE IMPAIRMENT: MOBILITY, SIGHT, AND/OR HEARING. THEREFORE, PER 2016 CALIFORNIA BUILDING CODE SECTION 1105B.3.4, AND/OR 11B-203.5 OF 2016 CALIFORNIA BUILDING CODE, EXCEPTION 1, THIS FACILITY SHALL BE EXEMPTED FROM ALL TITLE 24 ACCESS

DO NOT SCALE **DRAWINGS** SUBCONTRACTOR SHALL VERIEY ALL PLANS

SUBSTRICT SHALL VERIFY ALL PLANS, ON HE JOB SITE & SHALL IMMEDIATELY NOTIFY HE ENGINEER IN WRITING OF ANY INSCREPANCIES BEFORE PROCEEDING WITH THE WORK ON THE DESCRIPTION OF THE PROPERTY OF THE WORK ON THE PROPERTY OF THE WORK OR BE RESPONSIBLE FOR SAME. IF USING 11"X17" PLOT, DRAWINGS WILL BE HALF



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ABBREVIATIONS

AB AC A/C ADJ A.F.F. ARCH	ANCHOR BOLT ASPHALTIC CONCRETE AIR CONDITIONING ADJUSTABLE ABOVE FINISH FLOOR ARCHITECTURAL APPROXIMATELY	JT LAM LBS LT LA LNA	JOINT LAMINATED POUNDS LIGHT LIGHTNING ARRESTOR LOW NOISE AMPLIFIER
	ABOVE GRADE LEVEL ABOVE MEAN SEA LEVEL	MFR MAT MAX	MANUFACTURER MATERIAL MAXIMUM
BD BLDG BLKG BOT BSMT BTS	BOARD BUILDING BLOCKING BOTTOM BASEMENT BASE TRANSCEIVER STATION	MECH MIN MISC ML MO MS MTD MTL	MECHANICAL MINIMUM MISCELLANEOUS METAL LATH MASONRY OPENING MACHINE SCREW MOUNTED METAL
C CEM CL CLG CLR COL	COURSE(S) CEMENT CHAIN LINK CEILING CLEAR COLUMN	(N) NIC NO NTS	NEW NOT IN CONTRACT NUMBER NOT TO SCALE
CONC CONST CONT CORR CO	COLOMN CONCRETE CONSTRUCTION CONTINUOUS CORRIDOR CONDUIT ONLY	OA O.C. OPNG OPP	OVERALL ON CENTER OPENING OPPOSITE
00	CONDON ONLY	DARTN	DARTITION

DTL DWG

GA GALV

GYP GFCI

GND

HSS

HT HV

EXISTING

EVATION OUIPMENT

FACE OF STUDS FINISH SURFACE FOOT, FEET

FINISH WALL FINISH GRADE FUTURE

HIGH VOLTAGE

INSIDE DIMENSION INSULATION INTERIOR

- NUMBER NOT TO SCALE
- PARTN PL PLAS PLYWD POC PROP PT PLYWOOD POINT OF CONNECTION PROPERTY PRESSURE TREATED R REQD RD RM RMS RO RISER REQUIRED ROOF DRAIN

PARTITION


- ROOMS ROUGH OPENING SOLID CORE SCHEDULE
- SC SCHED SECT SHT SIM SPECS SPECIFICATIONS STAINLESS STEEL
- SS STL STOR STRUCT SUSP SW SWBO TRUCTURAL SUSPENDED SWITCHBOARD
- THICK
 TENANT IMPROVEMENT
 TOWER MOUNTED AMPLIFIER
 TOP OF SURFACE
 TUBE STEEL
 TYPICAL THK TI UNO
- GAUGE GALVANIZED GLASS UNLESS NOTED OTHERWISE VCT VERT V.I.F. VG VINYL COMPOSITION TILE VERTICAL GROUND FAULT CIRCUIT
- VERIFY IN FIELD VERTICAL GRAIN GROUND
- HOLLOW CORE
 HARDWARE
 HEATER
 HOLLOW METAL
 HORIZONTAL
 HOUR
 HOLLOW STRUCTURAL
 SECTION
 HEIGHT RESISTANT XFMR TRANSFORMER @ ΑT

FIBER SERVICE

ELECTRICAL/FIBER SERVICE

CHANNEL CENTERLINE ANGLE PROPERTY LINE

SYMBOLS:

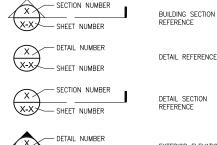

DETAIL NUMBER X-X-SHEET NUMBER	EXTERIOR ELEVATION REFERENCE
	PROPERTY LINE
xxx	FENCING
—— E—— E——	FLECTRICAL SERVICE

----E/F----E/F---

CONTRACTOR NOTES:

- . PLANS ARE INTENDED TO BE DIAGRAMMATIC OUTLINE ONLY, UNLESS NOTED OTHERWISE.
 THE WORK SHALL INCLUDE FURNISHING MATERIALS, EQUIPMENT, APPURTENANCES AND
 LABOR NECESSARY TO COMPLETE ALL INSTALLATIONS AS INDICATED ON THE DRAWINGS.
- LABOR NECESSARY TO COMPLETE ALL INSTALLATIONS AS INDICATED ON THE DRAWINGS.

 2. ALL EXISTING UTILITIES, FACILITIES, CONDITIONS, AND THEIR DIMENSIONS SHOWN ON THE PLAN HAVE BEEN PLOTTED FROM AVAILABLE RECORDS. THE ARCHITECT/ENGINEER AND THE OWNER ASSUME NO RESPONSIBILITY WHATSOEVER AS TO THE SUFFICIENCY OR THE ACCURACY OF THE INFORMATION SHOWN ON THE PLANS, OR THE MANNER OF THEIR REMOVAL, OR ADJUSTMENT. CONTRACTORS SHALL BE RESPONSIBLE FOR DETERMINING EXACT LOCATION OF ALL EXISTING UTILITIES AND FACILITIES PRIOR TO START OF CONSTRUCTION. CONTRACTORS SHALL ALSO OBTAIN FROM EACH UTILITY COMPANY DETAILED INFORMATION RELATIVE TO WORKING SCHEDULES AND METHODS OF REMOVING OR ADJUSTING EXISTING UTILITIES. ANY DISCREPANCIES OR DOUBTS AS TO THE INTERPRETATION OF PLANS SHOULD BE IMMEDIATELY REPORTED TO THE ARCHITECT/ENGINEER FOR RESOLUTION AND INSTRUCTION. AND NO FURTHER WORK ARCHITECT/ENGINEER FOR RESOLUTION AND INSTRUCTION, AND NO FURTHER WORK SHALL BE PERFORMED UNTIL THE DISCREPANCY IS CHECKED AND CORRECTED BY THE ARCHITECT/ENGINEER. FALUER TO SECURE SUCH INSTRUCTION MEANS CONTRACTOR WILL HAVE WORKED AT HIS/HER OWN RISK AND EXPENSE.
- WILL HAVE WORKED AT HIS/HER OWN HISH AND EXPENSE.

 CONTRACTOR SHALL DETERMINE ACTUAL ROUTING OF CONDUIT, POWER, T1 OR FIBER CABLES, GROUNDING CABLES AS SHOWN ON THE POWER, GROUNDING AND TELCO PLAN DRAWING. CONTRACTOR SHALL UNILIZE EXISTING TRAYS AND/OR SHALL ADD NEW TRAYS AS NECESSARY. CONTRACTOR SHALL CONTRINE THE ACTUAL ROUTING WITH THE CONTRACTOR. ROUTING OF TRENCHING SHALL BE APPROVED BY CONTRACTOR
- ALL MATERIALS AND CONSTRUCTION SHALL BE IN CONFORMANCE WITH THE BUILDING CODE AND ALL OTHER GOVERNING CODES. THESE NOTES SHALL BE CONSIDERED A PART OF THE WRITEN SPECIFICATIONS.
- THE CONTRACTOR SHALL NOTIFY ARCHITECT/ENGINEER OF ANY ERRORS, OMISSIONS, OR DISCREPANCIES AS THEY MAY BE DISCOVERED IN THE PLANS, SPECIFICATIONS, & NOTES PRIOR TO STARTING CONSTRUCTION, INCLUDING BUT NOT LIMITED BY DEMOLITION. THE CONTRACTOR SHALL BE RESPONSIBLE FOR CORRECTING ANY ERROR, OMISSION, OR INCONSISTENCY AFTER THE START OF CONSTRUCTION WHICH HAS NOT OMISSION, ON INCOMPRISED A TEATH OF CONTROLLING MINISTRUS MINISTRUS MEETING METHOD OF THE ARCHITECT/ENGINEER AND SHALL INCUR ANY EXPENSES TO RECTIFY THE SITUATION. THE METHOD OF CORRECTION SHALL BE APPROVED BY THE ARCHITECT/ENGINEER.
- APPROVED BY THE ARCHITECT/ENGINEER.
 PRIOR TO STARTING CONSTRUCTION THE CONTRACTOR HAS THE RESPONSIBILITY TO LOCATE ALL EXISTING UTILITIES, WHETHER OR NOT SHOWN ON THE PLANS, AND TO PROTECT THEM FROM DAMAGE. THE CONTRACTOR OR SUBCONTRACTOR SHALL BEAR THE EXPENSE OF REPARING OR REPLACING ANY DAMAGE TO THE UTILITIES CAUSED DURING THE EXECUTION OF THE WORK. WHERE REQUIRED FOR THE PROPER EXECUTION OF THE WORK, UTILITIES SHALL BE RELOCATED AS DIRECTED BY ENGINEERS. EXTREME CAUTION SHOULD BE USED BY THE CONTRACTOR WHEN EXCAVATING OR PIER DRILLING AROUND OR NEAR UTILITIES. CONTRACTOR SHALL PROVIDE SAFETY TRAINING FOR THE WORKING CREW.
- ALL EXISTING INACTIVE SEWER, WATER, GAS, ELECTRIC AND OTHER UTILITIES, WHICH INTERFERE WITH THE EXECUTION OF THE WORK, SHALL BE REMOVED AND SHALL BE CAPPED, PLUGGED OR OTHERWISE DISCONTINUED AT POINTS WHICH WILL NOT INTERFERE WITH THE EXECUTION OF THE WORK, SUBJECT TO THE APPROVAL OF THE
- ENGINEER.

 8. A COPY OF THE APPROVED PLANS SHALL BE KEPT IN A PLACE SPECIFIED BY THE GOVERNING AGENCY, AND BY LAW SHALL BE AVAILABLE FOR INSPECTION AT ALL TIMES. IT IS THE CONTRACTOR'S RESPONSIBILITY TO ENSURE ALL CONSTRUCTION SET REFLECT THE SAME INFORMATION AS THE APPROVED PLANS. THE CONTRACTOR SHALL ALSO MAINTAIN ONE SET OF PLANS AT THE SITE FOR THE PURPOSE OF DOCUMENTING ALL AS—BULLT (FANNES, REVISIONS, ADDEDNUMS, OR CHANGE ORDERS. THE CONTRACTOR SHALL FORWARD THE AS—BULLT/HIRED DRAWINGS TO THE ARCHITECT/ENGINEER AT THE CONCLUSION OF THE PROJECT.
- 9. THE CONTRACTOR SHALL BE RESPONSIBLE FOR THE COMPLETE SECURITY OF THE SITE WHILE THE WORK IS IN PROGRESS UNTIL THE JOB IS COMPLETE.
- THE CONTRACTOR IS RESPONSIBLE TO PROVIDE TEMPORARY POWER, WATER, AND TOILET FACILITIES AS REQUIRED BY THE PROPERTY OWNER OR GOVERNING AGENCY.

 THE CONTRACTOR SHALL BE RESPONSIBLE FOR COMPLYING WITH ALL SAFETY PRECAUTIONS AND REGULATIONS DURING THE WORK. THE ENGINEER WILL NOT ADVISE ON, NOR PROVIDE DIRECTION, AS TO SAFETY PRECAUTIONS AND PROGRAMS.
- 12. THE CONTRACTOR IS SOLELY RESPONSIBLE FOR ALL CONSTRUCTION MEANS, METHODS, TECHNIQUES, PROCEDURES, SEQUENCING, AND COORDINATING ALL PORTIONS OF THE WORK UNDER THE PROJECT. FURTHERMORE, THE STRUCTURE IS DESIGNED AS A UNIT UPON COMPLETION. THE CONTRACTOR IS RESPONSIBLE FOR FURNISHING ALL TEMPORARY BRACING AND/OR SUPPORT THAT MAY BE REQUIRED AS THE RESULT OF THE CONTRACTOR'S CONSTRUCTION METHODS. THE INVESTIGATION, DESIGN, SAFETY, ADEQUACY AND INSPECTION OF BRACING, SHORING, TEMPORARY SUPPORTS, ETC. IS THE SOLE RESPONSIBILITY OF THE CONTRACTOR.
- 13. THE CONTRACTOR SHALL BE RESPONSIBLE TO OBTAIN AND PAY FOR ALL PERMITS, LICENSES AND INSPECTIONS WITH RESPECT TO THE WORK TO COMPLETE THE PROJECT. BUILDING PERMIT APPLICATIONS SHALL BE FILED BY THE OWNER OR HIS REPRESENTATIVE. CONTRACTOR SHALL OBTAIN THE PERMIT AND MAKE FINAL PAYMENT OF SAID DOCUMENT(S).
- 14. ALL DIMENSIONS TAKE PRECEDENCE OVER SCALE UNLESS OTHERWISE NOTED.
- THE CONTRACTOR SHALL PROVIDE ALL NECESSARY FRAMING, BACKING, HANGERS, BLOCKING OR SUPPORTS FOR INSTALLATION OF ITEMS INDICATED ON THE DRAWINGS.
- NEW CONSTRUCTION ADDED TO EXISTING CONSTRUCTION SHALL BE MATCHED IN FORM, TEXTURE, MATERIAL AND PAINT COLOR EXCEPT AS NOTED IN THE PLANS.
- WHERE SPECIFIED, MATERIALS TESTING SHALL BE TO THE LATEST STANDARDS AVAILABLE AS REQUIRED BY THE LOCAL GOVERNING AGENCY RESPONSIBLE FOR RECORDING THE RESULTS.
- ALL GENERAL NOTES AND STANDARD DETAILS ARE THE MINIMUM REQUIREMENTS TO BE USED IN CONDITIONS WHICH ARE NOT SPECIFICALLY SHOWN OTHERWISE.
- 19. ALL SYMBOLS AND ABBREVIATIONS ARE CONSIDERED CONSTRUCTION INDUSTR STANDARDS. IF A CONTRACTOR HAS A QUESTION REGARDING THEIR EXACT MEANING. THE ARCHITECT/ENGINEER SHALL BE NOTIFIED FOR CLARIFICATIONS.
- CONTRACTORS SHALL VISIT THE SITE PRIOR TO BID TO ASCERTAIN CONDITIONS WHICH MAY ADVERSELY AFFECT THE WORK OR COST THEREOF.
- 21. THE CONTRACTOR SHALL FIELD VERIFY THE DIMENSIONS, ELEVATIONS, ETC. NECESSARY FOR THE PROPER CONSTRUCTION AND ALIGNMENT OF THE NEW PORTION OF THE WORK TO THE EXISTING WORK 22. REPRESENTATIONS OF TRUE NORTH, OTHER THAN THOSE FOUND ON THE PLOT OF
- SURVEY DRAWING (SHEET LS1), SHALL NOT BE USED TO IDENTIFY OR ESTABLISH THE BEARING OF TRUE NORTH AT THE SITE. THE CONTRACTOR SHALL RELY SOLELY ON THE PLOT OF SURVEY DRAWING AND ANY SURVEYOR'S MARKINGS AT THE SITE FOR THE PLOT OF SURVEY DRAWING AND ANY SURVEYOR'S MARKINGS AT THE STIE FOR THE ESTABLISHMENT OF TRUE NORTH, AND SHALL NOTIFY THE ARCHITECT/ ENGINEER PRIOR TO PROCEEDING WITH THE WORK. IF ANY DISCREPANCY IS FOUND BETWEEN THE VARIOUS ELEMENTS OF THE WORKING DRAWINGS AND THE TRUE NORTH ORIENTATION AS DEPICTED ON THE CIVIL SURVEY, THE CONTRACTOR SHALL ASSUME SOLE LIABILITY FOR ANY FAILURE TO NOTIFY THE ARCHITECT/ENGINEER. 23. NO CHANGES ARE TO BE MADE TO THESE PLANS WITHOUT THE KNOWLEDGE AND
- NO CHANGES ARE 10 BE MADE TO THESE PLANS WITHOUT THE KNOWLEDGE AND WRITTEN CONSENT OF THE ARCHITECT/ ENGINEER. UNAUTHORIZED CHANGES RENDER THESE DRAWINGS VOID. THIS INCLUDES THAT THE CONTRACTOR SHALL NOT BE RELIEVED OF ANY DEVIATION FROM THE PLANS BY THE PROFESSIONAL'S OF RECORD REVIEW OF SHOP DRAWINGS, PRODUCT DATA, ETC. UNLESS THE CONTRACTOR HAS SPECIFICALLY INFORMED THE PROFESSIONAL OF RECORD OF SUCH DEVIATION IN WRITING AT THE TIME OF SUBMISSION, AND THE PROFESSIONAL OF RECORD HAS GIVEN WRITTEN APPROVAL TO THE SPECIFIC DEVIATION.
- 24. ANY REFERENCE TO THE WORDS "APPROVED" OR "APPROVAL" IN THESE DOCUMENTS SHALL BE HERE DEFINED TO MEAN CENERAL ACCEPTANCE OR REVIEW AND SHALL NOT RELIEVE THE CONTRACTOR AND/OR HIS SUB-CONTRACTORS OF ANY LIABILITY IN FURNISHING THE REQUIRED MATERIALS OR LABOR SPECIFIED.
- 25. KEEP GENERAL AREA CLEAN, HAZARD FREE, AND DISPOSE OF ALL DIRT, DEBRIS, RUBBISH AND REMOVE EQUIPMENT NOT SPECIFIED AS REMAINING ON THE PROPERTY. LEAVE PREMISES IN CLEAN CONDITION AND FREE FROM PAINT SPOTS, DUST OR SMUDGES OF ANY NATURE

EQUIPMENT LOCATION

- THE DRAWINGS INDICATE DIAGRAMMATICALLY THE DESIRED LOCATIONS OR ARRANGEMENTS OF CONDUIT RUNS, OUTLETS, EQUIPMENT, ETC., AND ARE TO BE FOLLOWED AS CLOSELY AS POSSIBLE. PROPER DIDDEGMENT MUST BE EXERCISED IN EXECUTING THE WORK SO AS TO SECURE THE BEST POSSIBLE INSTALLATION IN THE AVAILABLE SPACE LIMITATIONS OR INTERFERENCE OF STRUCTURE CONDITIONS
- ENCOUNTERED.

 IN THE EVENT CHANGES IN THE INDICATED LOCATIONS OR ARRANGEMENTS ARE NECESSARY, DUE TO FIELD CONDITIONS IN THE BUILDING CONSTRUCTION OR REARRANGEMENT OF FURNISHINGS OR EQUIPMENT, SUCH CHANGES SHALL BE MADE WITHOUT COST, PROVIDING THE CHANGE IS ORDERED BEFORE THE CONDUIT RUNS, ETC., AND WORK DIRECTLY CONNECTED TO THE SAME IS INSTALLED AND NO EXTRA MATERIALS ARE REQUIRED.
- 3. COORDINATE THE WORK OF THIS SECTION WITH THAT OF ALL OTHER TRADES, WHERE CONFLICTS OCCUR, CONSULT WITH THE RESPECTIVE CONTRACTOR AND COME TO AGREEMENT AS TO CHANGES NECESSARY, OBTAIN WRITTEN ACCEPTANCE FROM ENGINEER FOR THE PROPOSED CHANGES BEFORE

UTILITY SERVICE

- TELEPHONE AND ELECTRICAL METERING FACILITIES SHALL CONFORM TO THE
 REQUIREMENTS OF THE SERVING UTILITY COMPANIES. CONTRACTOR SHALL VERIFY SERVICE
 LOCATIONS AND REQUIREMENTS. SERVICE INFORMATION WILL BE FURNISHED BY THE SERVING UTILITIES.
- 2. CONFORM TO ALL REQUIREMENTS OF THE SERVING UTILITY COMPANIES







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Ш	D	05/17/2019	SETBACK ADDED
Ш	С	03/08/2019	100% CD'S SET
П	В	01/29/2019	100% CD'S SET
Ш	Α	01/16/2019	DESIGN DEVELOPMENT
	REV	DATE	DESCRIPTION

ISSUED DATE:

MAY 17, 2019

ISSUED-FOR: -

100% CD SET

LICENSURE: PROFESS/ON WAREL B. 뀙 No. C 83930 (★) * Exp. 9 - 30 - 19OF CAL

PROJECT INFORMATION:

SOUTH CARMEL 003 LOCATION CODE: 428218

IN FRONT OF 10TH AVE. 1 NW DOLORES ST., CARMEL, CA 93923

DRAWN BY: MAN CHECKED BY

SHEET TITLE:

NOTES AND **SPECIFICATIONS**

SHEET-NUMBER:

T-2




NOTES:

1. THIS IS NOT A BOUNDARY SURVEY. THIS IS A SPECIALIZED TOPOGRAPHIC MAP. THE PROPERTY LINES AND EASEMENTS SHOWN HEREON ARE FROM RECORD INFORMATION AS NOTED HEREON, CELLSITE CONCEPTS TRANSLATED THE TOPOGRAPHIC SURVEY TO RECORD INFORMATION USING FOUND MONUMENTS SHOWN HEREON. THE LOCATION OF PROPERTY LINES SHOWN HEREON ARE APPROXIMATE AND FOR INFORMATIONAL PURPOSES ONLY. THEY ARE NOT TO BE RELIED UPON AS THE ACTUAL BOUNDARY LINES.

- ANY CHANGES MADE TO THE INFORMATION ON THIS PLAN, WITHOUT THE WRITTEN CONSENT OF CELLSITE CONCEPTS, RELIEVES CELLSITE CONCEPTS OF ANY AND ALL LIABILITY.
- 3. THE HEIGHTS AND ELEVATIONS FOR THE TREES, BUSHES AND OTHER LIVING PLANTS SHOWN HEREON, SHOULD BE CONSIDERED APPROXIMATE (+/-) AND ONLY FOR THE DATE OF THIS SURVEY. THEY ARE PROVIDED AS A GENERAL REFERENCE AND SHOULD NOT BE USED FOR DESIGN PURPOSES.
- 4. RIGHT-OF-WAY WAS ESTABLISHED BY LOCATING FOUND CENTERLINE CITY OR COUNTY MONUMENTS. IF CENTERLINE MONUMENTS WERE NOT LOCATABLE, THE CENTERLINE OFFSET TIES WERE USED TO ESTABLISH THE INTERSECTIONS. IF NEITHER CENTERLINE TIES OR CENTERLINE INTERSECTION MONUMENTS WERE LOCATABLE, EXISTING IMPROVEMENTS WERE USED TO ESTABLISH RIGHT-OF-WAY
- 5. ALL SHOWN RIGHT-OF-WAY WERE BASED UPON RESEARCH AT COUNTY OR CITY FILES AND REFLECT ALL SHOWN HOLDEN OF SHORE BASED OF SURVEY, PARCEL MAPS OR OTHER RECORDS.

 RIGHT-OF-WAY WILL NOT REFLECT ANY DEDICATION, TAKEN OR OFFERED AFTER THE THE RECORD

 MAP USED. ALL SURVEYS WERE COMPLETED WITHOUT THE BENEFIT OF A CURRENT TITLE REPORT AND MAY NOT SHOW ADDITIONAL DEDICATIONS NOT SHOWN ON THE RECORD MAPS USED.
- 6. WRITTEN DIMENSIONS SHALL TAKE PREFERENCE OVER SCALED & SHALL BE VERIFIED ON THE JOB SITE. ANY DISCREPANCY SHALL BE BROUGHT TO THE NOTICE OF THE SURVEYOR PRIOR TO COMMENCEMENT OF ANY WORK.
- 7. FIELD SURVEY COMPLETED ON DECEMBER 16, 2018

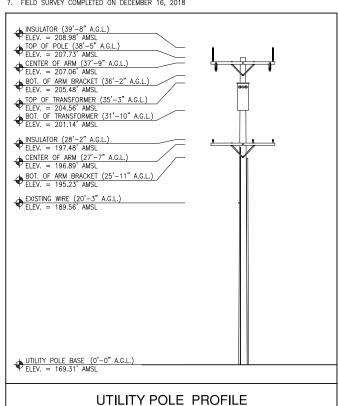


THE CENTERLINE OF $\underline{10TH}$ AVE. BEARING S90'00'00"W WAS USED AS BASIS OF BEARING FOR THIS SURVEY.

BASIS OF ELEVATIONS: (NAVD 1988)

ELEVATIONS ARE BASED ON CALVRS G.P.S. BROADCAST COORDINATE VALUES FOR 2017, NAVD $88\,$

SITE IS LOCATED IN FLOOD ZONE "X" AS PER F.I.R.M. MAP NO. 06053C0316H EFFECTIVE DATE 06/21/2017

<u>LEGEND</u>

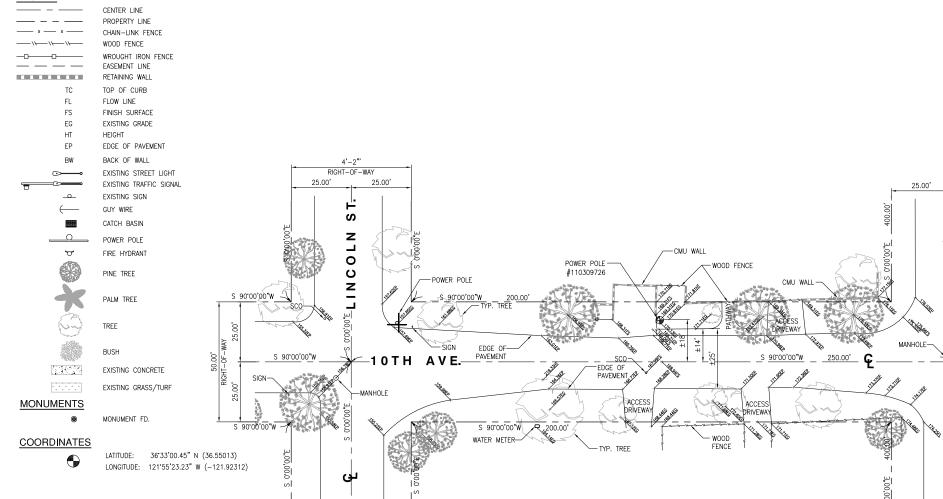



WALNUT CREEK, CA 94598





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	1	12/18/2018	FINAL SURVEY
	REV	DATE	DESCRIPTION

DECEMBER 18, 2018

ISSUED-FOR: -

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ISSUED-DATE: -

FINAL SURVEY

LICENSURE: L.S. 8780 Exp. 12/31/20

SOUTH CARMEL 003

IFO 10TH AVE., 1 NW DOLORES ST. CARMEL, CA 93923

DRAWN BY: EMS CHECKED BY:

SHEET-TITLE:

TOPOGRAPHIC SURVEY

SHEET-NUMBER:

LS-1

PROPERTY LINES ARE BASED FROM R.O.S. VOL. 28 PG 86 R.O.S. VOL. 25 PG 8

DATED FEBRUARY 07, 2006 DATED SEPTEMBER 06, 2001


SITE NOTES:

- REPRESENTATIONS OF TRUE NORTH, OTHER THAN THOSE FOUND ON THE PLOT OF SURVEY DRAWINGS SHALL NOT BE USED TO IDENTIFY OR ESTABLISH BEARING OF TRUE NORTH AT THE SITE. THE CONTRACTOR SHALL RELY SOLELY ON THE PLOT OF SURVEY DRAWING AND ANY SURVEYOR'S MARKINGS AT THE SITE FOR THE ESTABLISHMENT OF TRUE NORTH, AND SHALL NOTIFY THE ARCHITECT/ENGINEER PRIOR TO PROCEEDING WITH THE WORK IF ANY DISCREPANCY IS FOUND BETWEEN THE VARIOUS ELEMENTS OF THE WORKING DRAWINGS AND THE TRUE NORTH ORIENTATION AS DEPICTED ON THE CIVIL SURVEY. THE CONTRACTOR SHALL ASSUME SOLE LIABILITY FOR ANY FAILURE TO NOTIFY THE ARCHITECT/ ENGINEER.
- CONTRACTOR TO VERIFY LOCAL UTILITY REQUIREMENTS FOR DEPTH, SIZES, AND SEPARATION OF CONDUITS PRIOR TO INSTALLATION. NOTIFY CONSTRUCTION MANAGER IMMEDIATELY OF ANY DISCREPANCIES.
- PROPOSED UTILITY SERVICES SHOWN NEED TO BE VERIFIED AND APPROVED BY UTILITY COMPANIES BEFORE START
 OF CONSTRUCTION. CONTRACTOR TO VERIFY WITH CLIENT PROJECT MANAGER TO OBTAIN FINAL APPROVAL.
- VERIFY, LOCATE, AND PROTECT ALL EXISTING SUBSTRUCTURES AS REQUIRED. CALL DIG ALERT @ (800) 227–2600
 48 HOURS BEFORE ANY EXCAVATION. CONTRACTOR IS RESPONSIBLE TO HAVE ALL NON-PUBLIC UTILITIES LOCATED
 AT THEIR OWN EXPENSE.
- AT THEIR OWN EXPENSE.

 CONTRACTOR SHALL IMMEDIATELY INFORM CLIENT OF ANY ACCIDENTAL DAMAGE TO EXISTING UTILITIES VIA PHONE OR EMAIL REGARDLESS OF ABILITY TO REPAIR OR MITIGATE. A FOLLOW-UP EMAIL REPORT WITH DIGITAL PHOTOS WILL BE REQUIRED DAILY UNTIL RESOLUTION HAS BEEN ACCEPTED BY CLIENT, AFFECTED SERVICE PROVIDERS, AND RECIPIENTS. AT THEIR OWN EXPENSE, CONTRACTOR WILL EXERCISE ALL EFFORTS TO HAVE REPAIRS MADE BY QUALIFIED TECHNICIANS AS APPROVED BY SERVICE PROVIDER.
- 6. CONTRACTOR SHALL VERIFY ALL EXISTING UTILITIES, BOTH HORIZONTAL AND VERTICALLY, PRIOR TO THE START OF CONSTRUCTION. ANY DISCREPANCIES OR DOUBTS AS TO THE INTERPRETATION OF PLANS SHOULD BE IMMEDIATELY REPORTED TO THE ARCHITECT/ENGINEER FOR RESOLUTION AND INSTRUCTION, AND NO FURTHER WORK SHALL BE REFORMED UNTIL THE DISCREPANCY IS CHECKED AND CORRECTED BY THE ARCHITECT/ENGINEER, FAILURE TO SECURE SUCH INSTRUCTION MEANS CONTRACTOR WILL HAVE WORKED AT HIS/HER OWN RISK AND EXPENSE.
- ALL NEW AND EXISTING UTILITY STRUCTURES ON SITE AND IN AREAS TO BE DISTURBED BY CONSTRUCTION SHALL BE ADJUSTED TO FINISH ELEVATIONS PRIOR TO FINAL INSPECTION OF WORK.
- 8. ANY DRAIN AND /OR FIELD TILE ENCOUNTERED/DISTURBED DURING CONSTRUCTION SHALL BE RETURNED TO IT'S ORIGINAL CONDITION PRIOR TO COMPLETION OF WORK, SIZE, LOCATION AND TYPE OF ANY UNDERGROUND UTILITIES OR IMPROVEMENTS SHALL BE ACCURATELY NOTED AND PLACED ON "AS-BUILT" DRAWINGS BY GENERAL CONTRACTOR, AND ISSUED TO THE ARCHITECT OR ENGINEER AT COMPLETION OF PROJECT.
- ALL TEMPORARY EXCAVATIONS FOR THE INSTALLATION OF FOUNDATIONS, UTILITIES, ETC., SHALL BE PROPERLY LAID BACK OR BRACED IN ACCORDANCE WITH THE CORRECT OCCUPATIONAL SAFETY AND HEALTH ADMINISTRATION (OSHA) REQUIREMENTS.
- 10. NEW CONDUITS SHALL BE INSTALLED IN TRENCH SUCH THAT THE TOP OF CONDUIT SHALL HAVE A MINIMUM COVER OF 30-INCHES BELOW ADJACENT EDGE OF PAVEMENT OR ORIGINAL GROUND, WHICHEVER IS LOWER IN ELEVATION.
- 11. ALL PULL BOXES SHALL BE PRECAST REINFORCED CONCRETE AND HAVE NON CONDUCTIVE LIDS. EXISTING PULL BOX COVERS THAT ARE MARKED INCORRECTLY SHALL BE REPLACED.
- 12. REGRADE LANDSCAPING AS NEEDED AND REPLACE DAMAGED IRRIGATION LINES WITHIN 24 HOURS.

UNDERGROUND UTILITIES NOTE:

ALL EXISTING SUB-SURFACE UTILITIES, FACILITIES, CONDITIONS, AND THEIR DIMENSIONS SHOWN ON THE PLAN HAVE ALL EXISING SUB-SURFACE UTILITIES, FACILITIES, CONDITIONS, AND INLER DIMENSIONS SHOWN ON THE PLAN HAVE BEEN PLOTTED FROM FILED SURVEY MAD/OR AVAILABLE RECORDS, THE ARCHITECT/ ENGINEER AND THE OWNER ASSUME NO RESPONSIBILITY WHATSOEVER AS TO THE SUFFICIENCY OR THE ACCURACY OF THE INFORMATION SHOWN ON THE PLANS, OR THE MANNER OF THEIR REMOVAL OR ADJUSTMENT. CONTRACTORS SHALL BE RESPONSIBLE FOR THE DETERMINING EXACT LOCATION OF ALL EXISTING UTILITIES AND FACILITIES PIGNET OF STATT OF CONSTRUCTION. CONTRACTORS SHALL ALSO OBTAIN FROM EACH UTILITY COMPANY DETAILED INFORMATION RELATIVE TO WORKING SCHEDULES AND METHODS OF REMOVING OR ADJUSTING EXISTING UTILITIES. THERE MAY BE EXISTING UTILITIES OTHER THAN THOSE SHOWN ON THIS PLAN. THE CONTRACTOR IS REQUIRED TO TAKE PRECAUTIONARY MEASURES TO PROTECT THE UTILITY LINE SHOWN AND ANY OTHER LINES NOT SHOWN ON THIS PLAN.

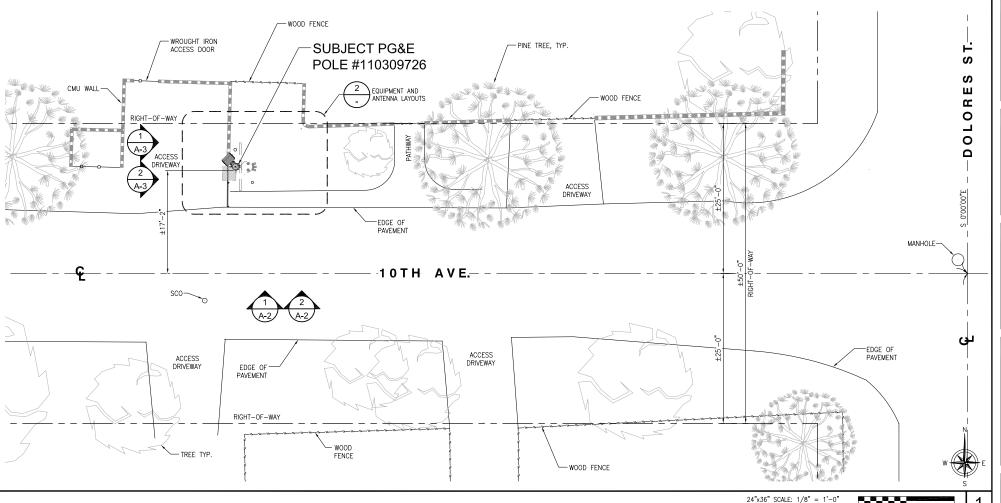




2

NOTES:

1. THE NEW LAYOUT IS PRELIMINARY AND SUBJECT TO CHANGE PENDING AND STRUCTURAL ANALYSIS.

EQUIPMENT AND ANTENNA LAYOUTS

3. RF SIGNAGE TO BE PLACED IN CLIMBING AREA AND STREET SIDE PER VZW/FCC STANDARDS.

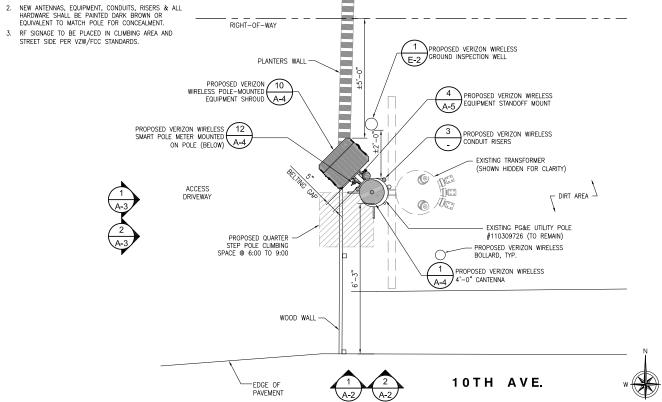

24"x36" SCALE: 1/2" = 1'-0"

11"x17" SCALE: 1/4" = 1'-0"

POLE HEIGHT:

MATERIAL: DF POLE CLASS: YEAR SET: 2012


MAKE-READY SCOPE:

- VERIZON TO INSTALL (1) SMART POLE METER ON
- 2. VERIZON TO INSTALL (1) DISTRIBUTION PANEL AND DISCONNECT SWITCH ON STANDOFF MOUNT AT 10:30 POSITION.
- VERIZON TO INSTALL (1) EQUIPMENT SHROUD ON STANDOFF MOUNT AT 10:30 POSITION.
- 4. VERIZON TO INSTALL (1) 4FT ANTENNA ON TOP OF PROPOSED 7'-0" HIGH POLE EXTENSION.
- VERIZON TO INSTALL 2" SCHEDULE 80 PVC POWER RISER MOUNTED ON CONDUIT STANDOFF AT 12:30 POSITION FROM SERVICE DROP TO METER. VERIZON TO INSTALL 4" SCHEDULE 80 PVC HYBRID
- RISER MOUNTED ON CONDUIT STANDOFF AT 11:30 POSITION FROM RRUS TO ANTENNA. INSTALL 2" SCHEDULE 80 PVC FIBER RISER MOUNTED ON CONDUIT STANDOFF AT 9:30 POSITION FROM SERVICE DROP TO EQUIPMENT CABINET.
- 8. VERIZON TO STEP POLE @ 6:00 TO 9:00

(E) CONDUIT RISER EXISTING PG&E UTILITY POLE E) TRANSFORMER GROUND #110309726 (TO REMAIN) CÓNDUIT RISER ALONG


10TH AVE.

FOC/EP

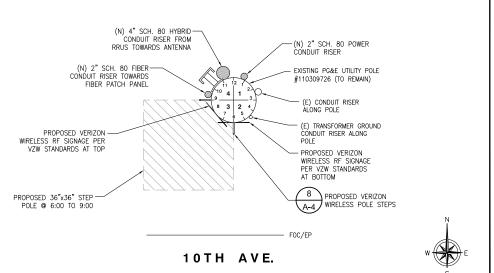





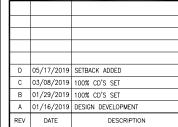

ISSUED DATE: MAY 17, 2019

ISSUED FOR: -

100% CD SET

LICENSURE: 뮏 No. C 83930 (★) Exp. 9-30-19

PROJECT INFORMATION:

SOUTH CARMEL 003 LOCATION CODE: 428218

IN FRONT OF 10TH AVE. 1 NW DOLORES ST., CARMEL, CA 93923


DRAWN BY: MAM CHECKED BY

SHEET-TITLE: SITE PLAN AND EQUIPMENT AND ANTENNA LAYOUTS

3

A-1

24"x36" SCALE: NTS MAKE READY 11"x17" SCALE: NTS

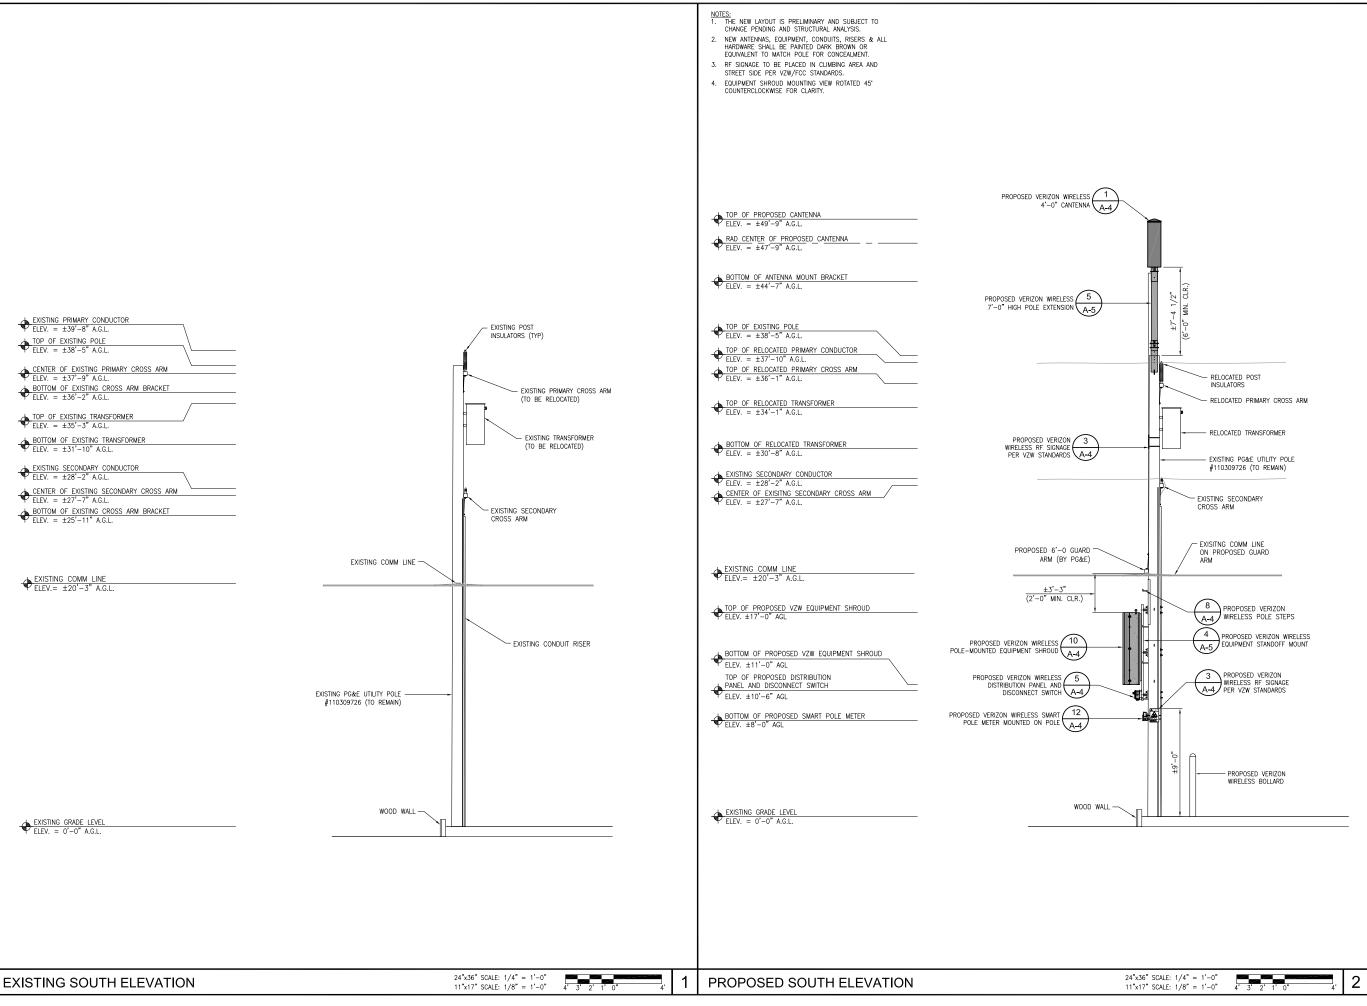







D 05/17/2019 SETBACK ADDED
C 03/08/2019 100% CD'S SET
B 01/29/2019 100% CD'S SET
A 01/16/2019 DESIGN DEVELOPMENT
REV DATE DESCRIPTION

MAY 17, 2019

ISSUED-FOR: -

100% CD SET

No. C 83930 Exp. 9-30-19

PROJECT INFORMATION:

SOUTH CARMEL 003 LOCATION CODE: 428218


IN FRONT OF 10TH AVE. 1 NW DOLORES ST., CARMEL, CA 93923

DRAWN BY: MAM
CHECKED BY: RGG

SHEET-TITLE:

ARCHITECTURAL ELEVATIONS

SHEET NUMBER:

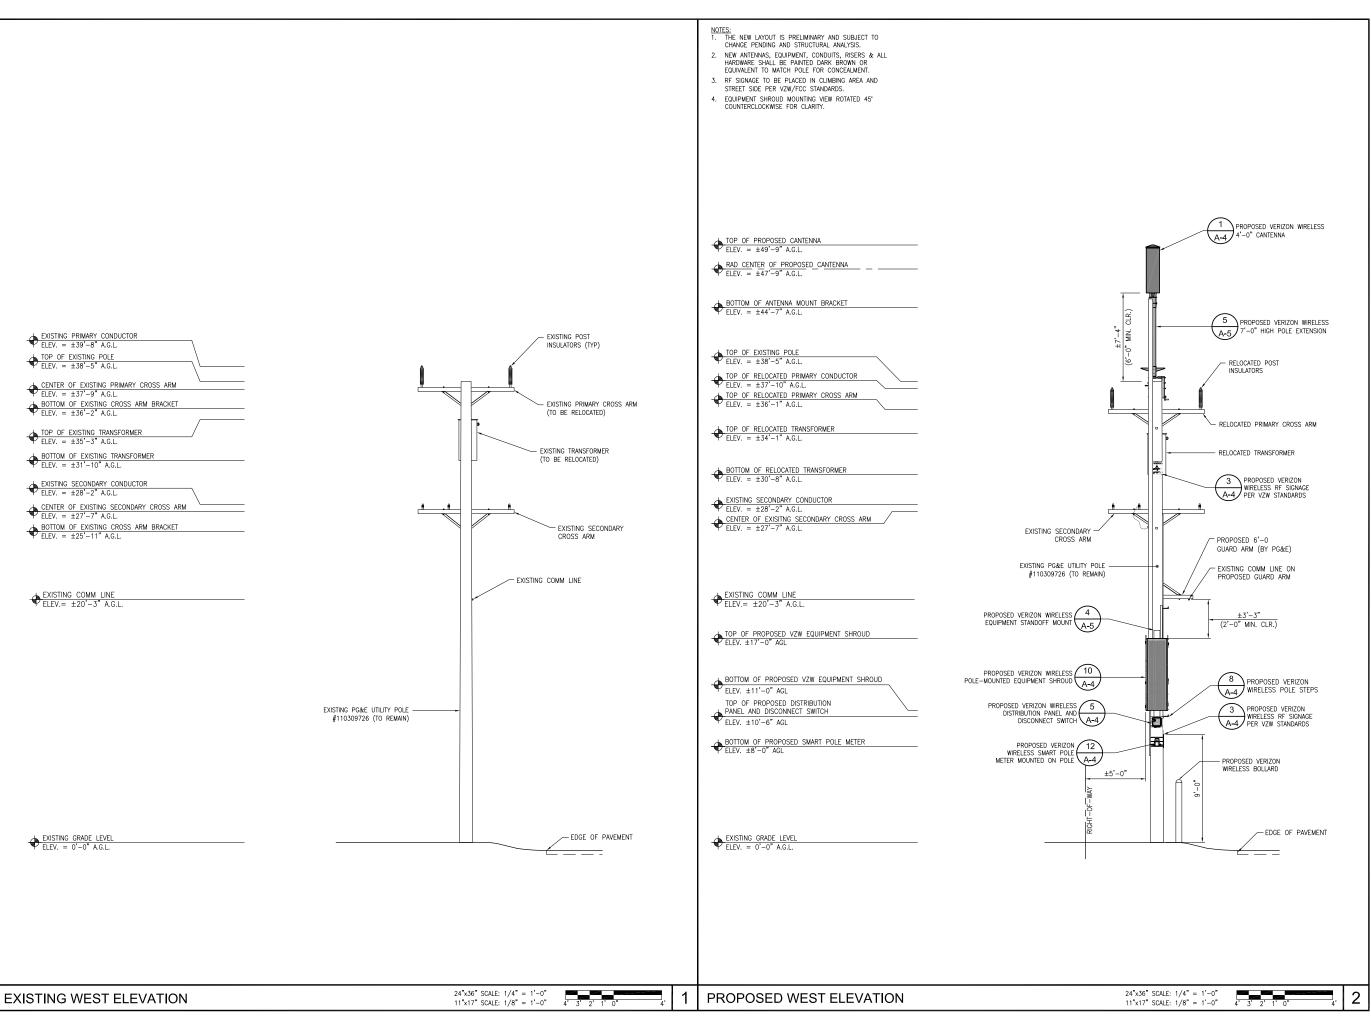







D 05/17/2019 SETBACK ADDED
C 03/08/2019 100% CD'S SET
B 01/29/2019 100% CD'S SET
A 01/16/2019 DESIGN DEVELOPMENT
REV DATE DESCRIPTION

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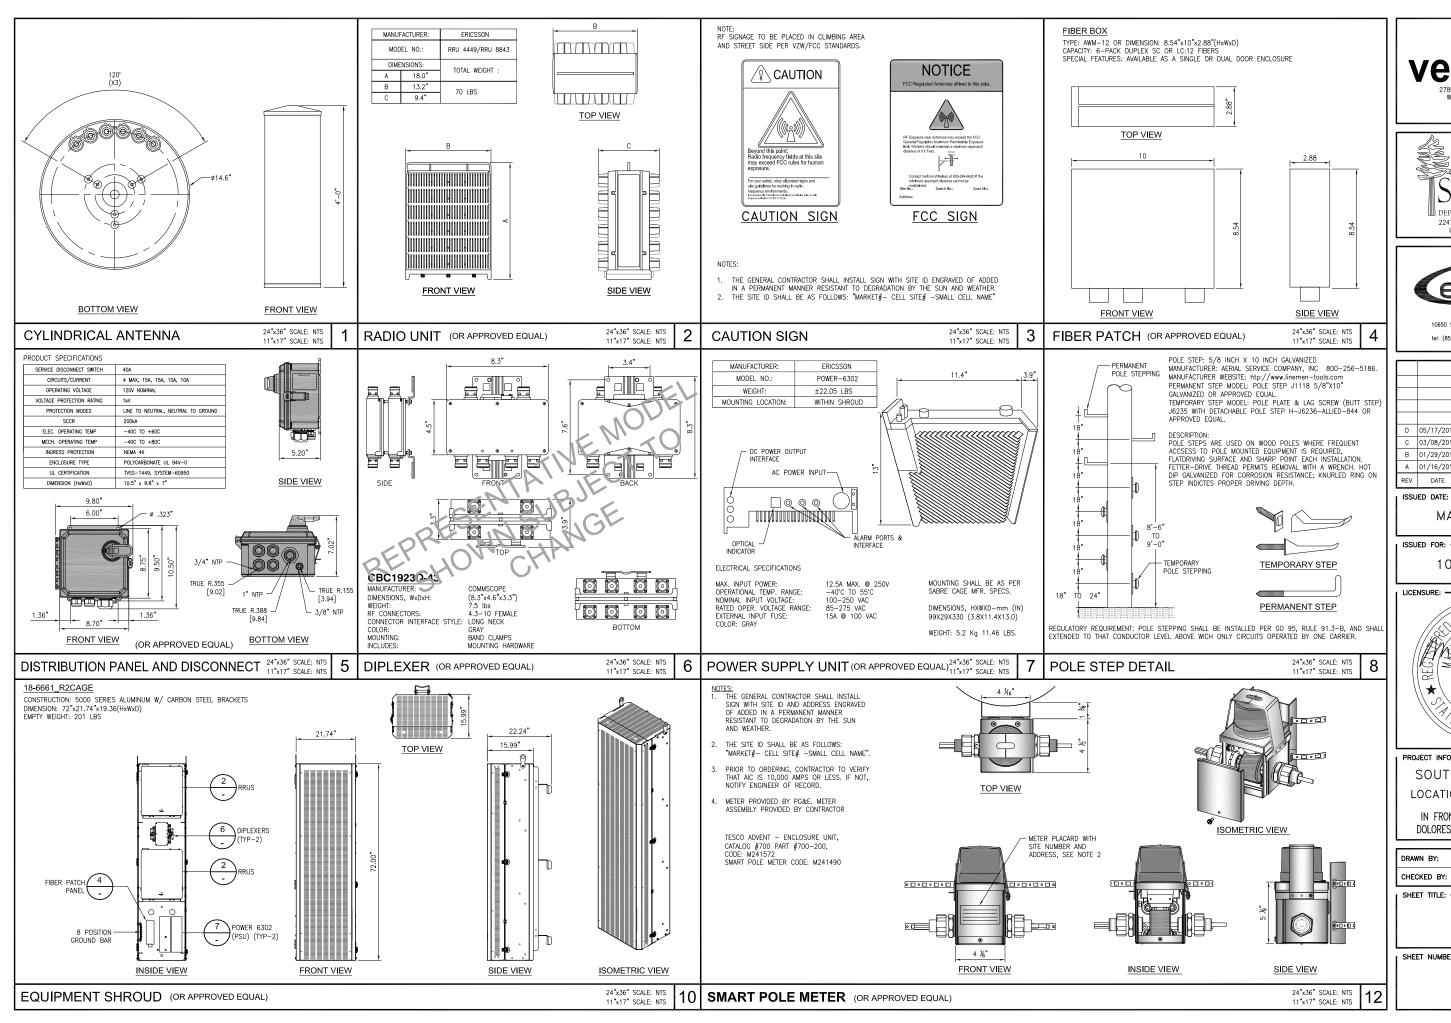
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D 05/17/2019 SETBACK ADDED C 03/08/2019 100% CD'S SET B 01/29/2019 100% CD'S SET A 01/16/2019 DESIGN DEVELOPMENT DESCRIPTION

ISSUED DATE:

MAY 17, 2019

100% CD SET

No. C 83930 Exp. 9 - 30 - 19


SOUTH CARMEL 003 LOCATION CODE: 428218

IN FRONT OF 10TH AVE. 1 NW DOLORES ST., CARMEL, CA 93923

١	DRAWN BY:		
١	CHECKED BY:	RGG	
١	SHEET-TITLE:		

DETAILS


SHEET NUMBER:

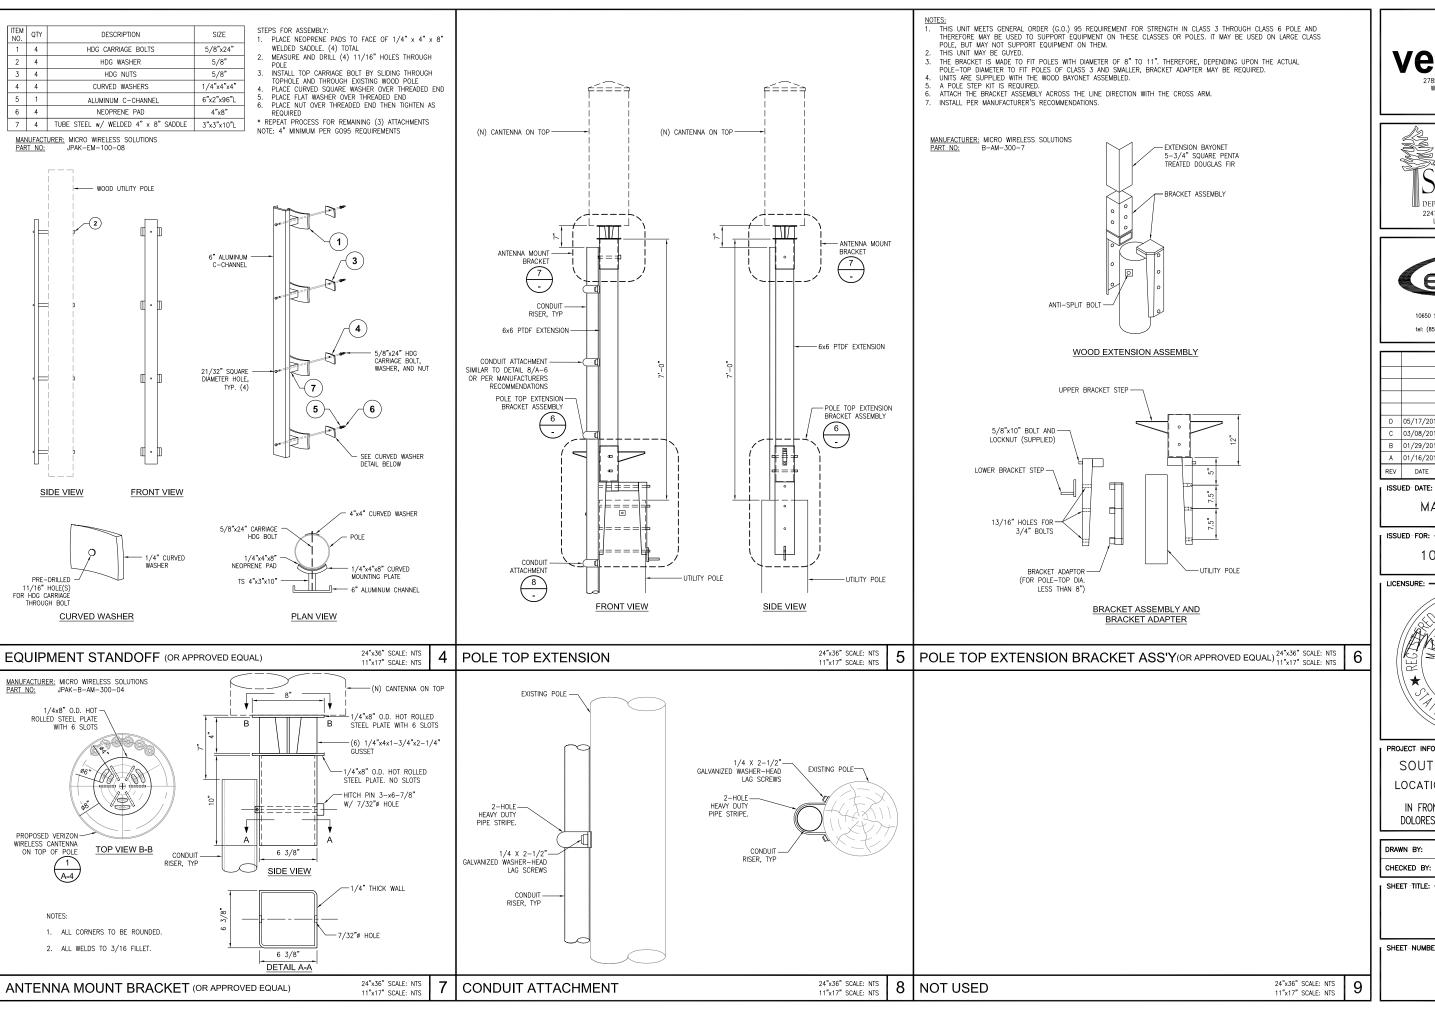







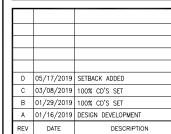

MAY 17, 2019

ISSUED FOR:

100% CD SET

LICENSURE: 뮏 No. C 83930 (★) Exp. 9-30-19

SOUTH CARMEL 003 LOCATION CODE: 428218

IN FRONT OF 10TH AVE. 1 NW DOLORES ST., CARMEL, CA 93923

	DRAWN BY:	MAM
	CHECKED BY:	RGG
١.		

SHEET TITLE:

DETAILS

SHEET-NUMBER:

ELECTRICAL NOTES

- THIS INSTALLATION SHALL COMPLY WITH THE CURRENTLY ADOPTED EDITION OF THE CALIFORNIA ELECTRICAL CODE (CEC), WITH THE UTILITY COMPANY AND LOCAL CODE RECHIREMENTS
- POWER, CONTROL AND FOUIPMENT GROUND WIRING IN CONDUIT SHALL BE SINGLE CONDUCTOR (#12 AWG AND LARGER), 600V, OIL RESISTANT THHN OR THWN-2, CLASS B STRANDED COPPER CABLE RATED FOR 90°C (WET AND DRY) OPERATION; LISTED OR LABELED FOR THE LOCATION AND RACEWAY SYSTEM USED.
- CUT, COIL AND TAPE A 3 FOOT PIGTAIL FROM END OF LFMC FOR TERMINATING AT EQUIPMENT, IF REQUIRED.
- SUPPLEMENTAL EQUIPMENT GROUND WIRING LOCATED OUTDOORS OR BELOW GRADE SHALL BE SINGLE CONDUCTOR #2 AWG SOLID, TINNED, COPPER WIRE
- ALL POWER AND GROUNDING CONNECTIONS SHALL BE CRIMP STYLE, COMPRESSION, WIRE LUGS AND WIRENUTS BY THOMAS AND BETTS (OR EQUAL). LUGS AND WIRENUTS SHALL BE RATED FOR OPERATION AT NO LESS THAN 75°C.
- ALL ELECTRICAL COMPONENTS SHALL BE CLEARLY LABELED WITH ENGRAVED LAMINATED PLASTIC LABELS. ALL EQUIPMENT SHALL BE LABELED WITH THEIR VOLTAGE RATING, PHASE CONFIGURATION, WIRE CONFIGURATION, POWER OR AMPACITY RATING AND BRANCH CIRCUIT ID NUMBERS (PANELBOARD AND CIRCUIT IDENTIFICATION).
- 7. ALL CONDUIT RUN ABOVE GROUND OR EXPOSED SHALL BE RIGID STEEL.
- CABINETS, BOXES AND WIREWAYS SHALL BE LISTED OR LABELED FOR ELECTRICAL USE IN ACCORDANCE WITH NEMA, UL, ANSI/IEEE AND CEC.
- PROVIDE NECESSARY TAGGING ON THE BREAKERS CARLES AND DISTRIBUTION PANELS N ACCORDANCE WITH APPLICABLE CODES AND STANDARDS TO SAFEGUARD LIFE AND
- ALL ELECTRODE SYSTEMS (INCLUDING TELECOMMUNICATION, RADIO, LIGHTNING PROTECTION AND AC POWER) SHALL BE BONDED TOGETHER AT OR BELOW GRADE BY TWO OR MORE COPPER BONDING CONDUCTORS IN ACCORDANCE WITH THE CEC.
- PERFORM IFFE FALL-OF-POTENTIAL RESISTANCE TO FARTH TESTING (PER IFFE 1100 PERFORM IEEE FALL—OF—POTAINER RESISTANCE TO EARTH TESTING FER IEEE THOU AND 81) FOR NEW GROUND ELECTRODE SYSTEMS. THE CONTRACTOR SHALL FURNISH AND INSTALL SUPPLEMENTAL GROUND ELECTRODES AS NEEDED TO ACHIEVE A TEST RESULT OF 5 OHMS OR LESS.
- METAL RACEWAY SHALL NOT BE USED AS THE CEC REQUIRED EQUIPMENT GROUND CONDUCTOR. STRANDED COPPER CONDUCTORS WITH GREEN INSULATION SIZED IN ACCORDANCE WITH THE CEC SHALL BE FURNISHED AND INSTALLED WITH THE POWER CIRCUITS TO FQUIPMENT.
- 13. EXPOSED GROUND CONNECTIONS SHALL BE MADE WITH COMPRESSION CONNECTORS WHICH ARE THEN BOLTED TO EQUIPMENT USING STAINLESS STEEL HARDWARE. INSTALLATION TORQUE SHALL BE PER MANUFACTURER'S REQUIREMENTS.
- PROVIDE SUPPORTING DEVICES FOR ALL ELECTRICAL EQUIPMENT, FIXTURES, BOXES, PANEL, FIC., SUPPORT LUMINARIES FROM UNDERSIDE OF STRUCTURAL CELIAGO, EQUIPMENT SHALL BE BRACED TO WITHSTAND HORIZONTAL FORCES IN ACCORDANCE WITH STATE AND LOCAL CODE REQUIREMENTS. PROVIDE PRIOR ALIGNMENT AND LEVELING OF ALL DEVICES AND FIXTURES.

POLE CONSTRUCTION NOTES:

- METER SHALL NOT FACE THE STREET, ALLEY, OR PROPERTY SIDE OF THE POLE.
- METER BASE AND DISCONNECT SHALL BE BONDED TO A SEPARATE GROUND FROM THE POLE GROUND WITH CONDUCTOR HAVING A CURRENT CAPACITY THAN NO LESS THAN #6 SOLID COPPER CONDUCTOR.
- 3. EQUIPMENT CANNOT OVERHANG THE ROADWAY
- 4. VERIFY AND RECORD ALL CHANGES AND FOOTAGES IN FIELD ON THE FINAL AS-BUILT DRAWINGS.
- 5. GROUNDS ARE TO BE TESTED: REQUIRES 5 OHMS OR LESS RESISTANCE.
- 6. ALL LANDSCAPING TO BE RESTORED TO ORIGINAL CONDITION. 7. NOTIFY PROPERTY OWNER BEFORE WORKING ON OR AROUND PRIVATE PROPERTY.
- 8. OBTAIN SPECIAL PERMITS AND PAY FEES AS REQUIRED WHEN WORKING ON CITY AND COUNTY HIGHWAY SITES.
- 9. MAINTAIN 36" MINIMUM COVER IN PARKWAY.
- 10. MAINTAIN 30" MINIMUM COVER BELOW GUTTER GRADE ON SURFACE STREETS.
- 11. CONDUITS MAY BE MOUNTED DIRECTLY TO THE POLE OR U-GUARD MAY BE USED IF THE POLE IS WITHIN 15" OF A BUCKET TRUCK ACCESSIBLE PAVED ROAD. IF NOT ACCESSIBLE AND THE CONDUIT IS GREATER THAN 1-1/2", THE CONDUIT IS OF BE MOUNTED WITH A STANDOFF BRACKET THAT PROVIDES 7" CLEARANCE FROM THE POLE TO THE CONDUIT.
- 12. CONTRACTOR TO PROVIDE MOUNTS OR ADDITIONAL HARDWARE IF REQUIRED FOR INSTALLATION OF PROPOSED ANTENNAS.

13. <u>CONDUIT REQUIREMENTS:</u>
UNDERGROUND — SCHEDULE 40 PVC OR BETTER
RISERS — SCHEDULE 80 PVC WITH FIRST 10' ABOVE GROUND LEVEL TO BE RGS FOR PROTECTION PURPOSES. ALL CONDUITS WILL BE MANDRELED AND EQUIPPED WITH 3/8" PULL ROPE AND MEASURE TAPE IF REQUIRED.

GROUNDING NOTES

- ALL DETAILS ARE SHOWN IN GENERAL TERMS. ACTUAL GROUNDING INSTALLATION REQUIREMENTS AND CONSTRUCTION SHALL BE ACCORDING TO SITE CONDITIONS.
- ALL GROUNDING CONDUCTORS: #2 AWG SOLID BARE TINNED COPPER WIRE UNLESS OTHERWISE NOTED.
- GROUND BAR LOCATED IN BASE OF FOUIPMENT WILL BE PROVIDED. FURNISHED AND INSTALLED BY THE VENDOR
- ALL BELOW GRADE CONNECTIONS: EXOTHERMIC WELD TYPE, ABOVE GRADE CONNECTIONS: MECHANICAL/ CONNECTIONS U.N.O.
- INSTALL GROUND CONDUCTORS AND GROUND ROD MINIMUM OF 1'-0" FROM EQUIPMENT CONCRETE SLAB, SPREAD FOOTING, OR FENCE.
- ALL GROUNDING INSTALLATIONS AND CONNECTIONS SHALL BE MADE BY ELECTRICAL
- ALL GROUNDING FOR ANTENNAS SHALL BE CONNECTED SO THAT IT WILL BY-PASS MAIN BUSS BAR.
- USE SEPARATE HOLES FOR GROUNDING AT BUSS BAR. NO "DOUBLE-UP" OR
- NO LB'S ALLOWED ON GROUNDING.
- PROVIDE STAINLESS STEEL CLAMP AND BRASS TAGS ON ANY COAX AT ANTENNAS AND RADIOS.
- ALL ELECTRICAL AND GROUNDING AT THE CELL SITE SHALL COMPLY WITH THE CALIFORNIA ELECTRICAL CODE (CEC).
- EXOTHERMIC WELDING IS REQUIRED FOR GROUNDING BELOW GRADE CONNECTIONS
- MECHANICAL, ABOVE GRADE CONNECTIONS MAY BE MADE USING COMPRESSION TYPE-2 HOLES. LONG BARREL LUGS OR DOUBLE CRIMP CLAMP "C" CLAMP. THE COPPER CABLES SHALL BE COATED WITH ANTIOXIDANT (COPPER SHIELD) BEFORE MAKING THE CONNECTIONS. THE MANUFACTURER'S TORQUE RECOMMENDATIONS ON THE BOLT ASSEMBLY TO SECURE CONNECTIONS SHALL BE FOLLOWED. ALL TWO HOLE LONG BARREL LUGS SHALL HAVE VIEW PORTS TO ENSURE PROPER
- PROVIDE PVC SLEEVES FOR GROUNDING CONDUCTORS AS NEEDED.
- 15. GROUND ANTENNA BASES, FRAMES, CABLE RACKS AND OTHER METALLIC COMPONENTS WITH #2 GROUNDING CONDUCTORS AND CONNECT TO INSULATED SURFACE MOUNTED GROUND BARS. CONNECTION DETAILS SHALL FOLLOW
- 16. PERFORM IEEE FALL-OF-POTENTIAL RESISTANCE TO EARTH TESTING (PER IEEE 1100 AND 81) FOR NEW GROUND ELECTRODE SYSTEMS. THE SUBCONTRACTOR SHALL FURNISH AND INSTALL SUPPLEMENTAL GROUND ELECTRODES AS NEEDED TO ACHIEVE A TEST RESULT OF 5 OHMS OR LESS.
- 17. SURFACES TO BE CONNECTED TO GROUND CONDUCTORS SHALL BE CLEANED TO A BRIGHT SURFACE AT ALL CONNECTIONS.

18 GROUND REQUIREMENTS:

GROUND REQUIREMENTS:
5/8" SS, COPPER CLAD GROUNDING ROD—10' LENGTH
GROUND TESTED AT 5 OHMS OR LESS
#2 GROUND WIRE, SOLID, TINNED

HARDWOOD MOLDING, STAPLED TO POLE EVERY 2'-0" AND AT EACH END GROUND RODS MUST BE 24" FROM POLE AND THE TOP OF ROD MUST BE BELOW GRADE LEVEL PER PLAN DETAILS.

M UTILITY METER

FUSE

CIRCUIT BREAKER

DISCONNECT SWITCH

■ DUPLEX RECEPTACLE WITH GFCI

IN WEATHERPROOF ENCLOSURE

CLAMP OR DOUBLE HOLE LUG

TYPE GROUND CONNECTION

EXOTHERMIC CONNECTION TO

LEGEND SYMBOLS:

GROUNDING WIRE, DASHED LINE

AC POWER LINE, DASHED INDICATES UNDERGROUND

DC POWER LINE, DASHED INDICATES UNDERGROUND TELEPHONE LINE, DASHED LINE

INDICATES UNDERGROUND COAXIAL CABLE, DASHED LINE

NDICATES UNDERGROUND FIBER CABLE, DASHED LINE INDICATES UNDERGROUND

DETAIL REFERENCE DETAIL NO. 2 ON SHEET E3

 \otimes GROUND ROD

 $\frac{2}{E3}$


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GROUND ROD WITH ACCESS

- . ALL CONDUIT ROUTING IS SCHEMATIC. CONTRACTOR SHALL INSTALL CONDUITS SO THAT ACCESS TO EQUIPMENT IS NOT IMPEDED.
- 2 CONDUIT SIZES INDICATED ON THE DRAWINGS ARE NOT NECESSARILY BASED ON THE MINIMUM CONDUIT SIZES INDICATED ON THE DRAWINGS ARE NOT NECESSARILE BASED ON THE MINIMUM SIZE ALLOWED BY THE CEC AND MAY BE PURPOSELY OVERSIZED FOR FUTURE CONDUCTORS OR TO AVOID CONDUCTOR HEATING. CONDUIT SIZES NOT CALLED OUT ON THE DRAWINGS SHALL BE SIZED BY THE CONTRACTOR, BASED ON THE ACTUAL NUMBER OF CONDUCTORS TO BE INSTALLED, USING THE CEC AS A GUIDE. IN NO CASE SHALL CONDUIT SIZES BE SMALLER THAN 1/2'
- 3. THE CONTRACTOR SHALL PROVIDE AND INSTALL ALL JUNCTION AND PULLBOXES REQUIRED FOR THE INSTALLATION OF ELECTRICAL DEVICES AND EQUIPMENT, WHETHER OR NOT SPECIFICALLY INDICATED ON THE PLANS. SIZING OF THESE BOXES SHALL BE PER THE CEC.
- ALL ELECTRICAL WORK SHALL BE CONSTRUCTED IN ACCORDANCE WITH PROJECT SPECIFICATIONS AND ALL APPLICABLE LOCAL CODES AND REGULATIONS.
- UTILITY ELECTRICAL SERVICE WILL BE 120/240 VOLTS OR 120/208 VOLTS, SINGLE PHASE, MIN. 30 AMPS CAPACITY. SEE PLANS FOR DETAILS.
- 6 PROJECT CONDITIONS MAY REQUIRE REARRANGEMENT OF ELECTRICAL WORK. THE SUBCONTRACTOR SHALL INDICATE SUCH CHANGES ON THE AS-BUILT DRAWINGS. WHERE CHANGES REQUIRE ALTERNATE METHODS TO THOSE SPECIFIED IN THE PLANS, THE SUBCONTRACTOR SHALL REQUEST APPROVAL. AND SHALL NOT PROCEED UNTIL APPROVAL IS OBTAINED.
- CONTRACTOR SHALL PAINT ALL EXPOSED EXTERIOR CONDUITS AND JUNCTION BOXES TO MATCH EXISTING FINISH ON WHICH THEY ARE ATTACHED.
- 8 FIRER TRUNKS AND/OR BACKHAUL LENGTHS AND ROLLTES ARE NOT VERIFIED DURING THE SITE WALK CONTRACTOR TO VERIFY ACTUAL ROUTE AND TRUNK LENGTH DURING PRE-CONSTRUCTION WALK
- O. CONTRACTOR SHALL COORDINATE WITH UTILITY COMPANY FOR FINAL AND EXACT WORK/MATERIALS REQUIREMENTS AND CONSTRUCT TO UTILITY ENGINEERING PLANS AND SPECIFICATIONS ONLY WHERE APPLICABLE PER PROJECT SCOPE OF WORK
- 10. CONTRACTOR SHALL FURNISH AND INSTALL CONDUIT, PULL WIRES, CABLE PULL BOXES, CONCRETE ENCASEMENT OF CONDUIT, TRANSFORMER PAD, BARRIERS, POLE RISER TRENCHING, BACK FILL, AND UTILITY FEES, AND INCLUDE REQUIREMENTS IN SCOPE.
- 11. TEST ALL ELECTRICAL & GROUNDING SYSTEMS (CONTINUITY, MEGGER, ETC.) UPON COMPLETION OF INSTALLATION PRIOR TO FINALIZING WORK.
- CONTRACTOR TO VERIFY ALL CONDUIT ROUTING FOR, (N) VZW METER AND (N) GROUND ROD LOCATION WITH LANDLORD AND UTILITY COORDINATOR IN FIELD.
- 13. CONDUIT REQUIREMENTS (TYP., U.N.O.): UNDERGROUND: PVC (SCHED. 40 OR 80). INDOOR: EMT (RGS IN TRAFFIC AREAS). OUTDOOR: (ABOVE GRADE) RGS.
- 14. PROVIDE A MIN. 36" WORK CLEARANCE IN FRONT OF PANELS/ ELECTRICAL EQUIPMENT.

BREAKER LEGEND				
CIRCUIT # DESCRIPTION		ACB /	#POLES	
1	PSU #1	15A 1P	10A 2P	
2	PSU #2	15A 1P	10A 2P	
3	SPARE	10A 1P	-	
,	SPAIL	TUA IF	-	
4	4 SPARE		-	
	31 ARE	10A 1P		

SINGLE LINE DIAGRAM

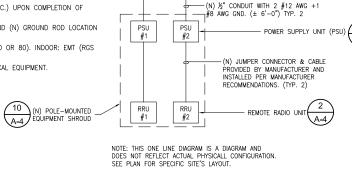

PG&E POWER SOURCE 120 VAC,

1PHASE 40 AMPS MIN.

(FROM PG&E TRANSFORMER ON POLE)

DISCONNECT

) 10A 1P

SPARE

SPARE

PG&E REQUIREMENTS FOR


60 AMP CT METER WITH POLE MOUNT

MANUFACTURER RECOMMENDATIONS ON

(N) DISTRIBUTION PANEL WITH, TVSS, DISCONNECT, NEMA 4X, 40 AMPS MAX.

ASSEMBLY GROUND METER PER

(N) OVER HEAD SERVICE

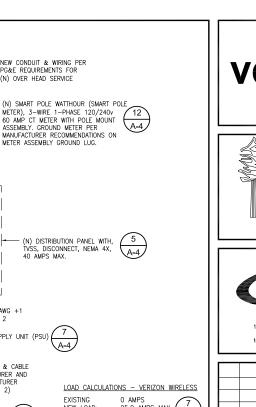

LOAD CALCULATIONS - VERIZON WIRELESS 0 AMPS 25.0 AMPS MAX. NEW LOAD: (A-4) NET TOTAL 25.0 AMPS MAX.

LOAD: POWER AND TELCO DESIGN IS BASED ON INITIAL SITE VISIT.

CONTRACTOR SHALL OBTAIN CURRENT UTILITY COORDINATOR PLANS PRIOR TO START OF CONSTRUCTION AND CONFORM THE CURRENT VERSION OF PG&E BULLETIN TD-027911B-002

AVAILABLE FAULT CURRENT PER LITHLITY

24"x36" SCALE: NTS 11"x17" SCALE: NTS







D	05/17/2019	SETBACK ADDED		
С	03/08/2019	100% CD'S SET		
В	01/29/2019	100% CD'S SET		
Α	01/16/2019	DESIGN DEVELOPMENT		
REV	DATE	DESCRIPTION		

ISSUED DATE:

MAY 17, 2019

ISSUED-FOR: -

100% CD SET

LICENSURE:



SOUTH CARMEL 003 LOCATION CODE: 428218

IN FRONT OF 10TH AVE. 1 NW DOLORES ST., CARMEL, CA 93923

DRAWN RY MAN CHECKED BY

SHEET-TITLE:

ELECTRICAL NOTES AND SINGLE LINE DIAGRAM


SHEET NUMBER:

E-1

NOT USED

24"x36" SCALE: NTS 11"x17" SCALE: NTS

2

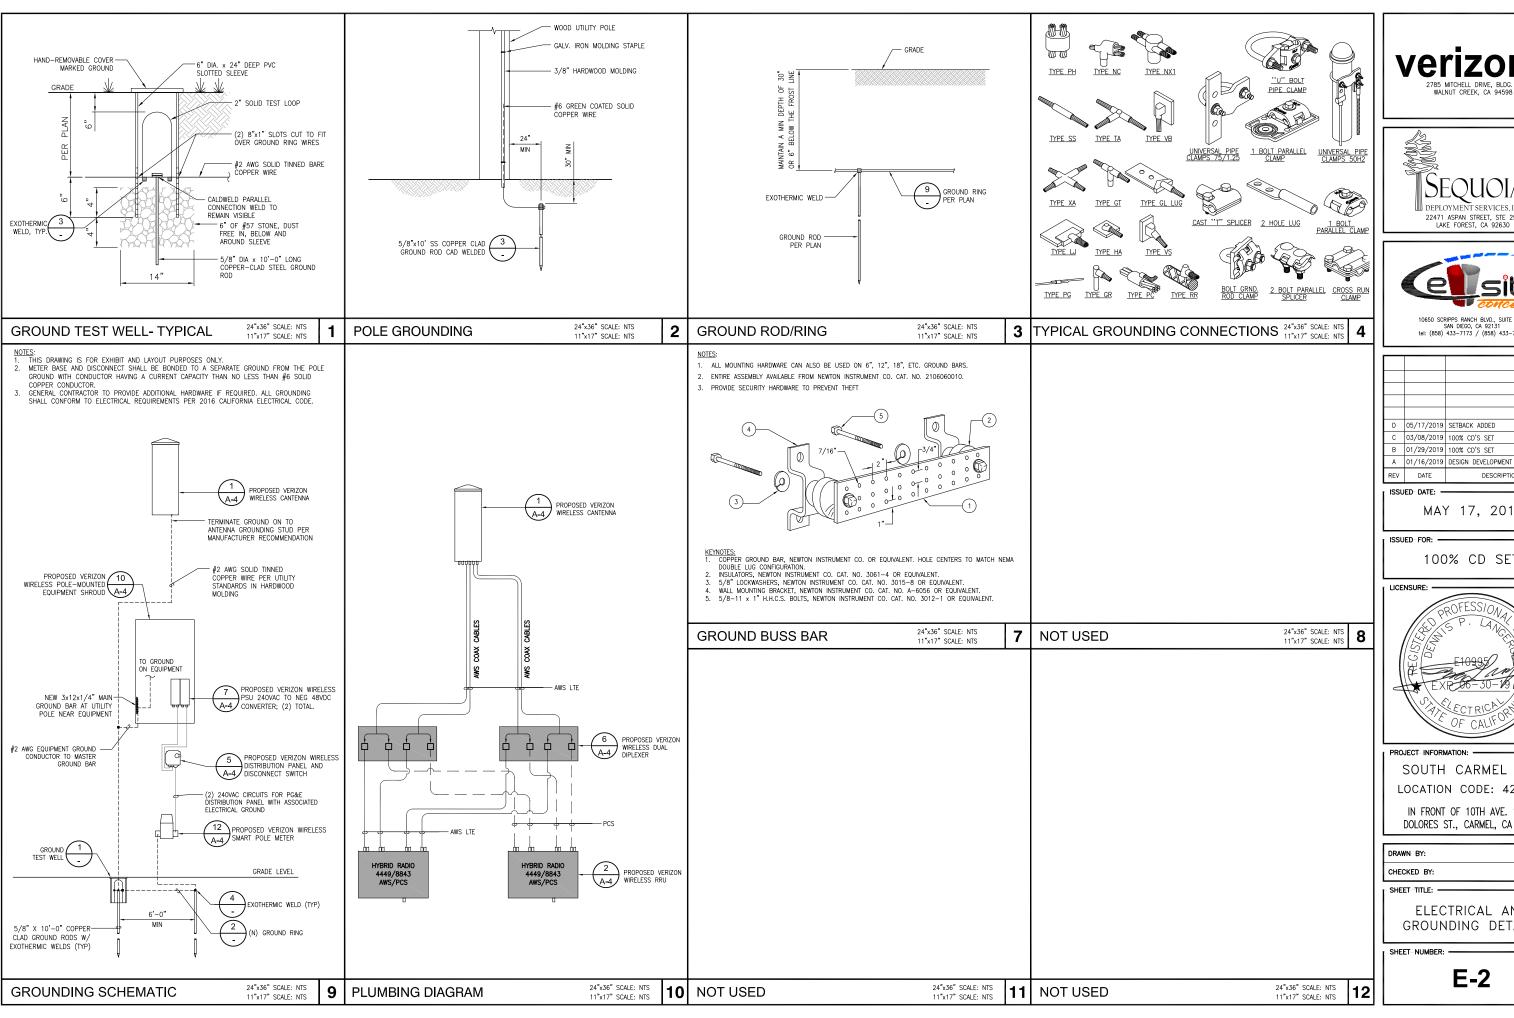







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П	D	05/17/2019	SETBACK ADDED
П	С	03/08/2019	100% CD'S SET

ISSUED DATE:

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DESCRIPTION

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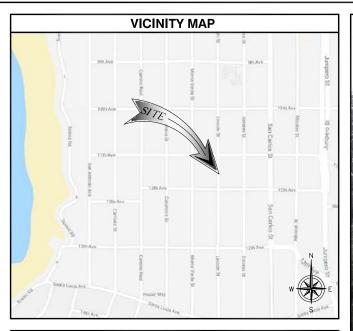
DRAWN BY:	МАМ
CHECKED BY:	RGG

SHEET-TITLE: -

ELECTRICAL AND GROUNDING DETAILS

SHEET NUMBER:

E-2



SITE INFORMATION

PACIFIC GAS & ELECTRIC 245 MARKET ST., MAIL CODE N10D SAN FRANCISCO, CA 94105 CONTACT: DAVID 7FNNFR PH: (415) 847-0283

APPLICANT:

VERIZON WIRELESS 2785 MITCHELL DRIVE, BLDG. 9 WALNUT CREEK, CA 94598

LATITUDE (NAD 83): LONGITUDE (NAD 83): GROUND ELEVATION

-121'55'24.50" W ±134.11' AMSL

36'32'53.65" N

CITY OF CARMEL BY THE SEA ZONING JURISDICTION PROPOSED USE UNMANNED TELECOMMUNICATIONS FACILITY

PROJECT TEAM

TRAFFIC CONTROL NOTE

PRIOR TO STARTING WORK, AND A MINIMUM OF FIVE (5) DAYS IF WORK WILL AFFECT A BUS STOF OR AN EXISTING TRAFFIC SIGNAL, OR IF WORK WILL REQUIRE A ROAD OR ALLEY CLOSURE.

APPLICANT:
VERIZON WIRELESS
2785 MITCHELL DRIVE, BLDG. 9
WALNUT CREEK, CA 94598
CONTACT: MICHELLE MARTINEA

PHONE: (925) 588-9840 EMAIL: michelle.martinea@verizonwireless.com

HONE: (510) 414-8896

ARCHITECT/ENGINEERING: CELLSITE CONCEPTS 10650 SCRIPPS RANCH BLVD., SUITE 224

SAN DIEGO, CA 92131 CONTACT: REGGIE GABRIEI PHONE: (619) 200-7190 EMAIL: reggie.gabriel@cellsite.net

<u>SITE ACQUISITION:</u> SEQUOIA DEPLOYMENT SERVICES, INC. 22471 ASPAN ST., SUITE #290 LAKE FOREST, CA 92630 CONTACT: CHELSEA MANUTO

PHONE: (760) 445-1985 EMAIL: chelsea.manuto@seauoia-ds.con

CONSTRUCTION: SEQUOIA DEPLOYMENT SERVICES, INC. 22471 ASPAN ST., SUITE #290 LAKE FOREST, CA 92630 CONTACT: PETE SHUBIN PHONE: (714) 478-3197 EMAIL: pete.shubin@sequoia-ds.com

ZONING: SEQUOIA DEPLOYMENT SERVICES, INC. 22471 ASPAN ST., SUITE #290 LAKE FOREST, CA 92630 CONTACT: MICHAEL NAZAROFF PHONE: (562) 237-6380
EMAIL: michael.nazaroff@sequoia-ds.com



DRAWING INDEX				
SHEET NO:	SHEET TITLE			
T-1	TITLE SHEET			
T-2	NOTES AND SPECIFICATIONS			
LS-1	TOPOGRAPHIC SURVEY			
A-1	SITE PLAN			
A-2	ENLARGED SITE PLAN AND EQUIPMENT / ANTENNA LAYOUTS			
A-3	ARCHITECTURAL ELEVATIONS			
A-4	ARCHITECTURAL ELEVATIONS			
A-5	DETAILS			
A-6	DETAILS			
E-1	ELECTRICAL NOTES AND SINGLE LINE DIAGRAM			
E-2	ELECTRICAL AND GROUNDING DETAILS			

PROJECT DESCRIPTION

THE PROJECT CONSISTS OF INSTALLATIONS OF TELECOMMUNICATIONS EQUIPMENT FOR VERIZON WIRELESS O COLLOCATE ON NEW PG&E POLE. THE INSTALLATIONS ENTAILS:

- REMOVE EXISTING 40' POLE IN RIGHT OF WAY
- INSTALL (1) PROPOSED 50'-0" WOOD POLE, CLASS TBD, IN RIGHT OF WAY
 INSTALL (1) PROPOSED VERIZON WIRELESS 4'-0" HIGH CANTENNA ON POLE
- INSTALL (1) PROPOSED VERIZON WIRELESS CANTENNA MOUNTING BRACKET PROPOSED VERIZON WIRELESS EQUIPMENT STANDOFF
- INSTALL (1) PROPOSED VERIZON WIRELESS EQUIPMENT SHROUD WITH REMOTE RADIO UNITS (RRU).
- DIPLEXER(S), PSU(S) AND FIBER DEMARC.
- INSTALL (1) PROPOSED VERIZON WIRELESS SMART POLE METER
- INSTALL (1) PROPOSED VERIZON WIRELESS DISTRIBUTION PANEL AND DISCONNECT SWITCH

APPLICABLE CODES

NL WORK AND MATERIALS SHALL BE PERFORMED AND INSTALLED IN ACCORDANCE WITH THE CURRENT EDITIONS OF THE FOLLOWING CODES AS ADOPTED BY THE LOCAL GOVERNING AUTHORITIES THE CONTRACTOR SHALL SUBMIT A TRAFFIC CONTROL PLAN (11"X17") FOR APPROVAL PRIOR TO STARTING WORK. THE PLAN SHOULD BE SUBMITTED TO THE TRAFFIC CONTROL PERMIT COUNTER. CONTRACTOR SHALL OBTAIN A TRAFFIC CONTROL PERMIT A MINIMUM OF TWO (2) WORKING DAYS CALIFORNIA ADMINISTRATIVE CODE (INCL TITLE 24 & 25)
2016 CALIFORNIA BUILDING CODE
LOCAL BUILDING CODE

- CITY/COUNTY ORDINANCES

- ANSI/EIA-222-G LIFE SAFETY CODE NFPA-101
 2016 CALIFORNIA ELECTRICAL CODE
 CA PUBLIC UTILITIES COMMISSION ORDER (GO 95 AND GO 128)

Verizon

PROJECT TYPE: POLYGON **SOUTH CARMEL 004**

IFO LINCOLN ST. 3NE 12TH AVE., **CARMEL, CA 93923**

LOCATION CODE: 428219

SITE: (PG&E POLE # TBD)

GENERAL NOTES

- LOCATIONS OF UNDERGROUND UTILITIES SHOWN ON THE DRAWINGS WERE OBTAINED BY A SEARCH OF AVAILABLE RECORDS. NEITHER THE OWNER NOR THE ENGINEER ASSUMES ANY RESPONSIBILITY FOR UTILITIES OR STRUCTURES NOT SHOWN OR NOT IN THE LOCATION SHOWN ON THE DRAWINGS.
- THE CONTRACTORS SHALL INSTALL ALL EQUIPMENT AND MATERIALS IN ACCORDANCE WITH MANUFACTURER'S RECOMMENDATIONS UNLESS SPECIFICALLY INDICATED OTHERWISE, OR WHERE LOCAL CODES OR REGULATIONS TAKE PRECEDENCE.
- APPROVAL OF THESE PLANS BY THE CITY ENGINEER DOES NOT AUTHORIZE ANY WORK TO BE PERFORMED UNTIL A PERMIT HAS BEEN ISSUED.
- UPON ISSUANCE OF A PERMIT, NO WORK WILL BE PERMITTED ON WEEKENDS OR HOLIDAYS WITHOUT PERMISSION FROM THE ENGINEERING DEPARTMENT
- THE CONTRACTOR SHALL TAKE ALL PRECAUTIONARY MEASURES THE CONTRACTOR STALL TAKE ALL PRECAUTIONARY MEASURES INCESSARY TO PROTECT FROM DAMAGING EXISTING IMPROVEMENTS WHICH ARE TO REMAIN IN PLACE. CONTRACTOR SHALL, AT HIS OWN EXPENSE, REPAIR, REPLACE OR RECONSTRUCT ALL SUCH IMPROVEMENTS OR OTHER STRUCTURES DAMAGED BY HIS WORK, TO THE ENGINEER'S SATISFACTION.
- THE CONTRACTOR SHALL BE RESPONSIBLE FOR SURVEY MONUMENTS AND/OR VERTICAL CONTROL BENCHMARKS WHICH ARE DISTURBED OR DESTROYED BY CONSTRUCTION. A LAND SURVEYOR MUST FILED LOCATE, REFERENCE, AND/OR PRESERVE ALL HISTORICAL OR CONTROLLING MONUMENTS PRIOR TO ANY EARTHWORK, IP DESTROYED, SUCH MONUMENTS BY A LAND SURVEYOR REPLACED WITH APPROPRIATE MONUMENTS BY A LAND SURVEYOR A CORNER RECORD OF SURVEY, AS APPROPRIATE, SHALL BE FIELD AS REQUIRED BY THE PROFESSIONAL LAND SURVEYORS ACT. IF ANY VERTICAL CONTROL IS TO BE DISTURBED OR DESTROYED, THE JURISDICTION'S FIELD SURVEY DIVISION MUST BE NOTIFIED, IN WRITING, AT LEAST 3 DAYS FROM OCCURRENCE. THE CONTRACTOR WILL BE RESPONSIBLE FOR THE COST OF REPLACING ANY VERTICAL CONTROL BENCHMARKS DESTROYED BY THE CONSTRUCTION
- CONTRACTOR SHALL BE RESPONSIBLE FOR THE POTHOLE AND LOCATING OF ALL EXISTING UTILITIES THAT CROSS THE PROPOSITENCH LINE AND MUST MAINTAIN 1 FOOT MINIMUM VERTICAL
- DO NOT EXCAVATE OR DISTURB BEYOND THE PROPERTY LINES OR LEASE LINES, UNLESS OTHERWISE NOTED.
- CONTRACTOR SHALL REPLACE OR REPAIR ALL TRAFFIC SIGNAL

- 10. CONTRACTOR SHALL NOTIFY THE JURISDICTION A MINIMUM OF 48 HOURS PRIOR TO COMMENCING WORK WITHIN 10 FEET OF ALL SEWER, WATER, AND STORM DRAIN MAIN
- 11 "PUBLIC IMPROVEMENT SUBJECT TO DESUETUDE OR DAMAGE." IF REPAIR OR REPLACEMENT OF SUCH PUBLIC IMPROVEMENTS IS REQUIRED, THE OWNER SHALL OBTAIN THE REQUIRED PERMITS FOR WORK IN PUBLIC RIGHT-OF-WAY, SATISFACTORY TO THE PERMIT-ISSUING AUTHORITY.
- 12. THE CONTRACTOR SHALL MAKE ARRANGEMENTS FOR A PRE-CONSTRUCTION MEETING WITH THE CITY FIELD ENGINEERING DIVISION PRIOR TO ANY DISTURBANCE TO THE SITE, EXCLUDING UTILITY MARK-OUTS AND SURVEYING.
- 13. MANHOLES OR COVERS SHALL BE LABELLED "NAME OF COMPANY"
- 14. CONTRACTOR SHALL IMPLEMENT AN EROSION AND SEDIMENT CONTROL PROGRAM DURING THE PROJECT CONSTRUCTION ACTIVITIES. THE PROGRAM SHALL MEET THE APPLICABLE REQUIREMENTS OF THE STATE WATER RESOURCE CONTROL
- 15. THE CONTRACTOR SHALL HAVE EMERGENCY MATERIALS AND EQUIPMENT ON HAND FOR UNFORESEEN STIUATIONS, SUCH AS DAMAGE TO UNDERGROUND WATER, SEWER, AND STORM DRAIN FACILITIES WHEREBY FLOWS MAY GENERATE EROSION AND SEDIMENT POLLUTION.
- 16. THE CONTRACTOR SHALL VERIEY LOCATION ALL EXISTING UNDERGROUND UTILITIES INCLUDING SEWER LATERALS & WATER SERVICES TO INDIVIDUAL LOTS OF BOTH VERTICAL AND HORIZONTAL PRIOR TO COMMENCING IMPROVEMENTS OPERATIONS.
- LOCATION AND ELEVATIONS OF IMPROVEMENTS, TO BE MET BY WORK, SHALL BE CONFIRMED BY FIELD MEASUREMENTS PRIOF TO CONSTRUCTION OF NEW WORK
- 18 GRADES SHOWN ARE FINISH GRADES, CONTRACTOR SHALL DETERMINE NECESSARY SUB GRADE ELEVATIONS AND SHALL CONSTRUCT SMOOTH TRANSITION BETWEEN FINISH GRADES
- 19. THE CONTRACTOR SHALL SUBMIT WORK PLANS FOR ALL BORE OPERATIONS TWO WEEKS PRIOR TO COMMENCING WORK
- 20. THE CONTRACTOR SHALL BE TOTALLY RESPONSIBLE FOR COMPLIANCE WITH THE PROVISIONS OF THE STATE OF

- 21. CONTRACTOR AGREES THAT HE SHALL ASSUME SOLE
 RESPONSIBILITY FOR JOB SITE CONDITION DURING THE COURSE
 OF CONSTRUCTION OF THIS PROJECT, INCLUDING SAFETY OF ALL PERSONS AND PROPERTY: THAT THIS FOUIPMENT SHALL APPLY PERSONS AND PYOPERTY; THAT THIS EQUIPMENT SHALL APPLY CONTINUOUSLY AND NOT BE LIMITED TO NORMAL WORKING HOURS; AND THAT THE CONTRACTOR SHALL DEFEND, INDEMNIFY AND HOLD THE OWNER AND THE ENGINEER HARMLESS FROM AN AND ALL LUABILITY, REAL OR ALLEGED IN CONNECTION WITH THE PERFORMANCE OF WORK ON THIS PROJECT, EXCEPTING FOR LIABILITY ARISING FROM SOLE NEGLIGENCE OF THE OWNER OR THE DEVINE OF THE OWNER OR THE ENGINEER.
- 22. THE LOCATIONS OF ALL EXISTING UTILITIES SHOWN ON THESE THE LOCATIONS OF ALL EXISTING UTILITIES SHOWN ON THESE PLANS ARE FROM EXISTING RECORDS AND CORROBORATED, WHERE POSSIBLE WITH FIELD TIES. THE CONTRACTOR IS RESPONSIBLE FOR CONFIRMING THE LOCATIONS SHOWN, BOTH HORIZONTALLY AND VERTICALLY PRIOR TO CONSTRUCTION. IF EXISTING LOCATIONS VARY SUBSTANTIALLY FROM THE PLANS, THE ENGINEER SHOULD BE NOTIFIED TO MAKE ANY CONSTRUCTION CHANGES REQUIRED.
- AS-BUILT DRAWINGS MUST BE SUBMITTED TO THE CITY ENGINEER PRIOR TO ACCEPTANCE OF THIS PROJECT.
- 24. ALL NEW AND EXISTING UTILITY STRUCTURES ON SITE AND IN AREAS TO BE DISTURBED BY CONSTRUCTION SHALL BE ADJUSTED TO FINISH ELEVATIONS PRIOR TO FINAL INSPECTION OF WORK.
- 25. ANY DRAIN AND/OR FIELD TILE ENCOUNTERED/DISTURBED DURING CONSTRUCTION SHALL BE RETURNED TO IT'S ORIGINAL CONDITION PRIOR TO COMPLETION OF WORK, SIZE, LOCATION AND TYPE OF ANY UNDERGROUND UTILITIES OR IMPROVEMENTS SHALL BE ACCURATELY NOTED AND PLACED ON "AS-BUILT" DRAWINGS BY GENERAL CONTRACTOR, AND ISSUED TO THE ARCHITECT OR ENGINEER AT COMPLETION OF PROJECT.
- 26. ALL TEMPORARY EXCAVATIONS FOR THE INSTALLATION OF FOUNDATIONS, UTILITIES, ETC., SHALL BE PROPERLY LAID BACK OR BRACED IN ACCORDANCE WITH THE CORRECT OCCUPATIONAL SAFETY AND HEALTH ADMINISTRATION (OSHA) REQUIREMENTS.







SAN DIEGO, CA 92131 tel: (858) 433-7173 / (858) 433-7176

С	05/17/2019	SETBACK ADDED
В	03/08/2019	100% CD'S
A	02/01/2019	90% CD'S SET
REV	DATE	DESCRIPTION

MAY 17, 2019

100% CD SET

LICENSURE:



SOUTH CARMEL 004 LOCATION CODE: 428219

IFO LINCOLN ST. 3NE 12TH AVE., CARMEL, CA 93923

TITLE SHEET

T-1

ACCESSIBILITY NOTE

HE FACILITY IS UNMANNED AND NOT FOR HUMAN HABITATION. HANDICAPPED ACCESS REQUIREMENTS ARE NOT REQUIRED IN ACCORDANCE WITH THE 2016 CALIFORNIA BUILDING CODE. A RECHNICIAN WILL WISIT THE SITE AS REQUIRED FOR ROUTINE MAINTENANCE. THE PROJECT WILL NOT SESULT IN ANY SIGNIFICANT DISTURBANCE OR EFFECT ON DRAINAGE; NO SANTIARY SEWER SERVICE, POTABLE WATER, OR TRASH DISPOSAL IS REQUIRED AND NO COMMERCIAL SIGNAGE IS NEW.

THE TELECOMMUNICATIONS EQUIPMENT SPACE SHOWN ON THESE PLANS IS NOT CUSTOMARILY OCCUPIED. WORK TO BE PERFORMED IN THIS FACILITY CANNOT REASONABLY BE PERFORMED BY PERSONS WITH A SEVERE IMPAIRMENT: MOBILITY, SIGHT, AND/OR HEARING. THEREFORE, PER 2016 CALIFORNIA BUILDING CODE SECTION 1105B.3.4, AND/OR 11B-203.5 OF 2016 CALIFORNIA BUILDING CODE, EXCEPTION 1, THIS FACILITY SHALL BE EXEMPTED FROM ALL TITLE 24 ACCESS

DO NOT SCALE **DRAWINGS**

SUBCONTRACTOR SHALL VERIEY ALL PLANS WORK OR BE RESPONSIBLE FOR SAME. IF USING 11"X17" PLOT, DRAWINGS WILL BE HALF SCALE. Dig Alert

Know what's below.
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ABBREVIATIONS

AB AC A/C ADJ A.F.F. ARCH APPROX	ANCHOR BOLT ASPHALTIC CONCRETE AIR CONDITIONING ADJUSTABLE ABOVE FINISH FLOOR ARCHITECTURAL APPROXIMATELY	JT LAM LBS LT LA LNA	JOINT LAMINATED POUNDS LIGHT LIGHTNING ARRESTOR LOW NOISE AMPLIFIER
	ABOVE GRADE LEVEL ABOVE MEAN SEA LEVEL	MFR MAT MAX	MANUFACTURER MATERIAL MAXIMUM
BLKG BOT	BOARD BUILDING BLOCKING BOTTOM BASEMENT BASE TRANSCEIVER STATION	MECH MIN MISC ML MO MS MTD MTL	MECHANICAL MINIMUM MISCELLANEOUS METAL LATH
C CEM CL CLG CLR COL	COURSE(S) CEMENT CHAIN LINK CEILING CLEAR COLUMN	(N) NIC NO NTS	NEW NOT IN CONTRACT NUMBER NOT TO SCALE
CONC CONST CONT CORR CO	COLOMN CONCRETE CONSTRUCTION CONTINUOUS CORRIDOR CONDUIT ONLY	OA O.C. OPNG OPP	OVERALL ON CENTER OPENING OPPOSITE
00	COMBOIL ONE	DARTN	DARTITION

DTL DWG

GA GALV

GYP GFCI

GND

HSS

HT HV

EXISTING

EVATION OUIPMENT

FACE OF STUDS FINISH SURFACE FOOT, FEET

FINISH WALL FINISH GRADE FUTURE

GAUGE GALVANIZED GLASS

INSIDE DIMENSION INSULATION INTERIOR

SECTION NUMBER

- SHEET NUMBER

- DETAIL NUMBER

- SHEET NUMBER

- SECTION NUMBER

- SHEFT NUMBER

- DETAIL NUMBER

- SHEET NUMBER

— F— F— F—

----E/F----E/F---

\x-x

- NUMBER NOT TO SCALE

PARTITION

PL PLAS PLYWD POC PROP PT PLYWOOD POINT OF CONNECTION PROPERTY PRESSURE TREATED R REQD RD RM RMS RO RISER REQUIRED ROOF DRAIN

PARTN

- ROOMS ROUGH OPENING
- SOLID CORE SCHEDULE SECTION SHEET SIMILAR SPECIFICATIONS STAINLESS STEEL STEFI TRUCTURAL SUSPENDED
- SC SCHED SECT SHT SIM SPECS SS STL STOR STOR STUCT SUSP SW SWBO SWITCHBOARD THICK
 TENANT IMPROVEMENT
 TOWER MOUNTED AMPLIFIER
 TOP OF SURFACE
 TUBE STEEL
 TYPICAL THK TI
- UNO UNLESS NOTED OTHERWISE

CENTERLINE

ANGLE PROPERTY LINE

BUILDING SECTION REFERENCE

DETAIL REFERENCE

DETAIL SECTION

EXTERIOR FLEVATION

REFERENCE

REFERENCE

FENCING

PROPERTY LINE

FLECTRICAL SERVICE

ELECTRICAL/FIBER SERVICE

FIBER SERVICE

- VCT VERT V.I.F. VG VINYL COMPOSITION TILE VERTICAL GROUND FAULT CIRCUIT
- VERIFY IN FIELD VERTICAL GRAIN GROUND

SYMBOLS:

- HOLLOW CORE
 HARDWARE
 HEATER
 HOLLOW METAL
 HORIZONTAL
 HOUR
 HOLLOW STRUCTURAL
 SECTION
 HEIGHT RESISTANT XFMR TRANSFORMER @ ΑT CHANNEL HIGH VOLTAGE
 - THE CONTRACTOR'S CONSTRUCTION METHODS. THE INVESTIGATION, DESIGN, SAFETY, DEQUACY AND INSPECTION OF BRACING, SHORING, TEMPORARY SUPPORTS, ETC. IS HE SOLE RESPONSIBILITY OF THE CONTRACTOR.

 - NEW CONSTRUCTION ADDED TO EXISTING CONSTRUCTION SHALL BE MATCHED IN FORM, TEXTURE, MATERIAL AND PAINT COLOR EXCEPT AS NOTED IN THE PLANS.
 - WHERE SPECIFIED, MATERIALS TESTING SHALL BE TO THE LATEST STANDARDS AVAILABLE AS REQUIRED BY THE LOCAL GOVERNING AGENCY RESPONSIBLE FOR RECORDING THE RESULTS.
 - ALL GENERAL NOTES AND STANDARD DETAILS ARE THE MINIMUM REQUIREMENTS TO BE USED IN CONDITIONS WHICH ARE NOT SPECIFICALLY SHOWN OTHERWISE.
 - STANDARDS, IF A CONTRACTOR HAS A QUESTION REGARDING THEIR EXACT MEANING. THE ARCHITECT/ENGINEER SHALL BE NOTIFIED FOR CLARIFICATIONS.
 - CONTRACTORS SHALL VISIT THE SITE PRIOR TO BID TO ASCERTAIN CONDITIONS WHICH MAY ADVERSELY AFFECT THE WORK OR COST THEREOF.
 - TO THE EXISTING WORK.
 - 22. REPRESENTATIONS OF TRUE NORTH, OTHER THAN THOSE FOUND ON THE PLOT OF
 - 23. NO CHANGES ARE TO BE MADE TO THESE PLANS WITHOUT THE KNOWLEDGE AND NO CHANGES ARE 10 BE MADE TO THESE PLANS WITHOUT THE KNOWLEDGE AND WRITTEN CONSENT OF THE ARCHITECT/ ENGINEER. UNAUTHORIZED CHANGES RENDER THESE DRAWINGS VOID. THIS INCLUDES THAT THE CONTRACTOR SHALL NOT BE RELIEVED OF ANY DEVIATION FROM THE PLANS BY THE PROFESSIONAL'S OF RECORD REVIEW OF SHOP DRAWINGS, PRODUCT DATA, ETC. UNLESS THE CONTRACTOR HAS SPECIFICALLY INFORMED THE PROFESSIONAL OF RECORD OF SUCH DEVIATION IN WRITING AT THE TIME OF SUBMISSION, AND THE PROFESSIONAL OF RECORD HAS GIVEN WRITTEN APPROVAL TO THE SPECIFIC DEVIATION.
 - 24. ANY REFERENCE TO THE WORDS "APPROVED" OR "APPROVAL" IN THESE DOCUMENTS SHALL BE HERE DEFINED TO MEAN CENERAL ACCEPTANCE OR REVIEW AND SHALL NOT RELIEVE THE CONTRACTOR AND/OR HIS SUB-CONTRACTORS OF ANY LIABILITY IN FURNISHING THE REQUIRED MATERIALS OR LABOR SPECIFIED.
 - 25. KEEP GENERAL AREA CLEAN, HAZARD FREE, AND DISPOSE OF ALL DIRT, DEBRIS, RUBBISH AND REMOVE EQUIPMENT NOT SPECIFIED AS REMAINING ON THE PROPERTY. LEAVE PREMISES IN CLEAN CONDITION AND FREE FROM PAINT SPOTS, DUST OR SMUDGES OF ANY NATURE

CONTRACTOR NOTES:

- . PLANS ARE INTENDED TO BE DIAGRAMMATIC OUTLINE ONLY, UNLESS NOTED OTHERWISE. THE WORK SHALL INCLUDE FURNISHING MATERIALS, EQUIPMENT, APPURTENANCES AND LABOR NECESSARY TO COMPLETE ALL INSTALLATIONS AS INDICATED ON THE DRAWINGS.
- LABOR NECESSARY TO COMPLETE ALL INSTALLATIONS AS INDICATED ON THE DRAWINGS.

 2. ALL EXISTING UTILITIES, FACILITIES, CONDITIONS, AND THEIR DIMENSIONS SHOWN ON THE PLAN HAVE BEEN PLOTTED FROM AVAILABLE RECORDS. THE ARCHITECT/ENGINEER AND THE OWNER ASSUME NO RESPONSIBILITY WHATSOEVER AS TO THE SUFFICIENCY OR THE ACCURACY OF THE INFORMATION SHOWN ON THE PLANS, OR THE MANNER OF THEIR REMOVAL, OR ADJUSTMENT. CONTRACTORS SHALL BE RESPONSIBLE FOR DETERMINING EXACT LOCATION OF ALL EXISTING UTILITIES AND FACILITIES PRIOR TO START OF CONSTRUCTION. CONTRACTORS SHALL ALSO OBTAIN FROM EACH UTILITY COMPANY DETAILED INFORMATION RELATIVE TO WORKING SCHEDULES AND METHODS OF REMOVING OR ADJUSTING EXISTING UTILITIES. ANY DISCREPANCIES OR DOUBTS AS TO THE INTERPRETATION OF PLANS SHOULD BE IMMEDIATELY REPORTED TO THE ARCHITECT/ENGINEER FOR RESOLUTION AND INSTRUCTION. AND NO FURTHER WORK ARCHITECT/ENGINEER FOR RESOLUTION AND INSTRUCTION, AND NO FURTHER WORK SHALL BE PERFORMED UNTIL THE DISCREPANCY IS CHECKED AND CORRECTED BY THE ARCHITECT/ENGINEER. FALUER TO SECURE SUCH INSTRUCTION MEANS CONTRACTOR WILL HAVE WORKED AT HIS/HER OWN RISK AND EXPENSE.
- WILL HAVE WORKED AT HIS/HER OWN HISH AND EXPENSE.

 CONTRACTOR SHALL DETERMINE ACTUAL ROUTING OF CONDUIT, POWER, T1 OR FIBER CABLES, GROUNDING CABLES AS SHOWN ON THE POWER, GROUNDING AND TELCO PLAN DRAWING. CONTRACTOR SHALL UNILIZE EXISTING TRAYS AND/OR SHALL ADD NEW TRAYS AS NECESSARY. CONTRACTOR SHALL CONTRINE THE ACTUAL ROUTING WITH THE CONTRACTOR. ROUTING OF TRENCHING SHALL BE APPROVED BY CONTRACTOR
- ALL MATERIALS AND CONSTRUCTION SHALL BE IN CONFORMANCE WITH THE BUILDING CODE AND ALL OTHER GOVERNING CODES. THESE NOTES SHALL BE CONSIDERED A PART OF THE WRITTEN SPECIFICATIONS.
- THE CONTRACTOR SHALL NOTIFY ARCHITECT/ENGINEER OF ANY ERRORS, OMISSIONS, OR DISCREPANCIES AS THEY MAY BE DISCOVERED IN THE PLANS, SPECIFICATIONS, & NOTES PRIOR TO STARTING CONSTRUCTION, INCLUDING BUT NOT LIMITED BY DEMOLITION. THE CONTRACTOR SHALL BE RESPONSIBLE FOR CORRECTING ANY ERROR, OMISSION, OR INCONSISTENCY AFTER THE START OF CONSTRUCTION WHICH HAS NOT OMISSION, ON INCOMPRISED A TEATH OF CONTROLLING MINISTRUS MINISTRUS MEETING METHOD OF THE ARCHITECT/ENGINEER AND SHALL INCUR ANY EXPENSES TO RECTIFY THE SITUATION. THE METHOD OF CORRECTION SHALL BE APPROVED BY THE ARCHITECT/ENGINEER.
- APPROVED BY THE ARCHITECT/ENGINEER.
 PRIOR TO STARTING CONSTRUCTION THE CONTRACTOR HAS THE RESPONSIBILITY TO LOCATE ALL EXISTING UTILITIES, WHETHER OR NOT SHOWN ON THE PLANS, AND TO PROTECT THEM FROM DAMAGE. THE CONTRACTOR OR SUBCONTRACTOR SHALL BEAR THE EXPENSE OF REPARING OR REPLACING ANY DAMAGE TO THE UTILITIES CAUSED DURING THE EXECUTION OF THE WORK. WHERE REQUIRED FOR THE PROPER EXECUTION OF THE WORK, UTILITIES SHALL BE RELOCATED AS DIRECTED BY ENGINEERS. EXTREME CAUTION SHOULD BE USED BY THE CONTRACTOR WHEN EXCAVATING OR PIER DRILLING AROUND OR NEAR UTILITIES. CONTRACTOR SHALL PROVIDE SAFETY TRAINING FOR THE WORKING CREW.
- ALL EXISTING INACTIVE SEWER, WATER, GAS, ELECTRIC AND OTHER UTILITIES, WHICH INTERFERE WITH THE EXECUTION OF THE WORK, SHALL BE REMOVED AND SHALL BE CAPPED, PLUGGED OR OTHERWISE DISCONTINUED AT POINTS WHICH WILL NOT INTERFERE WITH THE EXECUTION OF THE WORK, SUBJECT TO THE APPROVAL OF THE
- ENGINEER.

 8. A COPY OF THE APPROVED PLANS SHALL BE KEPT IN A PLACE SPECIFIED BY THE GOVERNING AGENCY, AND BY LAW SHALL BE AVAILABLE FOR INSPECTION AT ALL TIMES. IT IS THE CONTRACTOR'S RESPONSIBILITY TO ENSURE ALL CONSTRUCTION SET REFLECT THE SAME INFORMATION AS THE APPROVED PLANS. THE CONTRACTOR SHALL ALSO MAINTAIN ONE SET OF PLANS AT THE SITE FOR THE PURPOSE OF DOCUMENTING ALL AS—BULLT (FANNES, REVISIONS, ADDEDNUMS, OR CHANGE ORDERS. THE CONTRACTOR SHALL FORWARD THE AS—BULLT/HIRED DRAWINGS TO THE ARCHITECT/ENGINEER AT THE CONCLUSION OF THE PROJECT.
- 9. THE CONTRACTOR SHALL BE RESPONSIBLE FOR THE COMPLETE SECURITY OF THE SITE WHILE THE WORK IS IN PROGRESS UNTIL THE JOB IS COMPLETE.
- THE CONTRACTOR IS RESPONSIBLE TO PROVIDE TEMPORARY POWER, WATER, AND TOILET FACILITIES AS REQUIRED BY THE PROPERTY OWNER OR GOVERNING AGENCY.

 THE CONTRACTOR SHALL BE RESPONSIBLE FOR COMPLYING WITH ALL SAFETY PRECAUTIONS AND REGULATIONS DURING THE WORK. THE ENGINEER WILL NOT ADVISE ON, NOR PROVIDE DIRECTION, AS TO SAFETY PRECAUTIONS AND PROGRAMS.
- THE CONTRACTOR IS SOLELY RESPONSIBLE FOR ALL CONSTRUCTION MEANS, METHODS, TECHNIQUES, PROCEDURES, SEQUENCING, AND COORDINATING ALL PORTIONS OF THE WORK UNDER THE PROJECT. FURTHERMORE, THE STRUCTURE IS DESIONED AS A UNIT UPON COMPLETION. THE CONTRACTOR IS RESPONSIBLE FOR FURNISHING ALL TEMPORARY BRACING AND/OR SUPPORT THAT MAY BE REQUIRED AS THE RESULT OF
- 13. THE CONTRACTOR SHALL BE RESPONSIBLE TO OBTAIN AND PAY FOR ALL PERMITS, LICENSES AND INSPECTIONS WITH RESPECT TO THE WORK TO COMPLETE THE PROJECT. BUILDING PERMIT APPLICATIONS SHALL BE FILED BY THE OWNER OR HIS REPRESENTATIVE. CONTRACTOR SHALL OBTAIN THE PERMIT AND MAKE FINAL PAYMENT OF SAID DOCUMENT(S).
- 14. ALL DIMENSIONS TAKE PRECEDENCE OVER SCALE UNLESS OTHERWISE NOTED.
- THE CONTRACTOR SHALL PROVIDE ALL NECESSARY FRAMING, BACKING, HANGERS, BLOCKING OR SUPPORTS FOR INSTALLATION OF ITEMS INDICATED ON THE DRAWINGS.
- 19. ALL SYMBOLS AND ABBREVIATIONS ARE CONSIDERED CONSTRUCTION INDUSTR
- 21. THE CONTRACTOR SHALL FIELD VERIFY THE DIMENSIONS, ELEVATIONS, ETC. NECESSARY FOR THE PROPER CONSTRUCTION AND ALIGNMENT OF THE NEW PORTION OF THE WORK
- SURVEY DRAWING (SHEET LS1), SHALL NOT BE USED TO IDENTIFY OR ESTABLISH THE BEARING OF TRUE NORTH AT THE SITE. THE CONTRACTOR SHALL RELY SOLELY ON THE PLOT OF SURVEY DRAWING AND ANY SURVEYOR'S MARKINGS AT THE SITE FOR THE PLOT OF SURVEY DRAWING AND ANY SURVEYOR'S MARKINGS AT THE STIE FOR THE ESTABLISHMENT OF TRUE NORTH, AND SHALL NOTIFY THE ARCHITECT/ ENGINEER PRIOR TO PROCEEDING WITH THE WORK. IF ANY DISCREPANCY IS FOUND BETWEEN THE VARIOUS ELEMENTS OF THE WORKING DRAWINGS AND THE TRUE NORTH ORIENTATION AS DEPICTED ON THE CIVIL SURVEY, THE CONTRACTOR SHALL ASSUME SOLE LIABILITY FOR ANY FAILURE TO NOTIFY THE ARCHITECT/ENGINEER.

EQUIPMENT LOCATION

- THE DRAWINGS INDICATE DIAGRAMMATICALLY THE DESIRED LOCATIONS OR ARRANGEMENTS OF CONDUIT RUNS, OUTLETS, EQUIPMENT, ETC., AND ARE TO BE FOLLOWED AS CLOSELY AS POSSIBLE. PROPER DIDDEGMENT MUST BE EXERCISED IN EXECUTING THE WORK SO AS TO SECURE THE BEST POSSIBLE INSTALLATION IN THE AVAILABLE SPACE LIMITATIONS OR INTERFERENCE OF STRUCTURE CONDITIONS
- ENCOUNTERED.

 IN THE EVENT CHANGES IN THE INDICATED LOCATIONS OR ARRANGEMENTS ARE NECESSARY, DUE TO FIELD CONDITIONS IN THE BUILDING CONSTRUCTION OR REARRANGEMENT OF FURNISHINGS OR EQUIPMENT, SUCH CHANGES SHALL BE MADE WITHOUT COST, PROVIDING THE CHANGE IS ORDERED BEFORE THE CONDUIT RUNS, ETC., AND WORK DIRECTLY CONNECTED TO THE SAME IS INSTALLED AND NO EXTRA MATERIALS ARE REQUIRED.
- 3. COORDINATE THE WORK OF THIS SECTION WITH THAT OF ALL OTHER TRADES, WHERE CONFLICTS OCCUR, CONSULT WITH THE RESPECTIVE CONTRACTOR AND COME TO AGREEMENT AS TO CHANGES NECESSARY, OBTAIN WRITTEN ACCEPTANCE FROM ENGINEER FOR THE PROPOSED CHANGES BEFORE

UTILITY SERVICE

- TELEPHONE AND ELECTRICAL METERING FACILITIES SHALL CONFORM TO THE
 REQUIREMENTS OF THE SERVING UTILITY COMPANIES. CONTRACTOR SHALL VERIFY SERVICE
 LOCATIONS AND REQUIREMENTS. SERVICE INFORMATION WILL BE FURNISHED BY THE SERVING UTILITIES.
- 2. CONFORM TO ALL REQUIREMENTS OF THE SERVING UTILITY COMPANIES







C 05/17/2019 SETBACK ADDED B 03/08/2019 100% CD'S A 02/01/2019 90% CD'S SET

REV DATE ISSUED DATE:

MAY 17, 2019

DESCRIPTION

ISSUED-FOR: -

100% CD SET

LICENSURE: PROFESS/ON WAREL B. 뀙 No. C 83930 (★) * Exp. 9 - 30 - 19OF CAL

PROJECT INFORMATION:

SOUTH CARMEL 004 LOCATION CODE: 428219 IFO LINCOLN ST. 3NE 12TH AVE., CARMEL, CA 93923

DRAWN BY SAG CHECKED BY

SHEET-TITLE:

NOTES AND **SPECIFICATIONS**

SHEET-NUMBER:


T-2



- NOTES:

 1. THIS IS NOT A BOUNDARY SURVEY. THIS IS A SPECIALIZED TOPOGRAPHIC MAP. THE PROPERTY LINES AND EASEMENTS SHOWN HEREON ARE FROM RECORD INFORMATION AS NOTED HEREON. CELLSITE CONCEPTS TRANSLATED THE TOPOGRAPHIC SURVEY TO RECORD INFORMATION USING FOUND MONUMENTS SHOWN HEREON. THE LOCATION OF PROPERTY LINES SHOWN HEREON ARE APPROXIMATE AND FOR INFORMATIONAL PURPOSES ONLY. THEY ARE NOT TO BE RELIED UPON AS THE ACTUAL BOUNDARY LINES.
- ANY CHANGES MADE TO THE INFORMATION ON THIS PLAN, WITHOUT THE WRITTEN CONSENT OF CELLSITE CONCEPTS, RELIEVES CELLSITE CONCEPTS OF ANY AND ALL LIARILITY
- 3. THE HEIGHTS AND ELEVATIONS FOR THE TREES, BUSHES AND OTHER LIVING PLANTS SHOWN HEREON, SHOULD BE CONSIDERED APPROXIMATE (+/-) AND ONLY FOR THE DATE OF THIS SURVEY. THEY ARE PROVIDED AS A GENERAL REFERENCE AND SHOULD NOT BE USED FOR DESIGN PURPOSES.
- 4. RIGHT-OF-WAY WAS ESTABLISHED BY LOCATING FOUND CENTERLINE CITY OR COUNTY MONUMENTS. IF CENTERLINE MONUMENTS WERE NOT LOCATABLE, THE CENTERLINE
 OFFSET TIES WERE USED TO ESTABLISH THE INTERSECTIONS. IF NEITHER CENTERLINE
 TIES OR CENTERLINE INTERSECTION MONUMENTS WERE LOCATABLE, EXISTING IMPROVEMENTS WERE USED TO ESTABLISH RIGHT-OF-WAY.

 ALL SHOWN RIGHT-OF-WAY WERE BASED UPON RESEARCH AT COUNTY OR CITY FILES
- ALL SHOWN RIGHT-OF-WAY WERE BASED UPON RESEARCH AT COUNTY OR CITY FILES AND REFLECT THE LATEST RECORDED MAPS, RECORDS OF SURVEY, PARCEL MAPS OR OTHER RECORDS. RIGHT-OF-WAY WILL NOT REFLECT ANY DEDICATION, TAKEN OR OFFERED AFTER THE THE RECORD MAP USED. ALL SURVEYS WERE COMPLETED WITHOUT THE BENEFIT OF A CURRENT TITLE REPORT AND MAY NOT SHOW ADDITIONAL DEDICATIONS NOT SHOWN ON THE RECORD MAPS USED.
- WRITTEN DIMENSIONS SHALL TAKE PREFERENCE OVER SCALED & SHALL BE VERIFIED ON THE JOB SITE. ANY DISCREPANCY SHALL BE BROUGHT TO THE NOTICE OF THE SURVEYOR PRIOR TO COMMENCEMENT OF ANY WORK.
- 7. FIELD SURVEY COMPLETED ON DECEMBER 16, 2018

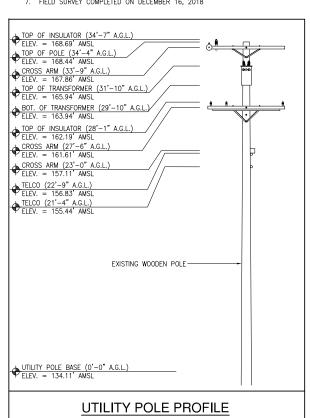

BASIS OF BEARING


THE CENTERLINE OF <u>LINCOLN</u> <u>STREET</u> BEARING <u>N00'00'00"E</u> WAS USED AS BASIS OF BEARING FOR THIS SURVEY.

BASIS OF ELEVATIONS: (NAVD 1988)

ELEVATIONS ARE BASED ON CALVRS G.P.S. BROADCAST COORDINATE VALUES FOR

FLOOD ZONE

SITE IS LOCATED IN FLOOD ZONE "X" AS PER F.I.R.M. MAP NO. 06053C0316H EFFECTIVE DATE 06/21/2017

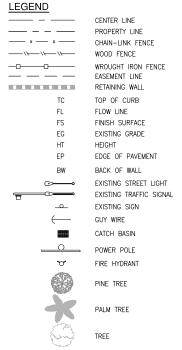

BUSH

EXISTING CONCRETE

MONUMENT FD.


EXISTING GRASS/TURF

MONUMENTS


COORDINATES

1.15

LATITUDE: 36*32'53.65"N (36.548236) LONGITUDE: 121'55'24.50"W (-121.923472)

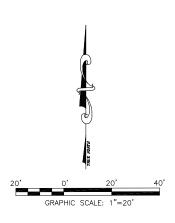

PROPERTY LINES ARE BASED FROM MAP NO. 27474 DATED JANUARY 8, 2005 R.O.S. NO. 21–44 DATED SEPTEMBER 22, 1997 R.O.S. NO. 15–11 DATED JUNE 10, 1987

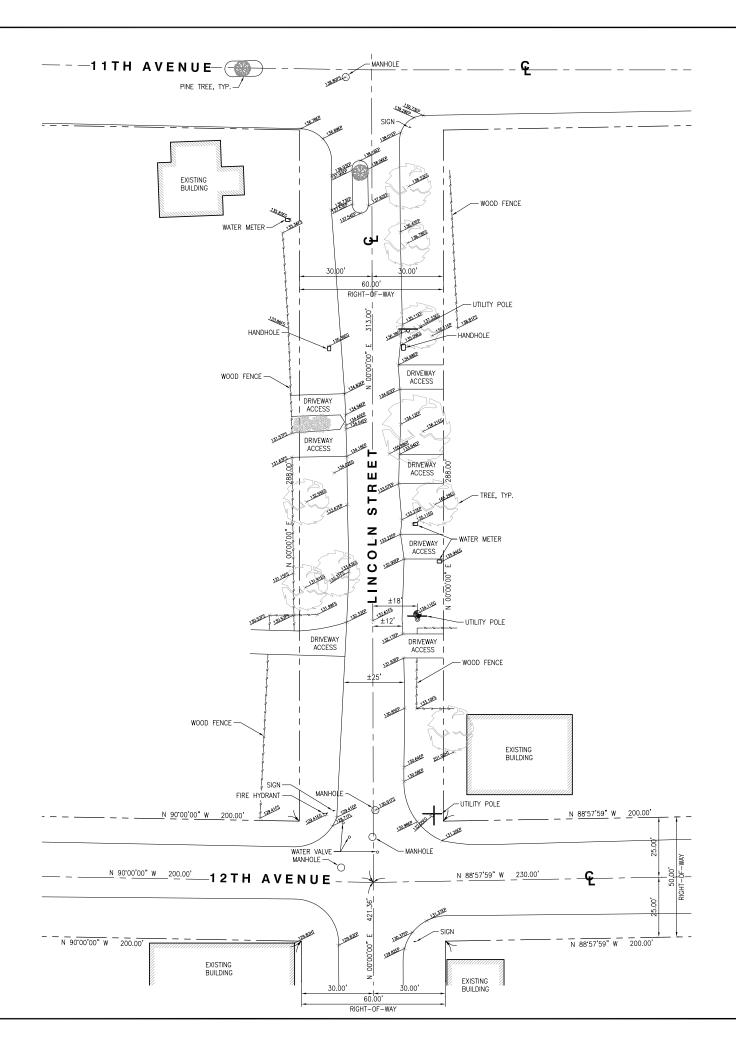








10650 SCRIPPS RANCH BLVD., SUITE 224 SAN DIEGO, CA 92131 tel: (858) 433-7173 / (858) 433-7176

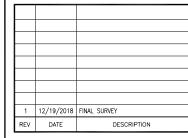

ISSUED-DATE:

DECEMBER 19, 2018

ISSUED-FOR: -

FINAL SURVEY

LICENSURE:

PROJECT INFORMATION:

SOUTH CARMEL 004

IFO LINCOLN ST. 3NE 12TH AVE. CARMEL, CA 93923

DRAWN BY SMS MP

SHEET-TITLE:

TOPOGRAPHIC SURVEY

SHEET-NUMBER:


LS-1

SITE NOTES:

- 1. REPRESENTATIONS OF TRUE NORTH, OTHER THAN THOSE FOUND ON THE PLOT OF SURVEY DRAWINGS SHALL NOT BE USED TO IDENTIFY OR ESTABLISH BEARING OF TRUE NORTH AT THE SITE. THE CONTRACTOR SHALL RELY SOLELY ON THE PLOT OF SURVEY DRAWING AND ANY SURVEYOR'S MARKINGS AT THE SITE FOR THE ESTABLISHMENT OF DRAWING AND AND SHALL NOTIFY THE ARCHITECT/ENGINEER PRIOR TO PROCEEDING WITH THE WORK IF ANY DISCREPANCY IS FOUND BETWEEN THE VARIOUS ELEMENTS OF THE WORKING DRAWINGS AND THE TIVE NORTH ORIENTATION AS DEPICTED ON THE CIVIL SURVEY. THE CONTRACTOR SHALL ASSUME SOLE LIABILITY FOR ANY FAILURE TO NOTIFY THE ARCHITECT/ ENGINEER.
- CONTRACTOR TO VERIFY LOCAL UTILITY REQUIREMENTS FOR DEPTH, SIZES, AND SEPARATION OF CONDUITS PRIOR TO INSTALLATION. NOTIFY CONSTRUCTION MANAGER IMMEDIATELY OF ANY DISCREPANCIES.
- PROPOSED UTILITY SERVICES SHOWN NEED TO BE VERIFIED AND APPROVED BY UTILITY COMPANIES BEFORE START OF CONSTRUCTION. CONTRACTOR TO VERIFY WITH CLIENT PROJECT MANAGER TO OBTAIN FINAL APPROVAL.
- 4. VERIFY, LOCATE, AND PROTECT ALL EXISTING SUBSTRUCTURES AS REQUIRED, CALL DIG ALERT ® (800) 227–2600 48 HOURS BEFORE ANY EXCAVATION. CONTRACTOR IS RESPONSIBLE TO HAVE ALL NON-PUBLIC UTILITIES LOCATED AT THEIR OWN EXPENSE.
- CONTRACTOR SHALL IMMEDIATELY INFORM CLIENT OF ANY ACCIDENTAL DAMAGE TO EXISTING UTILITIES VA PHONE OR EMAIL REGARDLESS OF ABILITY TO REPAIR OR MITIGATE. A FOLLOW-UP EMAIL REPORT WITH DIGITAL PHOTOS WILL BE REQUIRED DAILY UNTIL RESOLUTION HAS BEEN ACCEPTED BY CLIENT, AFFOCTED SERVICE PROVIDERS, AND RECIPIENTS. AT THEIR OWN EXPENSE, CONTRACTOR WILL EXERCISE ALL EFFORTS TO HAVE REPAIRS MADE BY QUALIFIED TECHNICIANS AS APPROVED BY SERVICE PROVIDER.
- REPAIRS MADE BY QUALIFIED TECHNICIANS AS APPRIVED BY SERVICE PROVIDER.

 6. CONTRACTOR SHALL VERIETY ALL EXISTING UTILITIES, BOTH HORIZONTAL AND VERTICALLY, PRIOR TO THE START OF CONSTRUCTION. ANY DISCREPANCIES OR DOUBTS AS TO THE INTERPERTATION OF PLANS SHOULD BE IMMEDIATELY REPORTED TO THE ARCHITECT/ENGINEER FOR RESOLUTION AND INSTRUCTION, AND NO FURTHER WORK SHALL BE REFORMED UNTIL THE DISCREPANCY IS CHECKED AND CORRECTED BY THE ARCHITECT/ENGINEER, FAILURE TO SECURE SUCH INSTRUCTION MEANS CONTRACTOR WILL HAVE WORKED AT HIS/HER OWN RISK AND EXPENSE.
- ALL NEW AND EXISTING UTILITY STRUCTURES ON SITE AND IN AREAS TO BE DISTURBED BY CONSTRUCTION SHALL BE ADJUSTED TO FINISH ELEVATIONS PRIOR TO FINAL INSPECTION OF WORK.
- 8 ANY DRAIN AND YOR FIELD THE ENCOUNTERED/DISTURBED DURING CONSTRUCTION SHALL ANT DRAIN AND TOR FIELD THE ENCOUNTERCY DISTORBED UNRING CONSIDERING THE BE RETURNED TO IT'S ORIGINAL CONDITION PRIOR TO COMPLETION OF WORK, SIZE, LOCATION AND TYPE OF ANY UNDERGROUND UTILITIES OR IMPROVEMENTS SHALL BE ACCURATELY NOTED AND PLACED ON "AS-BUILT" DRAWINGS BY GENERAL CONTRACTOR, AND ISSUED TO THE ARCHITECT OR ENGINEER AT COMPLETION OF PROJECT.
- ALL TEMPORARY EXCAVATIONS FOR THE INSTALLATION OF FOUNDATIONS, UTILITIES, ETC., SHALL BE PROPERLY LAID BACK OR BRACED IN ACCORDANCE WITH THE CORRECT OCCUPATIONAL SAFETY AND HEALTH ADMINISTRATION (OSHA) REQUIREMENTS.
- 10. NEW CONDUITS SHALL BE INSTALLED IN TRENCH SUCH THAT THE TOP OF CONDUIT SHALL HAVE A MINIMUM COVER OF 30-INCHES BELOW ADJACENT EDGE OF PAVEMENT OR ORIGINAL GROUND, WHICHEVER IS LOWER IN ELEVATION.
- ALL PULL BOXES SHALL BE PRECAST REINFORCED CONCRETE AND HAVE NON CONDUCTIVE LIDS. EXISTING PULL BOX COVERS THAT ARE MARKED INCORRECTLY SHALL BE REPLACED.
- 12. REGRADE LANDSCAPING AS NEEDED AND REPLACE DAMAGED IRRIGATION LINES WITHIN



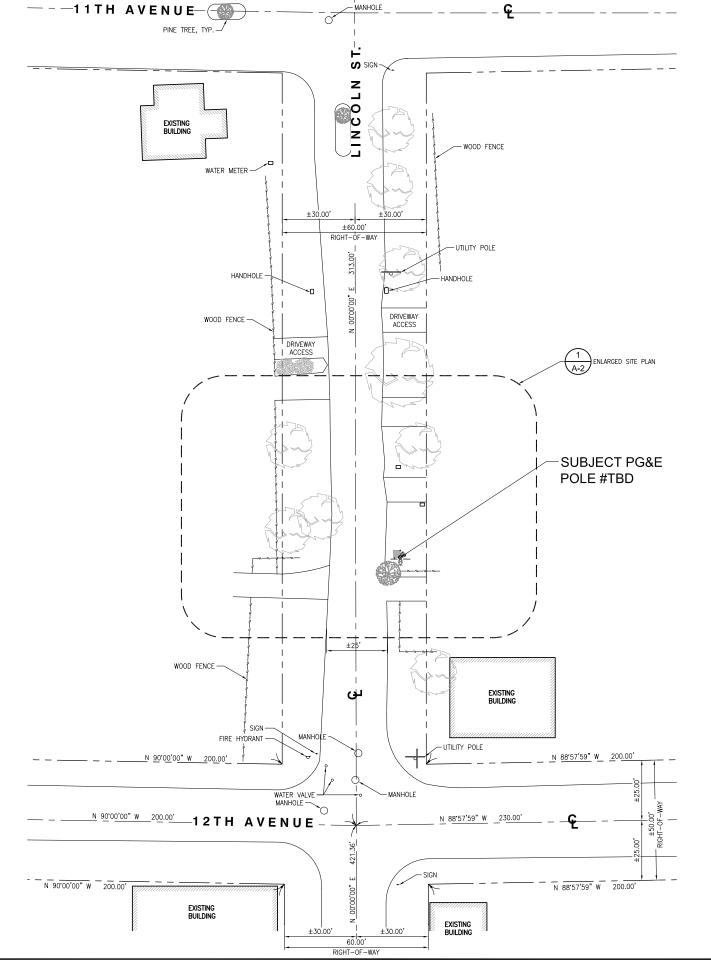







10650 SCRIPPS RANCH BLVD., SUITE 224 SAN DIEGO, CA 92131 tel: (858) 433-7173 / (858) 433-7176

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ı		С	05/17/2019	SETBACK ADDED
ı		В	03/08/2019	100% CD'S
ı		Α	02/01/2019	90% CD'S SET
ı		REV	DATE	DESCRIPTION

ISSUED DATE:

MAY 17, 2019

ISSUED FOR: -

100% CD SET

LICENSURE: 뮒 No. C 83930 , ★ \ Exp. 9 - 30 - 19

PROJECT INFORMATION:

SOUTH CARMEL 004 LOCATION CODE: 428219 IFO LINCOLN ST. 3NE 12TH AVE., CARMEL, CA 93923

DRAWN BY: CHECKED BY:

SHEET TITLE: -

SITE PLAN

SHEET-NUMBER

A-1


SITE PLAN


11"x17" SCALE: 1" = 40'-0"

24"x36" SCALE: 1" = 20'-0"

UNDERGROUND UTILITIES NOTE:

UNDERGROUND UTILITIES NOTE:
ALL EXISTING SUB-SURFACE UTILITIES, FACILITIES, CONDITIONS, AND THEIR
DIMENSIONS SHOWN ON THE PLAN HAVE BEEN PLOTTED FROM FIELD SURVEY
AND/OR AVAILABLE RECORDS, THE ARCHITECT/ ENGINEER AND THE OWNER
ASSUME NO RESPONSIBILITY WHATSOEVER AS TO THE SUFFICIENCY OR THE
ACCURACY OF THE INFORMATION SHOWN ON THE PLANS, OR THE MANNER OF
THEIR REMOVAL OR ADJUSTMENT. CONTRACTORS SHALL BE RESPONSIBLE FOR
THEIR DETERMINING EXACT LOCATION OF ALL EXISTING UTILITIES AND FACILITIES
PRIOR TO START OF CONSTRUCTION. CONTRACTORS SHALL ALSO DETAIN FROM
EACH UTILITY COMPANY DETAILED INFORMATION RELATIVE TO WORKING
SCHEDULES AND METHODS OF REMOVING OR ADJUSTING EXISTING UTILITIES.
THERE MAY BE EXISTING UTILITIES OFTHER THAN THOSE SHOWN ON THIS PLAN.
THE CONTRACTOR IS REQUIRED TO TAKE PRECAUTIONARY MEASURES TO
PROTECT THE UTILITY LINE SHOWN AND ANY OTHER LINES NOT SHOWN ON
THIS PLAN.

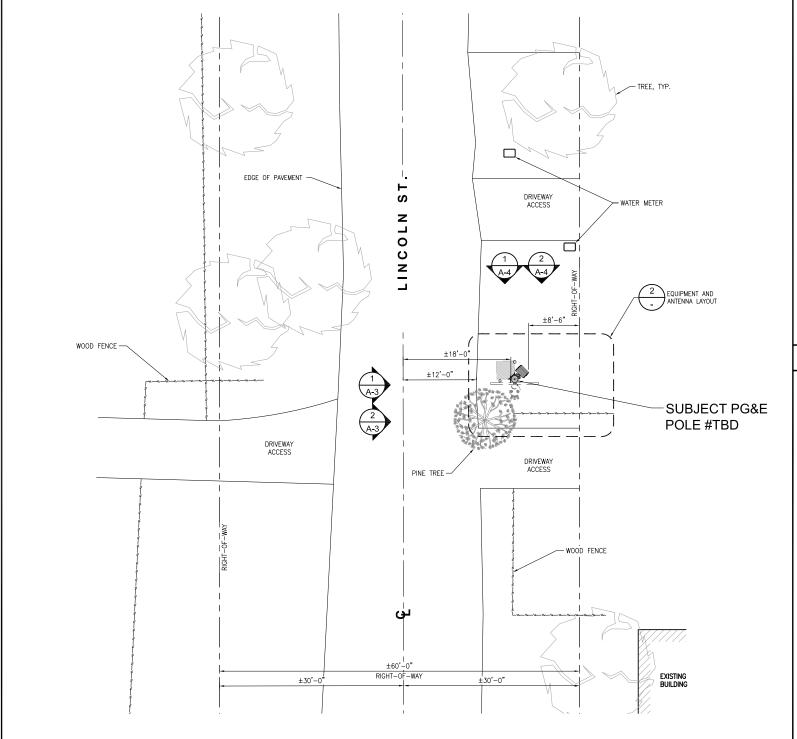

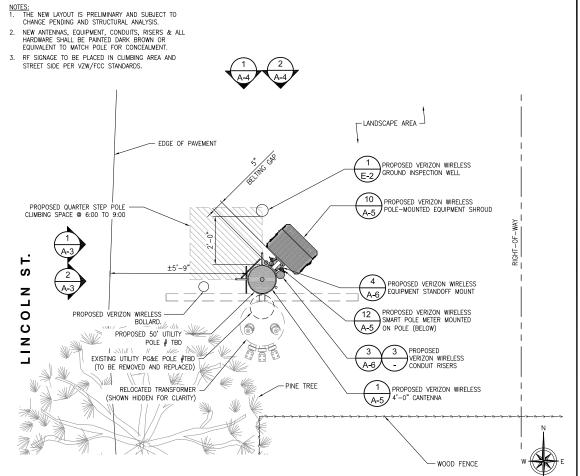

24"x36" SCALE: 1/2" = 1'-0" 11"x17" SCALE: 1/4" = 1'-0" **EQUIPMENT AND ANTENNA LAYOUT**

EXISTING POLE INFORMATION PROPOSED POLE INFORMATION

POLE HEIGHT: POLE HEIGHT: 40 FT 50 FT MATERIAL: MATERIAL: DF POLE TYPE: JOINT UTILITY POLE POLE CLASS: YEAR SET: 1966 POLE CLASS: TBD YEAR SET: TBD S MAKE-READY SCOPE: - FXISTING GROUND ON EXISTING UTILITY PG&E -HARDWOOD MOLDING VERIZON TO INSTALL (1) SMART POLE METER ON Z POLE #TRD TO BE (TO BE RELOCATED) REMOVED AND REPLACED VERIZON TO INSTALL (1) DISCONNECT SWITCH AND DISTRIBUTION PANEL ON STANDOFF MOUNT AT 10:30 0 POSITION.

3. VERIZON TO INSTALL (1) EQUIPMENT SHROUD ON STANDOFF MOUNT AT 10:30 POSITION. 4. VERIZON TO INSTALL (1) POLE TOP CANTENNA

MOUNTING BRACKET. 5. VERIZON TO INSTALL (1) 4FT CANTENNA ON TOP OF

VERIZON TO INSTALL 2" SCHEDULE 80 PVC POWER RISER AT 10:00 POSITION FROM SERVICE DROP TO METER. VERIZON TO INSTALL 4" SCHEDULE 80 PVC HYBRID RISER AT 11:30 POSITION FROM SHROUD TO

ANTENNA. 8. INSTALL 2" SCHEDULE 80 PVC FIBER RISER AT 9:30 POSITION FROM SERVICE DROP TO EQUIPMENT

9. VERIZON TO STEP POLE @ 6:00 TO 9:00

10. VERIZON TO PULL, TRANSPORT AND DISPOSE THE


EXISTING POLE S Z PROPOSED 36"x36" CLIMBING SPACE @ 6:00 TO 9:00 8 PROPOSED VERIZON WIRELESS POLE STEPS -(N) 2" SCH. 80 FIBER CONDUIT RISER TOWARDS FIBER PATCH PANEL ဟ ခွဲ (N) 2" SCH. 80 POWER Z CONDUIT RISER 0 S PROPOSED VERIZON WIRELESS RF SIGNAGE Z — (N) 4" SCH. 80 HYBRID CONDUIT RISER FROM RRUS TOWARDS ANTENNA PER VZW STANDARDS PROPOSED 50' CLASS TRD UTILITY POLE, # TBD - FXISTING GROUND ON EXISTING UTILITY POLE, #TBD (TO BE REMOVED AND REPLACED)

PROPOSED POLE







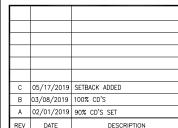

ISSUED DATE:

2

MAY 17, 2019

ISSUED FOR: •

100% CD SET

LICENSURE: 뮏 No. C 83930 (★) Exp. 9-30-19

PROJECT INFORMATION:

SOUTH CARMEL 004 LOCATION CODE: 428219 IFO LINCOLN ST. 3NE 12TH AVE., CARMEL, CA 93923

DRAWN BY: CHECKED BY:

ENLARGED SITE PLAN AND EQUIPMENT ANTENNA LAYOUT

SHEET-NUMBER


3



8' 6' 4' 2' 0"

24"x36" SCALE: 1/8" = 1'-0"


11"x17" SCALE: 1/16" = 1'-0"

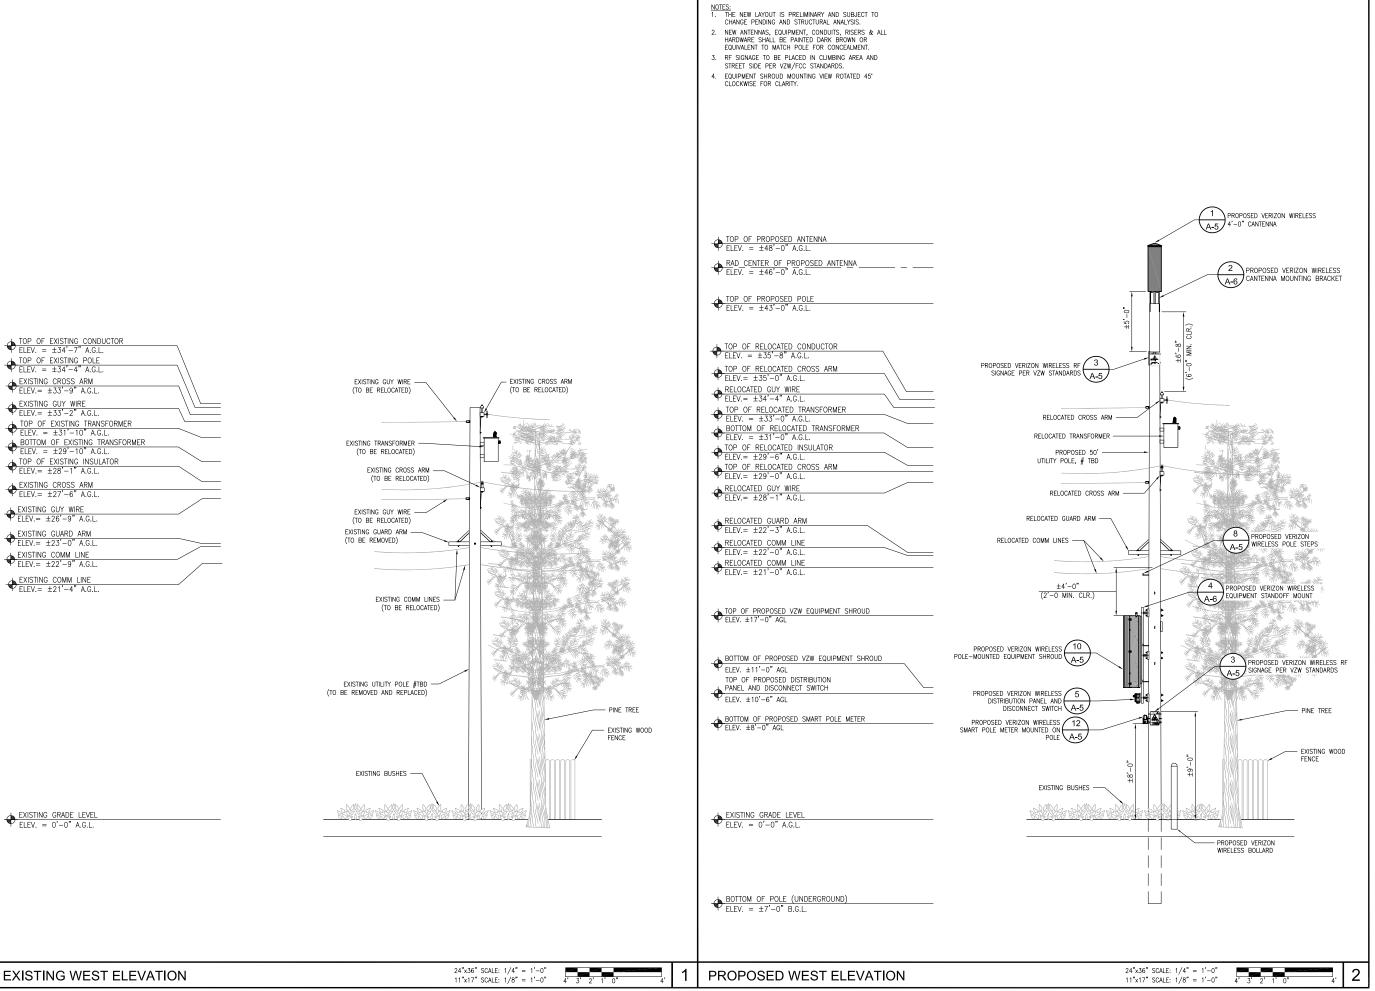







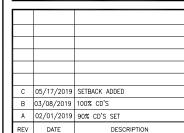

ISSUED DATE: -

MAY 17, 2019

ISSUED FOR: -

100% CD SET

No. C 83930 Exp. 9-30-19

PROJECT INFORMATION


SOUTH CARMEL 004 LOCATION CODE: 428219 IFO LINCOLN ST. 3NE 12TH AVE., CARMEL, CA 93923

DRAWN BY:	SAC
CHECKED BY:	RGG

SHEET-TITLE: -

ARCHITECTURAL ELEVATIONS

SHEET NUMBER: -

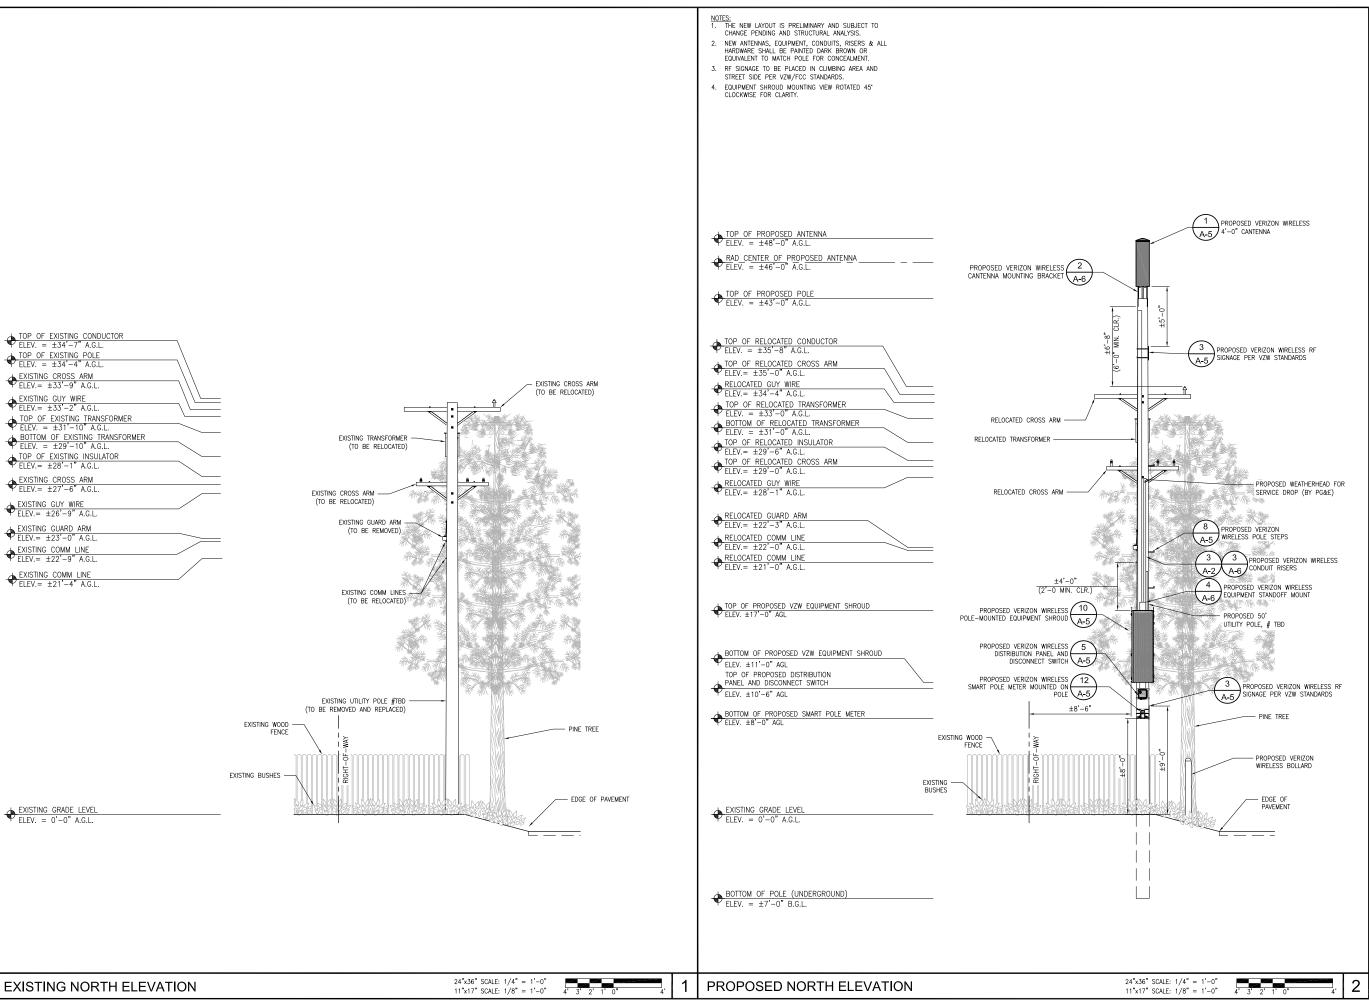







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	С	05/17/2019	SETBACK ADDED
	В	03/08/2019	100% CD'S
	Α	02/01/2019	90% CD'S SET
	REV	DATE	DESCRIPTION

ISSUED DATE: —

MAY 17, 2019

ISSUED FOR: -

100% CD SET

No. C 83930 Exp. 9-30-19

PROJECT INFORMATION


SOUTH CARMEL 004 LOCATION CODE: 428219 IFO LINCOLN ST. 3NE 12TH AVE., CARMEL, CA 93923

DRAWN BY:	SAC
CHECKED BY:	RGC

SHEET TITLE: •

ARCHITECTURAL ELEVATIONS

SHEET NUMBER: -

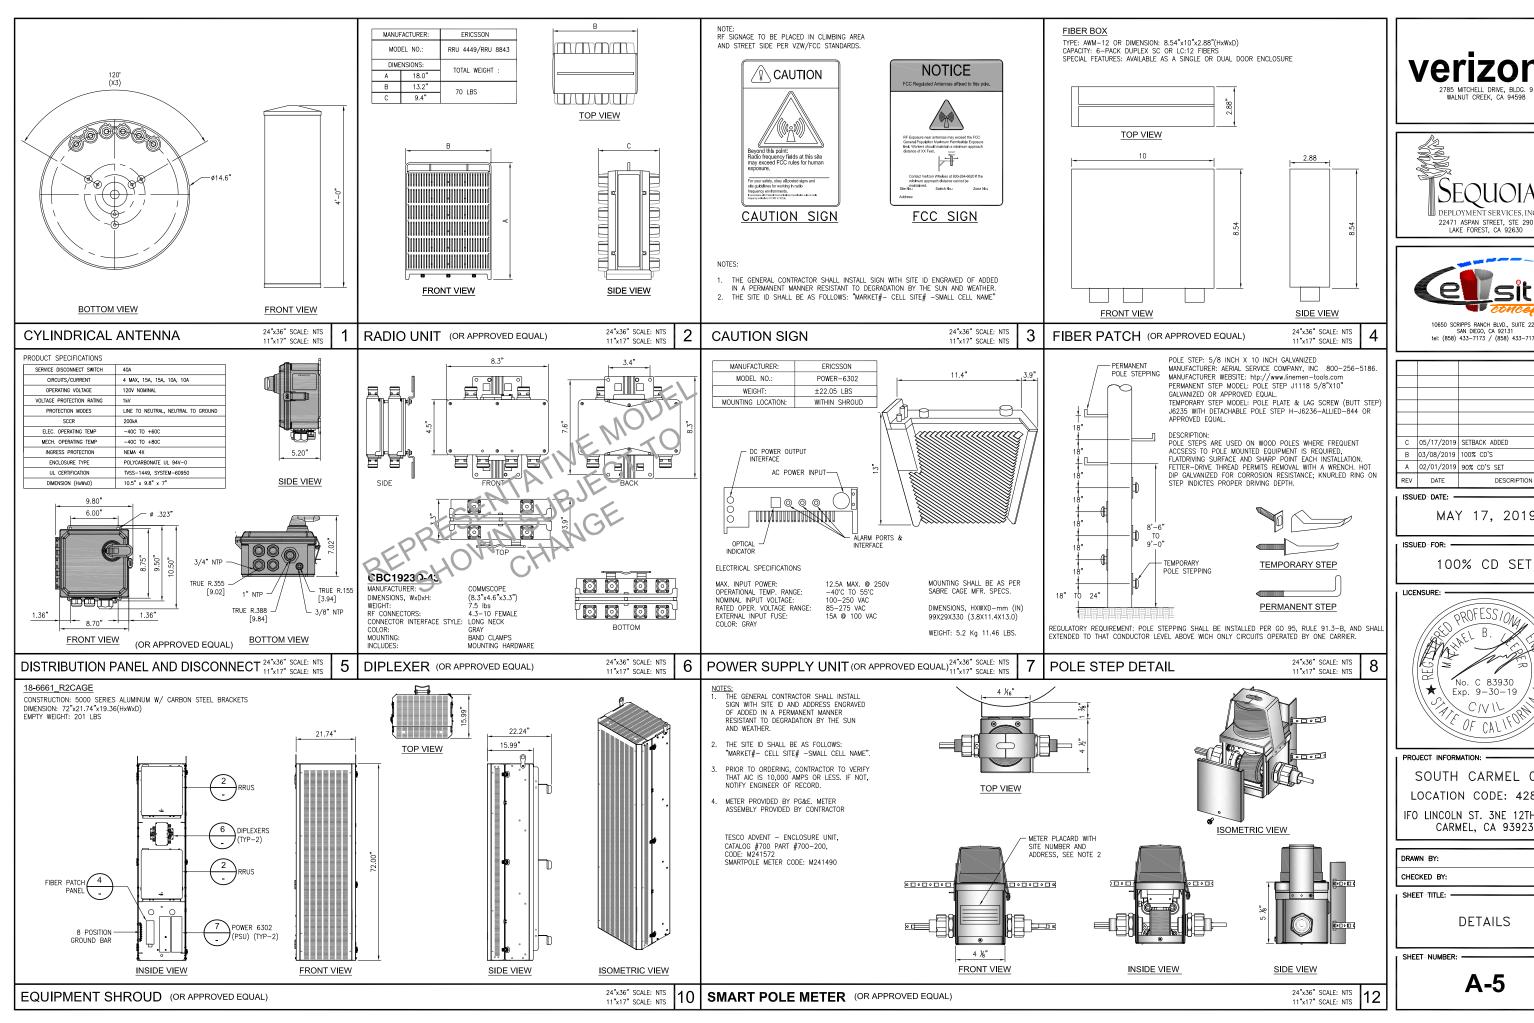







C 05/17/2019 SETBACK ADDED B 03/08/2019 100% CD'S A 02/01/2019 90% CD'S SET REV DATE DESCRIPTION

ISSUED DATE:

MAY 17, 2019

100% CD SET




SOUTH CARMEL 004 LOCATION CODE: 428219 IFO LINCOLN ST. 3NE 12TH AVE.,

DRAWN BY:	SAC
CHECKED BY:	RGG

DETAILS

SHEET NUMBER:

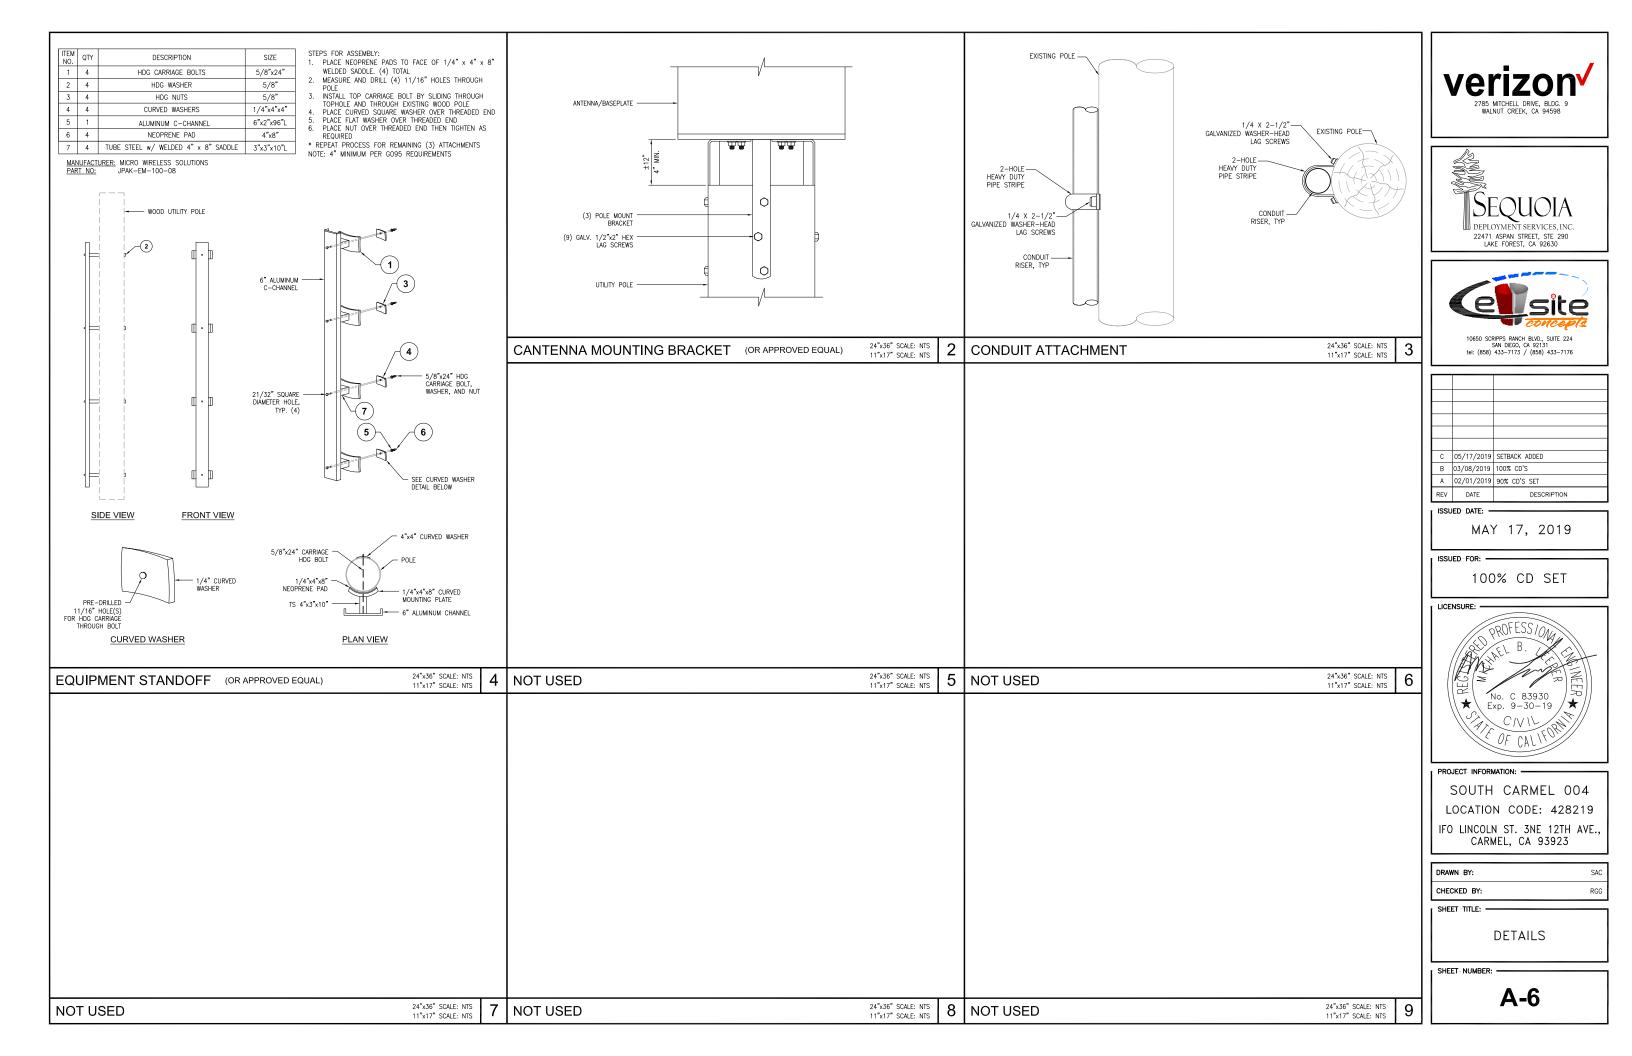

ELECTRICAL NOTES

- THIS INSTALLATION SHALL COMPLY WITH THE CURRENTLY ADOPTED EDITION OF THE CALIFORNIA ELECTRICAL CODE (CEC), WITH THE UTILITY COMPANY AND LOCAL CODE RECHIREMENTS
- POWER, CONTROL AND FOUIPMENT GROUND WIRING IN CONDUIT SHALL BE SINGLE CONDUCTOR (#12 AWG AND LARGER), 600V, OIL RESISTANT THHN OR THWN-2, CLASS B STRANDED COPPER CABLE RATED FOR 90°C (WET AND DRY) OPERATION; LISTED OR LABELED FOR THE LOCATION AND RACEWAY SYSTEM USED.
- CUT, COIL AND TAPE A 3 FOOT PIGTAIL FROM END OF LFMC FOR TERMINATING AT EQUIPMENT, IF REQUIRED.
- SUPPLEMENTAL EQUIPMENT GROUND WIRING LOCATED OUTDOORS OR BELOW GRADE SHALL BE SINGLE CONDUCTOR #2 AWG SOLID, TINNED, COPPER WIRE
- ALL POWER AND GROUNDING CONNECTIONS SHALL BE CRIMP STYLE, COMPRESSION, WIRE LUGS AND WIRENUTS BY THOMAS AND BETTS (OR EQUAL). LUGS AND WIRENUTS SHALL BE RATED FOR OPERATION AT NO LESS THAN 75°C.
- ALL ELECTRICAL COMPONENTS SHALL BE CLEARLY LABELED WITH ENGRAVED LAMINATED PLASTIC LABELS. ALL EQUIPMENT SHALL BE LABELED WITH THEIR VOLTAGE RATING, PHASE CONFIGURATION, WIRE CONFIGURATION, POWER OR AMPACITY RATING AND BRANCH CIRCUIT ID NUMBERS (PANELBOARD AND CIRCUIT IDENTIFICATION).
- 7. ALL CONDUIT RUN ABOVE GROUND OR EXPOSED SHALL BE RIGID STEEL.
- CABINETS, BOXES AND WIREWAYS SHALL BE LISTED OR LABELED FOR ELECTRICAL USE IN ACCORDANCE WITH NEMA, UL, ANSI/IEEE AND CEC.
- PROVIDE NECESSARY TAGGING ON THE BREAKERS CARLES AND DISTRIBUTION PANELS N ACCORDANCE WITH APPLICABLE CODES AND STANDARDS TO SAFEGUARD LIFE AND
- ALL ELECTRODE SYSTEMS (INCLUDING TELECOMMUNICATION, RADIO, LIGHTNING PROTECTION AND AC POWER) SHALL BE BONDED TOGETHER AT OR BELOW GRADE BY TWO OR MORE COPPER BONDING CONDUCTORS IN ACCORDANCE WITH THE CEC.
- PERFORM IFFE FALL-OF-POTENTIAL RESISTANCE TO FARTH TESTING (PER IFFE 1100 PERFORM IEEE FALL—OF—POTAINER RESISTANCE TO EARTH TESTING FER TEEE THOU AND 81) FOR NEW GROUND ELECTRODE SYSTEMS. THE CONTRACTOR SHALL FURNISH AND INSTALL SUPPLEMENTAL GROUND ELECTRODES AS NEEDED TO ACHIEVE A TEST RESULT OF 5 OHMS OR LESS.
- METAL RACEWAY SHALL NOT BE USED AS THE CEC REQUIRED EQUIPMENT GROUND CONDUCTOR. STRANDED COPPER CONDUCTORS WITH GREEN INSULATION SIZED IN ACCORDANCE WITH THE CEC SHALL BE FURNISHED AND INSTALLED WITH THE POWER CURPLIES TO CIRCUITS TO FQUIPMENT.
- 13. EXPOSED GROUND CONNECTIONS SHALL BE MADE WITH COMPRESSION CONNECTORS WHICH ARE THEN BOLTED TO EQUIPMENT USING STAINLESS STEEL HARDWARE. INSTALLATION TORQUE SHALL BE PER MANUFACTURER'S REQUIREMENTS.
- PROVIDE SUPPORTING DEVICES FOR ALL ELECTRICAL EQUIPMENT, FIXTURES, BOXES, PANEL, ETC., SUPPORT LUMINARIES FROM UNDERSIDE OF STRUCTURAL CEILING, EQUIPMENT SHALL BE BRACED TO WITHSTAND HORIZONTAL FORCES IN ACCORDANCE WITH STATE AND LOCAL CODE REQUIREMENTS. PROVIDE PRIOR ALIGNMENT AND LEVELING OF ALL DEVICES AND FIXTURES.

POLE CONSTRUCTION NOTES:

- METER SHALL NOT FACE THE STREET, ALLEY, OR PROPERTY SIDE OF THE POLE.
- METER BASE AND DISCONNECT SHALL BE BONDED TO A SEPARATE GROUND FROM THE POLE GROUND WITH CONDUCTOR HAVING A CURRENT CAPACITY THAN NO LESS THAN #6 SOLID COPPER CONDUCTOR.
- 3. EQUIPMENT CANNOT OVERHANG THE ROADWAY.
- 4. VERIFY AND RECORD ALL CHANGES AND FOOTAGES IN FIELD ON THE FINAL AS-BUILT DRAWINGS.
- 5. GROUNDS ARE TO BE TESTED: REQUIRES 5 OHMS OR LESS RESISTANCE.
- 6. ALL LANDSCAPING TO BE RESTORED TO ORIGINAL CONDITION. 7. NOTIFY PROPERTY OWNER BEFORE WORKING ON OR AROUND PRIVATE PROPERTY.
- 8. OBTAIN SPECIAL PERMITS AND PAY FEES AS REQUIRED WHEN WORKING ON CITY AND
- 9. MAINTAIN 36" MINIMUM COVER IN PARKWAY.
- 10. MAINTAIN 30" MINIMUM COVER BELOW GUTTER GRADE ON SURFACE STREETS.
- 11. CONDUITS MAY BE MOUNTED DIRECTLY TO THE POLE OR U-GUARD MAY BE USED IF THE POLE IS WITHIN 15" OF A BUCKET TRUCK ACCESSIBLE PAVED ROAD. IF NOT ACCESSIBLE AND THE CONDUIT IS GREATER THAN 1-1/2", THE CONDUIT IS OF BE MOUNTED WITH A STANDOFF BRACKET THAT PROVIDES 7" CLEARANCE FROM THE POLE TO THE CONDUIT.
- 12. CONTRACTOR TO PROVIDE MOUNTS OR ADDITIONAL HARDWARE IF REQUIRED FOR INSTALLATION OF PROPOSED ANTENNAS.

13. <u>CONDUIT REQUIREMENTS:</u>
UNDERGROUND — SCHEDULE 40 PVC OR BETTER
RISERS — SCHEDULE 80 PVC WITH FIRST 10' ABOVE GROUND LEVEL TO BE RGS FOR PROTECTION PURPOSES. ALL CONDUITS WILL BE MANDRELED AND EQUIPPED WITH 3/8" PULL ROPE AND MEASURE TAPE IF REQUIRED.

GROUNDING NOTES

- ALL DETAILS ARE SHOWN IN GENERAL TERMS. ACTUAL GROUNDING INSTALLATION REQUIREMENTS AND CONSTRUCTION SHALL BE ACCORDING TO SITE CONDITIONS.
- ALL GROUNDING CONDUCTORS: #2 AWG SOLID BARE TINNED COPPER WIRE UNLESS OTHERWISE NOTED.
- GROUND BAR LOCATED IN BASE OF FOUIPMENT WILL BE PROVIDED. FURNISHED AND INSTALLED BY THE VENDOR
- ALL BELOW GRADE CONNECTIONS: EXOTHERMIC WELD TYPE, ABOVE GRADE
- CONNECTIONS: MECHANICAL/ CONNECTIONS U.N.O. INSTALL GROUND CONDUCTORS AND GROUND ROD MINIMUM OF 1'-0" FROM EQUIPMENT CONCRETE SLAB, SPREAD FOOTING, OR FENCE.
- ALL GROUNDING INSTALLATIONS AND CONNECTIONS SHALL BE MADE BY ELECTRICAL
- ALL GROUNDING FOR ANTENNAS SHALL BE CONNECTED SO THAT IT WILL BY-PASS MAIN BUSS BAR.
- USE SEPARATE HOLES FOR GROUNDING AT BUSS BAR, NO "DOUBLE-UP" OR BACK TO BACK LUGS.
- NO LB'S ALLOWED ON GROUNDING.
- PROVIDE STAINLESS STEEL CLAMP AND BRASS TAGS ON ANY COAX AT ANTENNAS AND RADIOS.
- ALL ELECTRICAL AND GROUNDING AT THE CELL SITE SHALL COMPLY WITH THE CALIFORNIA ELECTRICAL CODE (CEC).
- EXOTHERMIC WELDING IS REQUIRED FOR GROUNDING BELOW GRADE CONNECTIONS
- MECHANICAL, ABOVE GRADE CONNECTIONS MAY BE MADE USING COMPRESSION TYPE-2 HOLES. LONG BARREL LUGS OR DOUBLE CRIMP CLAMP "C" CLAMP. THE COPPER CABLES SHALL BE COATED WITH ANTIOXIDANT (COPPER SHIELD) BEFORE MAKING THE CONNECTIONS. THE MANUFACTURER'S TORQUE RECOMMENDATIONS ON THE BOLT ASSEMBLY TO SECURE CONNECTIONS SHALL BE FOLLOWED. ALL TWO HOLE LONG BARREL LUGS SHALL HAVE VIEW PORTS TO ENSURE PROPER
- PROVIDE PVC SLEEVES FOR GROUNDING CONDUCTORS AS NEEDED.
- 15. GROUND ANTENNA BASES, FRAMES, CABLE RACKS AND OTHER METALLIC COMPONENTS WITH #2 GROUNDING CONDUCTORS AND CONNECT TO INSULATED SURFACE MOUNTED GROUND BARS. CONNECTION DETAILS SHALL FOLLOW MANUFACTURER'S SPECIFICATIONS FOR GROUNDING
- 16. PERFORM IEEE FALL-OF-POTENTIAL RESISTANCE TO EARTH TESTING (PER IEEE 1100 AND 81) FOR NEW GROUND ELECTRODE SYSTEMS. THE SUBCONTRACTOR SHALL FURNISH AND INSTALL SUPPLEMENTAL GROUND ELECTRODES AS NEEDED TO ACHIEVE A TEST RESULT OF 5 OHMS OR LESS.
- 17. SURFACES TO BE CONNECTED TO GROUND CONDUCTORS SHALL BE CLEANED TO A BRIGHT SURFACE AT ALL CONNECTIONS.

18 GROUND REQUIREMENTS:

GROUND REQUIREMENTS:
5/8" SS, COPPER CLAD GROUNDING ROD—10' LENGTH
GROUND TESTED AT 5 OHMS OR LESS
#2 GROUND WIRE, SOLID, TINNED

#2 GROUND MICLOING, STAPLED TO POLE EVERY 2'-0" AND AT EACH END GROUND RODS MUST BE 24" FROM POLE AND THE TOP OF ROD MUST BE BELOW GRADE LEVEL PER PLAN DETAILS.

M UTILITY METER

FUSE

CIRCUIT BREAKER

■ DUPLEX RECEPTACLE WITH GFCI

IN WEATHERPROOF ENCLOSURE

CLAMP OR DOUBLE HOLE LUG

TYPE GROUND CONNECTION

EXOTHERMIC CONNECTION TO

DISCONNECT SWITCH

LEGEND SYMBOLS:

GROUNDING WIRE, DASHED LINE

AC POWER LINE, DASHED

INDICATES UNDERGROUND DC POWER LINE, DASHED INDICATES UNDERGROUND

TELEPHONE LINE, DASHED LINE INDICATES UNDERGROUND

COAXIAL CABLE, DASHED LINE NDICATES UNDERGROUND

FIBER CABLE, DASHED LINE INDICATES UNDERGROUND

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DETAIL REFERENCE DETAIL NO. 2 ON SHEET E3

 \otimes GROUND ROD


 \boxtimes GROUND ROD WITH ACCESS

- . ALL CONDUIT ROUTING IS SCHEMATIC. CONTRACTOR SHALL INSTALL CONDUITS SO THAT ACCESS TO EQUIPMENT IS NOT IMPEDED.
- 2 CONDUIT SIZES INDICATED ON THE DRAWINGS ARE NOT NECESSARILY BASED ON THE MINIMUM CONDUIT SIZES INDICATED ON THE DRAWINGS ARE NOT NECESSARILE BASED ON THE MINIMUM SIZE ALLOWED BY THE CEC AND MAY BE PURPOSELY OVERSIZED FOR FUTURE CONDUCTORS OR TO AVOID CONDUCTOR HEATING. CONDUIT SIZES NOT CALLED OUT ON THE DRAWINGS SHALL BE SIZED BY THE CONTRACTOR, BASED ON THE ACTUAL NUMBER OF CONDUCTORS TO BE INSTALLED, USING THE CEC AS A GUIDE. IN NO CASE SHALL CONDUIT SIZES BE SMALLER THAN 1/2'
- 3. THE CONTRACTOR SHALL PROVIDE AND INSTALL ALL JUNCTION AND PULLBOXES REQUIRED FOR THE INSTALLATION OF ELECTRICAL DEVICES AND EQUIPMENT, WHETHER OR NOT SPECIFICALLY INDICATED ON THE PLANS. SIZING OF THESE BOXES SHALL BE PER THE CEC.
- ALL ELECTRICAL WORK SHALL BE CONSTRUCTED IN ACCORDANCE WITH PROJECT SPECIFICATIONS AND ALL APPLICABLE LOCAL CODES AND REGULATIONS.
- UTILITY ELECTRICAL SERVICE WILL BE 120/240 VOLTS OR 120/208 VOLTS, SINGLE PHASE, MIN. 30 AMPS CAPACITY. SEE PLANS FOR DETAILS.
- 6 PROJECT CONDITIONS MAY REQUIRE REARRANGEMENT OF ELECTRICAL WORK. THE SUBCONTRACTOR SHALL INDICATE SUCH CHANGES ON THE AS-BUILT DRAWINGS. WHERE CHANGES REQUIRE ALTERNATE METHODS TO THOSE SPECIFIED IN THE PLANS, THE SUBCONTRACTOR SHALL REQUEST APPROVAL. AND SHALL NOT PROCEED UNTIL APPROVAL IS OBTAINED.
- CONTRACTOR SHALL PAINT ALL EXPOSED EXTERIOR CONDUITS AND JUNCTION BOXES TO MATCH EXISTING FINISH ON WHICH THEY ARE ATTACHED.
- 8 FIRER TRUNKS AND/OR BACKHAUL LENGTHS AND ROLLTES ARE NOT VERIFIED DURING THE SITE WALK CONTRACTOR TO VERIFY ACTUAL ROUTE AND TRUNK LENGTH DURING PRE-CONSTRUCTION WALF
- O. CONTRACTOR SHALL COORDINATE WITH UTILITY COMPANY FOR FINAL AND EXACT WORK/MATERIALS REQUIREMENTS AND CONSTRUCT TO UTILITY ENGINEERING PLANS AND SPECIFICATIONS ONLY WHERE APPLICABLE PER PROJECT SCOPE OF WORK.
- 10. CONTRACTOR SHALL FURNISH AND INSTALL CONDUIT, PULL WIRES, CABLE PULL BOXES, CONCRETE ENCASEMENT OF CONDUIT, TRANSFORMER PAD, BARRIERS, POLE RISER TRENCHING, BACK FILL, AND UTILITY FEES, AND INCLUDE REQUIREMENTS IN SCOPE.
- 11. TEST ALL ELECTRICAL & GROUNDING SYSTEMS (CONTINUITY, MEGGER, ETC.) UPON COMPLETION OF INSTALLATION PRIOR TO FINALIZING WORK.
- CONTRACTOR TO VERIFY ALL CONDUIT ROUTING FOR, (N) VZW METER AND (N) GROUND ROD LOCATION WITH LANDLORD AND UTILITY COORDINATOR IN FIELD.
- 13. CONDUIT REQUIREMENTS (TYP., U.N.O.): UNDERGROUND: PVC (SCHED. 40 OR 80). INDOOR: EMT (RGS TRAFFIC AREAS). OUTDOOR: (ABOVE GRADE) RGS.
- 14. PROVIDE A MIN. 36" WORK CLEARANCE IN FRONT OF PANELS/ ELECTRICAL EQUIPMENT.

BREAKER LEGEND				
CIRCUIT #	DESCRIPTION	ACB /	#POLES	
1	PSU #1	15A 1P	10A 2P	
2	PSU #2	15A 1P	10A 2P	
3 SPARE		10A 1P	-	
3 SPARE		TOATE	-	
4 SPARE		10A 1P	-	
		104 11		

SINGLE LINE DIAGRAM

NOT USED

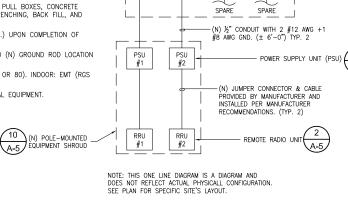

PG&E POWER SOURCE 120 VAC, 1PHASE 40 AMPS MIN. (FROM PG&E SERVICE DROP ON POLE)

DISCONNECT

10A 1P

PG&E REQUIREMENTS FOR

(N) SMART POLE WATTHOUR (SMART POLE METER), 3-WIRE 1-PHASE 120/240v 12

60 AMP CT METER WITH POLE MOUNT

MANUFACTURER RECOMMENDATIONS ON

(N) DISTRIBUTION PANEL WITH, TVSS, DISCONNECT, NEMA 4X, 40 AMPS MAX.

NEW LOAD:

NET TOTAL

INITIAL SITE VISIT.

TD-027911B-002

LOAD:

LOAD CALCULATIONS - VERIZON WIRELESS

POWER AND TELCO DESIGN IS BASED ON

CONTRACTOR SHALL OBTAIN CURRENT

UTILITY COORDINATOR PLANS PRIOR TO

START OF CONSTRUCTION AND CONFORM THE CURRENT VERSION OF PG&E BULLETIN

AVAILABLE FAULT CURRENT PER LITHITY

24"x36" SCALE: NTS

11"x17" SCALE: NTS

24"x36" SCALE: NTS

11"x17" SCALE: NTS

2

0 AMPS 25.0 AMPS MAX.

25.0 AMPS MAX.

A-5

ASSEMBLY GROUND METER PER

METER ASSEMBLY GROUND LUG.

(N) OVER HEAD SERVICE







С	05/17/2019	SETBACK ADDED	
В	03/08/2019	100% CD'S	
A	02/01/2019	90% CD'S SET	
REV	DATE	DESCRIPTION	
1001	IOCUED DATE		

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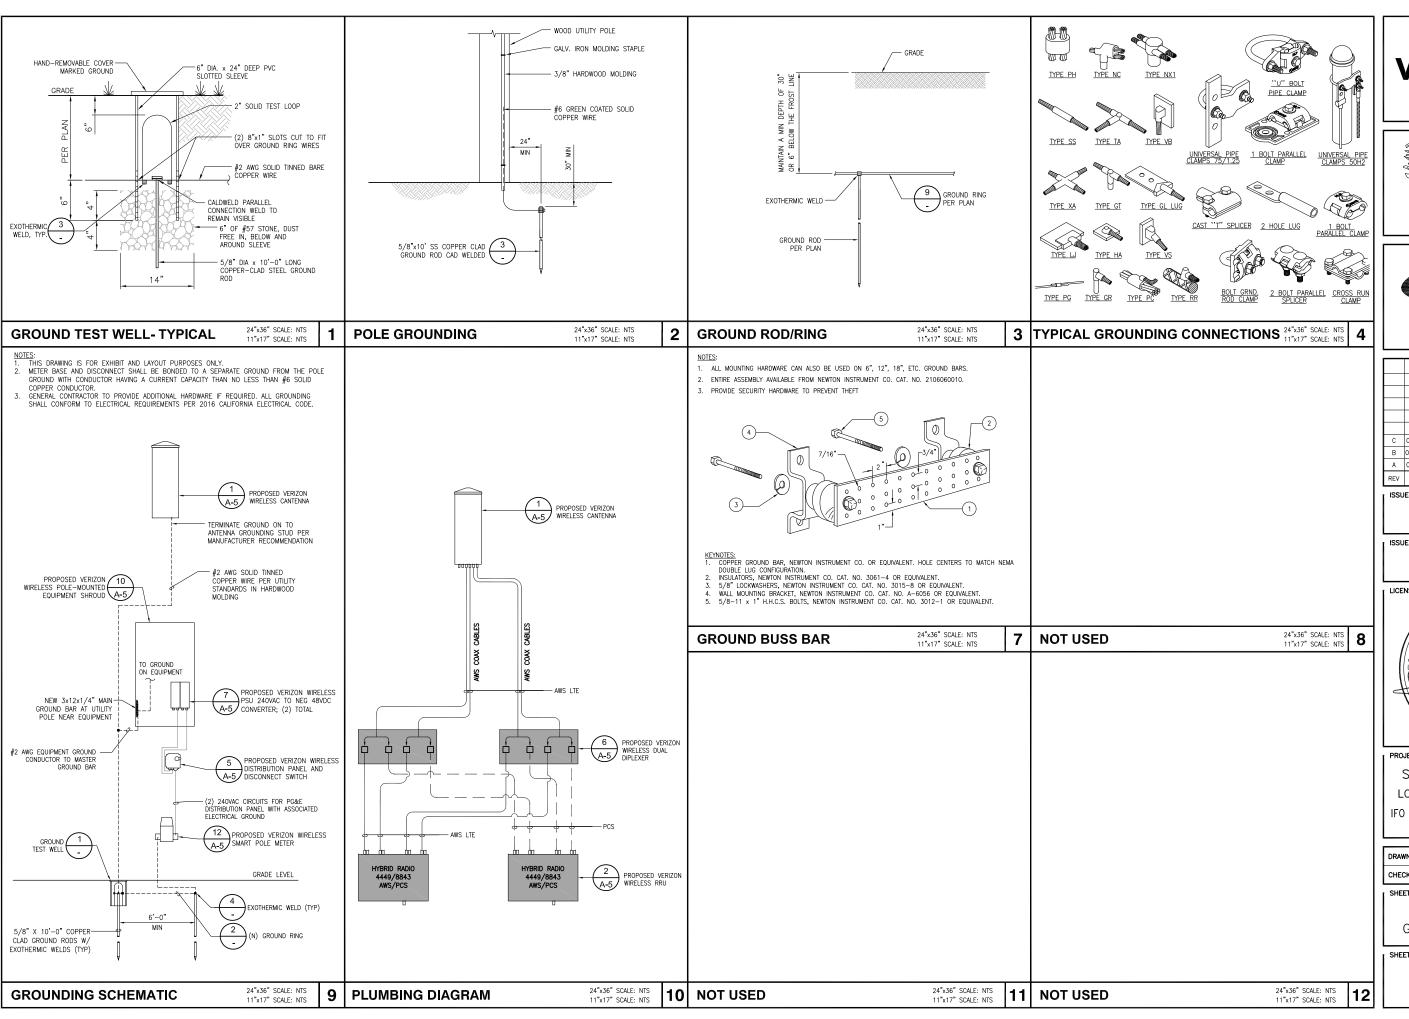
SOUTH CARMEL 004 LOCATION CODE: 428219 IFO LINCOLN ST. 3NE 12TH AVE. CARMEL, CA 93923

DRAWN BY: SAC

SHEET-TITLE: ELECTRICAL NOTES, SINGLE LINE DIAGRAM & PG&E DESIGN

SHEET-NUMBER

E-1









10650 SCRIPPS RANCH BLVD., SUITE 224 SAN DIEGO, CA 92131 tel: (858) 433-7173 / (858) 433-7176


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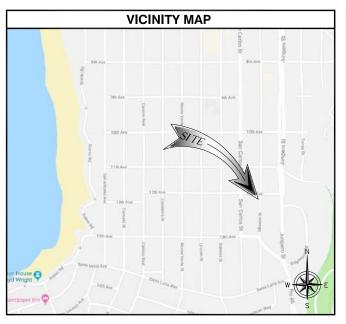
CARMEL, CA 93923

SHEET TITLE: -

ELECTRICAL AND GROUNDING DETAILS

SHEET-NUMBER:

E-2

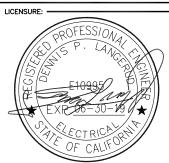

SITE INFORMATION

PACIFIC GAS & ELECTRIC 245 MARKET ST., MAIL CODE N10D SAN FRANCISCO, CA 94105 CONTACT: DAVID 7FNNFR PH: (415) 847-0283

APPLICANT:

VERIZON WIRELESS 2785 MITCHELL DRIVE, BLDG. 9 WALNUT CREEK, CA 94598

36' 32' 51.48" N

121' 55' 15.57" W

157.22' AMSL

LATITUDE (NAD 83): LONGITUDE (NAD 83): GROUND ELEVATION

CITY OF CARMEL BY THE SEA ZONING JURISDICTION PROPOSED USE UNMANNED TELECOMMUNICATIONS FACILITY

PROJECT TEAM

TRAFFIC CONTROL NOTE

PRIOR TO STARTING WORK, AND A MINIMUM OF FIVE (5) DAYS IF WORK WILL AFFECT A BUS STOP OR AN EXISTING TRAFFIC SIGNAL, OR IF WORK WILL REQUIRE A ROAD OR ALLEY CLOSURE.

APPLICANT: VERIZON WIRELESS 2785 MITCHELL DRIVE, BLDG. 9 WALNUT CREEK, CA 94598 CONTACT: MICHELLE MARTINEA PHONE: (925) 588-9840 EMAIL: michelle.martinea@verizonwireless.com

RF ENGINEER:
VERIZON WIRELESS
2785 MITCHELL DRIVE, BLDG. 9
WALNUT CREEK, CA 94598
CONTACT: DEWAYNE BONHAM

PHONE: (510) 414-8896

ARCHITECT/ENGINEERING: CELLSITE CONCEPTS 10650 SCRIPPS RANCH BLVD., SUITE 224 SAN DIEGO, CA 92131 CONTACT: REGGIE GABRIEI PHONE: (619) 200-7190 EMAIL: reggie.gabriel@cellsite.net

<u>SITE ACQUISITION:</u> SEQUOIA DEPLOYMENT SERVICES, INC. 22471 ASPAN ST., SUITE #290 LAKE FOREST, CA 92630 CONTACT: CHELSEA MANUTO

PHONE: (760) 445-1985 EMAIL: chelsea.manuto@seauoia-ds.con CONSTRUCTION: SEQUOIA DEPLOYMENT SERVICES, INC. 22471 ASPAN ST., SUITE #290 LAKE FOREST, CA 92630 CONTACT: PETE SHUBIN

PHONE: (714) 478-3197 EMAIL: pete.shubin@sequoia-ds.com

ZONING: SEQUOIA DEPLOYMENT SERVICES, INC. 22471 ASPAN ST., SUITE #290 LAKE FOREST, CA 92630 CONTACT: MICHAEL NAZAROFF PHONE: (562) 237-6380
EMAIL: michael.nazaroff@sequoia-ds.com



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PROJECT DESCRIPTION

THE PROJECT CONSISTS OF INSTALLATIONS OF TELECOMMUNICATIONS EQUIPMENT FOR VERIZON WIRELESS TO COLLOCATE ON NEW PG&E POLE. THE INSTALLATIONS ENTAILS:

- REMOVE EXISTING 40' POLE IN RIGHT OF WAY
-) PROPOSED 50"-0" CLASS 3 WOOD POLE IN RIGHT OF WAY
) PROPOSED VERIZON WIRELESS 4'-0" HIGH CANTENNA ON POLE
- INSTALL (1)
- PROPOSED VERIZON WIRELESS CANTENNA MOUNTING BRACKET PROPOSED VERIZON WIRELESS EQUIPMENT STANDOFF
- PROPOSED VERIZON WIRELESS EQUIPMENT SHROUD WITH REMOTE RADIO UNITS (RRU), INSTALL (1
- DIPLEXER(S), PSU(S) AND FIBER DEMARC.
 INSTALL (1) PROPOSED VERIZON WIRELESS SMART POLE METER
- (1) PROPOSED VERIZON WIRELESS DISTRIBUTION PANEL AND DISCONNECT SWITCH

APPLICABLE CODES

NL WORK AND MATERIALS SHALL BE PERFORMED AND INSTALLED IN ACCORDANCE WITH THE CURRENT EDITIONS OF THE FOLLOWING CODES AS ADOPTED BY THE LOCAL GOVERNING AUTHORITIES THE CONTRACTOR SHALL SUBMIT A TRAFFIC CONTROL PLAN (11"X17") FOR APPROVAL PRIOR TO STARTING WORK. THE PLAN SHOULD BE SUBMITTED TO THE TRAFFIC CONTROL PERMIT COUNTER. CONTRACTOR SHALL OBTAIN A TRAFFIC CONTROL PERMIT A MINIMUM OF TWO (2) WORKING DAYS CALIFORNIA ADMINISTRATIVE CODE (INCL TITLE 24 & 25)
2016 CALIFORNIA BUILDING CODE
LOCAL BUILDING CODE

- CITY/COUNTY ORDINANCES

- ANSI/EIA-222-G LIFE SAFETY CODE NFPA-101
 2016 CALIFORNIA ELECTRICAL CODE
 CA PUBLIC UTILITIES COMMISSION ORDER (GO 95 AND GO 128)

Verizon

PROJECT TYPE: POLYGON **SOUTH CARMEL 005**

IFO MISSION ST. 2 SW 12TH AVE., CARMEL, CA 93923

LOCATION CODE: 428220

SITE: (PG&E POLE # 25958)

GENERAL NOTES

- LOCATIONS OF UNDERGROUND UTILITIES SHOWN ON THE DRAWINGS WERE OBTAINED BY A SEARCH OF AVAILABLE RECORDS. NEITHER THE OWNER NOR THE ENGINEER ASSUMES ANY RESPONSIBILITY FOR UTILITIES OR STRUCTURES NOT SHOWN OR NOT IN THE LOCATION SHOWN ON THE DRAWINGS.
- THE CONTRACTORS SHALL INSTALL ALL EQUIPMENT AND MATERIALS IN ACCORDANCE WITH MANUFACTURER'S RECOMMENDATIONS UNLESS SPECIFICALLY INDICATED OTHERWISE, OR WHERE LOCAL CODES OR REGULATIONS TAKE PRECEDENCE.
- APPROVAL OF THESE PLANS BY THE CITY ENGINEER DOES NOT AUTHORIZE ANY WORK TO BE PERFORMED UNTIL A PERMIT HAS BEEN ISSUED.
- UPON ISSUANCE OF A PERMIT, NO WORK WILL BE PERMITTED ON WEEKENDS OR HOLIDAYS WITHOUT PERMISSION FROM THE ENGINEERING DEPARTMENT
- THE CONTRACTOR SHALL TAKE ALL PRECAUTIONARY MEASURES THE CONTRACTOR STALL TAKE ALL PRECAUTIONARY MEASURES INCESSARY TO PROTECT FROM DAMAGING EXISTING IMPROVEMENTS WHICH ARE TO REMAIN IN PLACE. CONTRACTOR SHALL, AT HIS OWN EXPENSE, REPAIR, REPLACE OR RECONSTRUCT ALL SUCH IMPROVEMENTS OR OTHER STRUCTURES DAMAGED BY HIS WORK, TO THE ENGINEER'S SATISFACTION.
- THE CONTRACTOR SHALL BE RESPONSIBLE FOR SURVEY MONUMENTS AND/OR VERTICAL CONTROL BENCHMARKS WHICH ARE DISTURBED OR DESTROYED BY CONSTRUCTION. A LAND SURVEYOR MUST FILED LOCATE, REFERENCE, AND/OR PRESERVE ALL HISTORICAL OR CONTROLLING MONUMENTS PRIOR TO ANY EARTHWORK, IP DESTROYED, SUCH MONUMENTS BY A LAND SURVEYOR REPLACED WITH APPROPRIATE MONUMENTS BY A LAND SURVEYOR A CORNER RECORD OF SURVEY, AS APPROPRIATE, SHALL BE FIELD AS REQUIRED BY THE PROFESSIONAL LAND SURVEYORS ACT. IF ANY VERTICAL CONTROL IS TO BE DISTURBED OR DESTROYED, THE JURISDICTION'S FIELD SURVEY DIVISION MUST BE NOTIFIED, IN WRITING, AT LEAST 3 DAYS FROM OCCURRENCE. THE CONTRACTOR WILL BE RESPONSIBLE FOR THE COST OF REPLACING ANY VERTICAL CONTROL BENCHMARKS DESTROYED BY THE CONSTRUCTION
- CONTRACTOR SHALL BE RESPONSIBLE FOR THE POTHOLE AND LOCATING OF ALL EXISTING UTILITIES THAT CROSS THE PROPOSITENCH LINE AND MUST MAINTAIN 1 FOOT MINIMUM VERTICAL
- DO NOT EXCAVATE OR DISTURB BEYOND THE PROPERTY LINES OR LEASE LINES, UNLESS OTHERWISE NOTED.
- CONTRACTOR SHALL REPLACE OR REPAIR ALL TRAFFIC SIGNAL

- 10. CONTRACTOR SHALL NOTIFY THE JURISDICTION A MINIMUM OF 48 HOURS PRIOR TO COMMENCING WORK WITHIN 10 FEET OF ALL SEWER, WATER, AND STORM DRAIN MAIN
- 11 "PUBLIC IMPROVEMENT SUBJECT TO DESUETUDE OR DAMAGE." IF REPAIR OR REPLACEMENT OF SUCH PUBLIC IMPROVEMENTS IS REQUIRED, THE OWNER SHALL OBTAIN THE REQUIRED PERMITS FOR WORK IN PUBLIC RIGHT-OF-WAY, SATISFACTORY TO THE PERMIT-ISSUING AUTHORITY.
- 12. THE CONTRACTOR SHALL MAKE ARRANGEMENTS FOR A PRE-CONSTRUCTION MEETING WITH THE CITY FIELD ENGINEERING DIVISION PRIOR TO ANY DISTURBANCE TO THE SITE, EXCLUDING UTILITY MARK-OUTS AND SURVEYING.
- 13. MANHOLES OR COVERS SHALL BE LABELLED "NAME OF COMPANY"
- 14. CONTRACTOR SHALL IMPLEMENT AN EROSION AND SEDIMENT CONTROL PROGRAM DURING THE PROJECT CONSTRUCTION ACTIVITIES. THE PROGRAM SHALL MEET THE APPLICABLE REQUIREMENTS OF THE STATE WATER RESOURCE CONTROL
- 15. THE CONTRACTOR SHALL HAVE EMERGENCY MATERIALS AND EQUIPMENT ON HAND FOR UNFORESEEN STIUATIONS, SUCH AS DAMAGE TO UNDERGROUND WATER, SEWER, AND STORM DRAIN FACILITIES WHEREBY FLOWS MAY GENERATE EROSION AND SEDIMENT POLLUTION.
- 16. THE CONTRACTOR SHALL VERIEY LOCATION ALL EXISTING UNDERGROUND UTILITIES INCLUDING SEWER LATERALS & WATER SERVICES TO INDIVIDUAL LOTS OF BOTH VERTICAL AND HORIZONTAL PRIOR TO COMMENCING IMPROVEMENTS OPERATIONS.
- LOCATION AND ELEVATIONS OF IMPROVEMENTS, TO BE MET BY WORK, SHALL BE CONFIRMED BY FIELD MEASUREMENTS PRIOF TO CONSTRUCTION OF NEW WORK
- 18 GRADES SHOWN ARE FINISH GRADES, CONTRACTOR SHALL DETERMINE NECESSARY SUB GRADE ELEVATIONS AND SHALL CONSTRUCT SMOOTH TRANSITION BETWEEN FINISH GRADES 19. THE CONTRACTOR SHALL SUBMIT WORK PLANS FOR ALL BORE
- OPERATIONS TWO WEEKS PRIOR TO COMMENCING WORK
- 20. THE CONTRACTOR SHALL BE TOTALLY RESPONSIBLE FOR COMPLIANCE WITH THE PROVISIONS OF THE STATE OF

- 21. CONTRACTOR AGREES THAT HE SHALL ASSUME SOLE
 RESPONSIBILITY FOR JOB SITE CONDITION DURING THE COURSE
 OF CONSTRUCTION OF THIS PROJECT, INCLUDING SAFETY OF ALL
 PERSONS AND PROPERTY; THAT THIS EQUIPMENT SHALL APPLY PERSONS AND PROPERTY; THAT HIS EQUIPMENT SHALL APPLY CONTINUOUSLY AND NOT BE LIMITED TO NORMAL WORKING HOURS; AND THAT THE CONTRACTOR SHALL DEFEND, INDEMNIFY AND HOLD THE OWNER AND THE ENGINEER HARMLESS FROM AND AND ALL LUABILITY, REAL OR ALLEGED IN CONNECTION WITH THE PERFORMANCE OF WORK ON THIS PROJECT, EXCEPTING FOR LIABILITY ARISING FROM SOLE NEGLIGENCE OF THE OWNER OR THE PROJECT, EXCEPTING FOR THE ENGINEER.
- 22. THE LOCATIONS OF ALL EXISTING UTILITIES SHOWN ON THESE THE LOCATIONS OF ALL EXISTING UTILITIES SHOWN ON THESE PLANS ARE FROM EXISTING RECORDS AND CORROBORATED, WHERE POSSIBLE WITH FIELD TIES. THE CONTRACTOR IS RESPONSIBLE FOR CONFIRMING THE LOCATIONS SHOWN, BOTH HORIZONTALLY AND VERTICALLY PRIOR TO CONSTRUCTION. IF EXISTING LOCATIONS VARY SUBSTANTIALLY FROM THE PLANS, THE ENGINEER SHOULD BE NOTIFIED TO MAKE ANY CONSTRUCTION CHANGES REQUIRED.
- AS-BUILT DRAWINGS MUST BE SUBMITTED TO THE CITY ENGINEER PRIOR TO ACCEPTANCE OF THIS PROJECT.
- 24. ALL NEW AND EXISTING UTILITY STRUCTURES ON SITE AND IN AREAS TO BE DISTURBED BY CONSTRUCTION SHALL BE ADJUSTED TO FINISH ELEVATIONS PRIOR TO FINAL INSPECTION OF WORK.
- 25. ANY DRAIN AND/OR FIELD TILE ENCOUNTERED/DISTURBED DURING CONSTRUCTION SHALL BE RETURNED TO IT'S ORIGINAL CONDITION PRIOR TO COMPLETION OF WORK, SIZE, LOCATION AND TYPE OF ANY UNDERGROUND UTILITIES OR IMPROVEMENTS SHALL BE ACCURATELY NOTED AND PLACED ON "AS-BUILT" DRAWINGS BY GENERAL CONTRACTOR, AND ISSUED TO THE ARCHITECT OR ENGINEER AT COMPLETION OF PROJECT.
- 26. ALL TEMPORARY EXCAVATIONS FOR THE INSTALLATION OF FOUNDATIONS, UTILITIES, ETC., SHALL BE PROPERLY LAID BACK OR BRACED IN ACCORDANCE WITH THE CORRECT OCCUPATIONAL SAFETY AND HEALTH ADMINISTRATION (OSHA) REQUIREMENTS.







SAN DIEGO, CA 92131 tel: (858) 433-7173 / (858) 433-7176

С	05/17/2019	SETBACK ADDED
В	03/08/2019	100% CD'S
Α	02/01/2019	90% CD'S SET
REV	DATE	DESCRIPTION

MAY 17, 2019

100% CD SET

LICENSURE:



SOUTH CARMEL 005 LOCATION CODE: 428220

IFO MISSION ST. 2 SW 12TH AVE. CARMEL, CA 93923

TITLE SHEET

T-1

ACCESSIBILITY NOTE

THE FACILITY IS UNMANNED AND NOT FOR HUMAN HABITATION. HANDICAPPED ACCESS
REQUIREMENTS ARE NOT REQUIRED IN ACCORDANCE WITH THE 2016 CALIFORNIA BUILDING CODE. A
FORMINGAN WILL WIST THE SITE AS REQUIRED FOR ROUTINE MAINTENANCE. THE PROJECT WILL NOT
RESULT IN ANY SIGNIFICANT DISTURBANCE OR EFFECT ON DRAINAGE; NO SANTIARY SEWER SERVICE,
POTABLE WATER, OR TRASH DISPOSAL IS REQUIRED AND NO COMMERCIAL SIGNAGE IS NEW.

THE TELECOMMUNICATIONS EQUIPMENT SPACE SHOWN ON THESE PLANS IS NOT CUSTOMARILY OCCUPIED. WORK TO BE PERFORMED IN THIS FACILITY CANNOT REASONABLY BE PERFORMED BY PERSONS WITH A SEVERE IMPAIRMENT: MOBILITY, SIGHT, AND/OR HEARING. THEREFORE, PER 2016 CALIFORNIA BUILDING CODE SECTION 1105B.3.4, AND/OR 11B-203.5 OF 2016 CALIFORNIA BUILDING CODE, EXCEPTION 1, THIS FACILITY SHALL BE EXEMPTED FROM ALL TITLE 24 ACCESS

DO NOT SCALE **DRAWINGS** SUBCONTRACTOR SHALL VERIEY ALL PLANS

WORK OR BE RESPONSIBLE FOR SAME. IF USING 11"X17" PLOT, DRAWINGS WILL BE HALF SCALE.



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ABBREVIATIONS

AB AC A/C ADJ A.F.F. ARCH	ANCHOR BOLT ASPHALTIC CONCRETE AIR CONDITIONING ADJUSTABLE ABOVE FINISH FLOOR ARCHITECTURAL APPROXIMATELY	JT LAM LBS LT LA LNA	JOINT LAMINATED POUNDS LIGHT LIGHTNING ARRESTOR LOW NOISE AMPLIFIER
	ABOVE GRADE LEVEL ABOVE MEAN SEA LEVEL	MFR MAT MAX	MANUFACTURER MATERIAL MAXIMUM
BD BLDG BLKG BOT BSMT BTS	BOARD BUILDING BLOCKING BOTTOM BASEMENT BASE TRANSCEIVER STATION	MECH MIN MISC ML MO MS MTD MTL	MECHANICAL MINIMUM MISCELLANEOUS METAL LATH MASONRY OPENING MACHINE SCREW MOUNTED METAL
C CEM CL CLG CLR COL	COURSE(S) CEMENT CHAIN LINK CEILING CLEAR COLUMN	(N) NIC NO NTS	NEW NOT IN CONTRACT NUMBER NOT TO SCALE
CONC CONST CONT CORR CO	COLOMN CONCRETE CONSTRUCTION CONTINUOUS CORRIDOR CONDUIT ONLY	OA O.C. OPNG OPP	OVERALL ON CENTER OPENING OPPOSITE
00	CONDON ONLY	DARTN	DARTITION

DEMOLITION DIMENSION

EXISTING

EVATION OUIPMENT

FACE OF STUDS FINISH SURFACE FOOT, FEET

FINISH WALL FINISH GRADE FUTURE

HIGH VOLTAGE

DTL DWG

GA GALV

GYP GFCI

GND


HSS

HT HV

- NUMBER NOT TO SCALE
- PARTN PARTITION PL PLAS PLYWD POC PROP PT PLATE
 PLAYWOOD
 POINT OF CONNECTION
 PROPERTY
 PRESSURE TREATED R REQD RD RM RMS RO RISER REQUIRED ROOF DRAIN

- ROOMS ROUGH OPENING
- SOLID CORE SCHEDULE SECTION SHEET SIMILAR SPECIFICATIONS STAINLESS STEEL STEFI SC SCHED SECT SHT SIM SPECS
- STL STOR STRUCT SUSP SW SWBO STRUCTURAL SUSPENDED SWITCH SWITCHBOARD THK TI
- THICK
 TENANT IMPROVEMENT
 TOWER MOUNTED AMPLIFIER
 TOP OF SURFACE
 TUBE STEEL
 TYPICAL UNO
- GAUGE GALVANIZED GLASS UNLESS NOTED OTHERWISE VCT VERT V.I.F. VG VINYL COMPOSITION TILE VERTICAL GROUND FAULT CIRCUIT
- VERIFY IN FIELD VERTICAL GRAIN GROLIND
- HOLLOW CORE
 HARDWARE
 HEATER
 HOLLOW METAL
 HORIZONTAL
 HOUR
 HOULOW STRUCTURAL
 SECTION
 HEIGHT WOOD WATER RESISTANT WEIGHT XFMR TRANSFORMER
- @ ΑT CHANNEL CENTERLINE INSIDE DIMENSION INSULATION INTERIOR
 - ANGLE PROPERTY LINE

SYMBOLS:

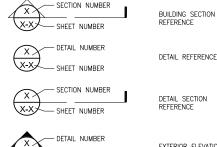

X-X SHEET NUMBER	DETAIL SECTION REFERENCE
X DETAIL NUMBER X-X SHEET NUMBER	EXTERIOR ELEVATION REFERENCE
	PROPERTY LINE
xxx	FENCING
——E——E——	ELECTRICAL SERVICE
—FF	FIBER SERVICE

ELECTRICAL/FIBER SERVICE

----E/F----E/F---

CONTRACTOR NOTES:

- . PLANS ARE INTENDED TO BE DIAGRAMMATIC OUTLINE ONLY, UNLESS NOTED OTHERWISE. THE WORK SHALL INCLUDE FURNISHING MATERIALS, EQUIPMENT, APPURTENANCES AND LABOR NECESSARY TO COMPLETE ALL INSTALLATIONS AS INDICATED ON THE DRAWINGS.
- LABOR NECESSARY TO COMPLETE ALL INSTALLATIONS AS INDICATED ON THE DRAWINGS.

 2. ALL EXISTING UTILITIES, FACILITIES, CONDITIONS, AND THEIR DIMENSIONS SHOWN ON THE PLAN HAVE BEEN PLOTTED FROM AVAILABLE RECORDS. THE ARCHITECT/ENGINEER AND THE OWNER ASSUME NO RESPONSIBILITY WHATSOEVER AS TO THE SUFFICIENCY OR THE ACCURACY OF THE INFORMATION SHOWN ON THE PLANS, OR THE MANNER OF THEIR REMOVAL, OR ADJUSTMENT. CONTRACTORS SHALL BE RESPONSIBLE FOR DETERMINING EXACT LOCATION OF ALL EXISTING UTILITIES AND FACILITIES PRIOR TO START OF CONSTRUCTION. CONTRACTORS SHALL ALSO OBTAIN FROM EACH UTILITY COMPANY DETAILED INFORMATION RELATIVE TO WORKING SCHEDULES AND METHODS OF REMOVING OR ADJUSTING EXISTING UTILITIES. ANY DISCREPANCIES OR DOUBTS AS TO THE INTERPRETATION OF PLANS SHOULD BE IMMEDIATELY REPORTED TO THE ARCHITECT/ENGINEER FOR RESOLUTION AND INSTRUCTION. AND NO FURTHER WORK ARCHITECT/ENGINEER FOR RESOLUTION AND INSTRUCTION, AND NO FURTHER WORK SHALL BE PERFORMED UNTIL THE DISCREPANCY IS CHECKED AND CORRECTED BY THE ARCHITECT/ENGINEER. FALUER TO SECURE SUCH INSTRUCTION MEANS CONTRACTOR WILL HAVE WORKED AT HIS/HER OWN RISK AND EXPENSE.
- WILL HAVE WORKED AT HIS/HER OWN HISH AND EXPENSE.

 CONTRACTOR SHALL DETERMINE ACTUAL ROUTING OF CONDUIT, POWER, T1 OR FIBER CABLES, GROUNDING CABLES AS SHOWN ON THE POWER, GROUNDING AND TELCO PLAN DRAWING. CONTRACTOR SHALL UNILIZE EXISTING TRAYS AND/OR SHALL ADD NEW TRAYS AS NECESSARY. CONTRACTOR SHALL CONTRINE THE ACTUAL ROUTING WITH THE CONTRACTOR. ROUTING OF TRENCHING SHALL BE APPROVED BY CONTRACTOR
- ALL MATERIALS AND CONSTRUCTION SHALL BE IN CONFORMANCE WITH THE BUILDING CODE AND ALL OTHER GOVERNING CODES. THESE NOTES SHALL BE CONSIDERED A PART OF THE WRITTEN SPECIFICATIONS.
- THE CONTRACTOR SHALL NOTIFY ARCHITECT/ENGINEER OF ANY ERRORS, OMISSIONS, OR DISCREPANCIES AS THEY MAY BE DISCOVERED IN THE PLANS, SPECIFICATIONS, & NOTES PRIOR TO STARTING CONSTRUCTION, INCLUDING BUT NOT LIMITED BY DEMOLITION. THE CONTRACTOR SHALL BE RESPONSIBLE FOR CORRECTING ANY ERROR, OMISSION, OR INCONSISTENCY AFTER THE START OF CONSTRUCTION WHICH HAS NOT OMISSION, ON INCOMPRISED A TEATH OF CONTROLLING MINISTRUS MINISTRUS MEETING METHOD OF THE ARCHITECT/ENGINEER AND SHALL INCUR ANY EXPENSES TO RECTIFY THE SITUATION. THE METHOD OF CORRECTION SHALL BE APPROVED BY THE ARCHITECT/ENGINEER.
- APPROVED BY THE ARCHITECT/ENGINEER.
 PRIOR TO STARTING CONSTRUCTION THE CONTRACTOR HAS THE RESPONSIBILITY TO LOCATE ALL EXISTING UTILITIES, WHETHER OR NOT SHOWN ON THE PLANS, AND TO PROTECT THEM FROM DAMAGE. THE CONTRACTOR OR SUBCONTRACTOR SHALL BEAR THE EXPENSE OF REPARING OR REPLACING ANY DAMAGE TO THE UTILITIES CAUSED DURING THE EXECUTION OF THE WORK. WHERE REQUIRED FOR THE PROPER EXECUTION OF THE WORK, UTILITIES SHALL BE RELOCATED AS DIRECTED BY ENGINEERS. EXTREME CAUTION SHOULD BE USED BY THE CONTRACTOR WHEN EXCAVATING OR PIER DRILLING AROUND OR NEAR UTILITIES. CONTRACTOR SHALL PROVIDE SAFETY TRAINING FOR THE WORKING CREW.
- ALL EXISTING INACTIVE SEWER, WATER, GAS, ELECTRIC AND OTHER UTILITIES, WHICH INTERFERE WITH THE EXECUTION OF THE WORK, SHALL BE REMOVED AND SHALL BE CAPPED, PLUGGED OR OTHERWISE DISCONTINUED AT POINTS WHICH WILL NOT INTERFERE WITH THE EXECUTION OF THE WORK, SUBJECT TO THE APPROVAL OF THE
- ENGINEER.

 8. A COPY OF THE APPROVED PLANS SHALL BE KEPT IN A PLACE SPECIFIED BY THE GOVERNING AGENCY, AND BY LAW SHALL BE AVAILABLE FOR INSPECTION AT ALL TIMES. IT IS THE CONTRACTOR'S RESPONSIBILITY TO ENSURE ALL CONSTRUCTION SET REFLECT THE SAME INFORMATION AS THE APPROVED PLANS. THE CONTRACTOR SHALL ALSO MAINTAIN ONE SET OF PLANS AT THE SITE FOR THE PURPOSE OF DOCUMENTING ALL AS—BULLT (FANNES, REVISIONS, ADDEDNUMS, OR CHANGE ORDERS. THE CONTRACTOR SHALL FORWARD THE AS—BULLT/HIRED DRAWINGS TO THE ARCHITECT/ENGINEER AT THE CONCLUSION OF THE PROJECT.
- 9. THE CONTRACTOR SHALL BE RESPONSIBLE FOR THE COMPLETE SECURITY OF THE SITE WHILE THE WORK IS IN PROGRESS UNTIL THE JOB IS COMPLETE.
- THE CONTRACTOR IS RESPONSIBLE TO PROVIDE TEMPORARY POWER, WATER, AND TOILET FACILITIES AS REQUIRED BY THE PROPERTY OWNER OR GOVERNING AGENCY.

 THE CONTRACTOR SHALL BE RESPONSIBLE FOR COMPLYING WITH ALL SAFETY PRECAUTIONS AND REGULATIONS DURING THE WORK. THE ENGINEER WILL NOT ADVISE ON, NOR PROVIDE DIRECTION, AS TO SAFETY PRECAUTIONS AND PROGRAMS.
- 12. THE CONTRACTOR IS SOLELY RESPONSIBLE FOR ALL CONSTRUCTION MEANS, METHODS, TECHNIQUES, PROCEDURES, SEQUENCING, AND COORDINATING ALL PORTIONS OF THE WORK UNDER THE PROJECT. FURTHERMORE, THE STRUCTURE IS DESIGNED AS A UNIT UPON COMPLETION. THE CONTRACTOR IS RESPONSIBLE FOR FURNISHING ALL TEMPORARY BRACING AND/OR SUPPORT THAT MAY BE REQUIRED AS THE RESULT OF THE CONTRACTOR'S CONSTRUCTION METHODS. THE INVESTIGATION, DESIGN, SAFETY, ADEQUACY AND INSPECTION OF BRACING, SHORING, TEMPORARY SUPPORTS, ETC. IS THE SOLE RESPONSIBILITY OF THE CONTRACTOR.
- 13. THE CONTRACTOR SHALL BE RESPONSIBLE TO OBTAIN AND PAY FOR ALL PERMITS, LICENSES AND INSPECTIONS WITH RESPECT TO THE WORK TO COMPLETE THE PROJECT. BUILDING PERMIT APPLICATIONS SHALL BE FILED BY THE OWNER OR HIS REPRESENTATIVE. CONTRACTOR SHALL OBTAIN THE PERMIT AND MAKE FINAL PAYMENT OF SAID DOCUMENT(S).
- 14. ALL DIMENSIONS TAKE PRECEDENCE OVER SCALE UNLESS OTHERWISE NOTED.
- THE CONTRACTOR SHALL PROVIDE ALL NECESSARY FRAMING, BACKING, HANGERS, BLOCKING OR SUPPORTS FOR INSTALLATION OF ITEMS INDICATED ON THE DRAWINGS.
- NEW CONSTRUCTION ADDED TO EXISTING CONSTRUCTION SHALL BE MATCHED IN FORM, TEXTURE, MATERIAL AND PAINT COLOR EXCEPT AS NOTED IN THE PLANS.
- WHERE SPECIFIED, MATERIALS TESTING SHALL BE TO THE LATEST STANDARDS AVAILABLE AS REQUIRED BY THE LOCAL GOVERNING AGENCY RESPONSIBLE FOR RECORDING THE RESULTS.
- ALL GENERAL NOTES AND STANDARD DETAILS ARE THE MINIMUM REQUIREMENTS TO BE USED IN CONDITIONS WHICH ARE NOT SPECIFICALLY SHOWN OTHERWISE.
- 19. ALL SYMBOLS AND ABBREVIATIONS ARE CONSIDERED CONSTRUCTION INDUSTR STANDARDS, IF A CONTRACTOR HAS A QUESTION REGARDING THEIR EXACT MEANING. THE ARCHITECT/ENGINEER SHALL BE NOTIFIED FOR CLARIFICATIONS.
- CONTRACTORS SHALL VISIT THE SITE PRIOR TO BID TO ASCERTAIN CONDITIONS WHICH MAY ADVERSELY AFFECT THE WORK OR COST THEREOF.
- 21. THE CONTRACTOR SHALL FIELD VERIFY THE DIMENSIONS, ELEVATIONS, ETC. NECESSARY FOR THE PROPER CONSTRUCTION AND ALIGNMENT OF THE NEW PORTION OF THE WORK TO THE EXISTING WORK.
- 22. REPRESENTATIONS OF TRUE NORTH, OTHER THAN THOSE FOUND ON THE PLOT OF SURVEY DRAWING (SHEET LS1), SHALL NOT BE USED TO IDENTIFY OR ESTABLISH THE BEARING OF TRUE NORTH AT THE SITE. THE CONTRACTOR SHALL RELY SOLELY ON THE PLOT OF SURVEY DRAWING AND ANY SURVEYOR'S MARKINGS AT THE SITE FOR THE PLOT OF SURVEY DRAWING AND ANY SURVEYOR'S MARKINGS AT THE STIE FOR THE ESTABLISHMENT OF TRUE NORTH, AND SHALL NOTIFY THE ARCHITECT/ ENGINEER PRIOR TO PROCEEDING WITH THE WORK. IF ANY DISCREPANCY IS FOUND BETWEEN THE VARIOUS ELEMENTS OF THE WORKING DRAWINGS AND THE TRUE NORTH ORIENTATION AS DEPICTED ON THE CIVIL SURVEY, THE CONTRACTOR SHALL ASSUME SOLE LIABILITY FOR ANY FAILURE TO NOTIFY THE ARCHITECT/ENGINEER.
- 23. NO CHANGES ARE TO BE MADE TO THESE PLANS WITHOUT THE KNOWLEDGE AND NO CHANGES ARE 10 BE MADE TO THESE PLANS WITHOUT THE KNOWLEDGE AND WRITTEN CONSENT OF THE ARCHITECT/ ENGINEER. UNAUTHORIZED CHANGES RENDER THESE DRAWINGS VOID. THIS INCLUDES THAT THE CONTRACTOR SHALL NOT BE RELIEVED OF ANY DEVIATION FROM THE PLANS BY THE PROFESSIONAL'S OF RECORD REVIEW OF SHOP DRAWINGS, PRODUCT DATA, ETC. UNLESS THE CONTRACTOR HAS SPECIFICALLY INFORMED THE PROFESSIONAL OF RECORD OF SUCH DEVIATION IN WRITING AT THE TIME OF SUBMISSION, AND THE PROFESSIONAL OF RECORD HAS GIVEN WRITTEN APPROVAL TO THE SPECIFIC DEVIATION.
- 24. ANY REFERENCE TO THE WORDS "APPROVED" OR "APPROVAL" IN THESE DOCUMENTS SHALL BE HERE DEFINED TO MEAN CENERAL ACCEPTANCE OR REVIEW AND SHALL NOT RELIEVE THE CONTRACTOR AND/OR HIS SUB-CONTRACTORS OF ANY LIABILITY IN FURNISHING THE REQUIRED MATERIALS OR LABOR SPECIFIED.
- 25. KEEP GENERAL AREA CLEAN, HAZARD FREE, AND DISPOSE OF ALL DIRT, DEBRIS, RUBBISH AND REMOVE EQUIPMENT NOT SPECIFIED AS REMAINING ON THE PROPERTY. LEAVE PREMISES IN CLEAN CONDITION AND FREE FROM PAINT SPOTS, DUST OR SMUDGES OF ANY NATURE

EQUIPMENT LOCATION

- THE DRAWINGS INDICATE DIAGRAMMATICALLY THE DESIRED LOCATIONS OR ARRANGEMENTS OF CONDUIT RUNS, OUTLETS, EQUIPMENT, ETC., AND ARE TO BE FOLLOWED AS CLOSELY AS POSSIBLE. PROPER DIDDEGMENT MUST BE EXERCISED IN EXECUTING THE WORK SO AS TO SECURE THE BEST POSSIBLE INSTALLATION IN THE AVAILABLE SPACE LIMITATIONS OR INTERFERENCE OF STRUCTURE CONDITIONS
- ENCOUNTERED.

 IN THE EVENT CHANGES IN THE INDICATED LOCATIONS OR ARRANGEMENTS ARE NECESSARY, DUE TO FIELD CONDITIONS IN THE BUILDING CONSTRUCTION OR REARRANGEMENT OF FURNISHINGS OR EQUIPMENT, SUCH CHANGES SHALL BE MADE WITHOUT COST, PROVIDING THE CHANGE IS ORDERED BEFORE THE CONDUIT RUNS, ETC., AND WORK DIRECTLY CONNECTED TO THE SAME IS INSTALLED AND NO EXTRA MATERIALS ARE REQUIRED.
- 3. COORDINATE THE WORK OF THIS SECTION WITH THAT OF ALL OTHER TRADES, WHERE CONFLICTS OCCUR, CONSULT WITH THE RESPECTIVE CONTRACTOR AND COME TO AGREEMENT AS TO CHANGES NECESSARY, OBTAIN WRITTEN ACCEPTANCE FROM ENGINEER FOR THE PROPOSED CHANGES BEFORE

UTILITY SERVICE

- TELEPHONE AND ELECTRICAL METERING FACILITIES SHALL CONFORM TO THE REQUIREMENTS OF THE SERVING UTILITY COMPANIES, CONTRACTOR SHALL VERIFY SERVICE LOCATIONS AND REQUIREMENTS. SERVICE INFORMATION WILL BE FURNISHED BY THE SERVING UTILITIES.
- 2. CONFORM TO ALL REQUIREMENTS OF THE SERVING UTILITY COMPANIES







C 05/17/2019 SETBACK ADDED

REV DATE ISSUED DATE:


B 03/08/2019 100% CD'S A 02/01/2019 90% CD'S SET

MAY 17, 2019

DESCRIPTION

ISSUED-FOR: -

100% CD SET

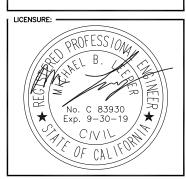

PROJECT INFORMATION:

SOUTH CARMEL 005 LOCATION CODE: 428220 IFO MISSION ST. 2 SW 12TH AVE. CARMEL, CA 93923


DRAWN BY SAG CHECKED BY

SHEET TITLE:

NOTES AND **SPECIFICATIONS**

SHEET-NUMBER:

T-2

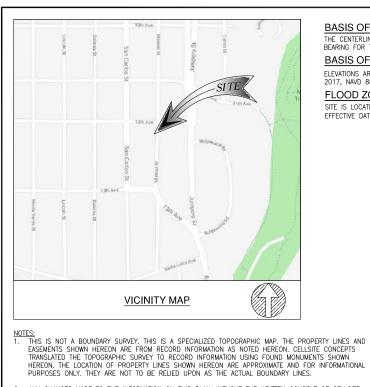

2. ANY CHANGES MADE TO THE INFORMATION ON THIS PLAN, WITHOUT THE WRITTEN CONSENT OF CELLSITE

SHOULD BE CONSIDERED APPROXIMATE (+/-) AND ONLY FOR THE DATE OF THIS SHOW. THEY ARE PROVIDED AS A GENERAL REFERENCE AND SHOULD NOT BE USED FOR DESIGN PURPOSES.

4. RIGHT-OF-WAY WAS ESTABLISHED BY LOCATING FOUND CENTERLINE CITY OR COUNTY MONUMENTS. IF CENTERLINE MONUMENTS WERE NOT LOCATABLE, THE CENTERLINE OFFSET TIES WERE USED TO ESTABLISH THE INTERSECTIONS. IF NEITHER CENTERLINE TIES OR CENTERLINE INTERSECTION MONUMENTS WERE

5. ALL SHOWN RIGHT-OF-WAY WERE BASED UPON RESEARCH AT COUNTY OR CITY FILES AND REFLECT THE LATEST RECORDED MAPS, RECORDS OF SURVEY, PARCEL MAPS OR OTHER RECORDS. RIGHT-OF-WAY WILL NOT REFLECT ANY DEDICATION, TAKEN OR OFFERED AFTER THE THE RECORD MAP USED. ALL SURVEYS WERE COMPLETED WITHOUT THE BENEFIT OF A CURRENT TITLE REPORT AND MAY NOT SHOW ADDITIONAL DEDICATIONS NOT SHOWN ON THE RECORD MAPS USED.

LOCATABLE, EXISTING IMPROVEMENTS WERE USED TO ESTABLISH RIGHT-OF-WAY.

3. THE HEIGHTS AND ELEVATIONS FOR THE TREES, BUSHES AND OTHER LIVING PLANTS SHOWN HEREON,

BASIS OF BEARING

THE CENTERLINE OF MISSION STREET BEARING S00"06"00"W WAS USED AS BASIS OF BEARING FOR THIS SURVEY.


BASIS OF ELEVATIONS: (NAVD 1988)

ELEVATIONS ARE BASED ON CALVRS G.P.S. BROADCAST COORDINATE VALUES FOR 2017, NAVD 88

FLOOD ZONE

SITE IS LOCATED IN FLOOD ZONE "X" AS PER F.I.R.M. MAP NO. 06053C0316H

LEGEND CENTER LINE PROPERTY LINE CHAIN-LINK FENCE WOOD FENCE WROUGHT IRON FENCE EASEMENT LINE RETAINING WALL TOP OF CURB FLOW LINE FINISH SURFACE EXISTING GRADE EG HFIGHT EDGE OF PAVEMENT BACK OF WALL

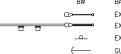

EXISTING STREET LIGHT EXISTING TRAFFIC SIGNAL EXISTING SIGN GUY WIRE







PALM TREE



TREE

BUSH



EXISTING CONCRETE




EXISTING GRASS/TURF

MONUMENT FD.




LATITUDE: 36°32'51.48"N (36.54764) LONGITUDE: 121'55'15.57"W (-121.92099)

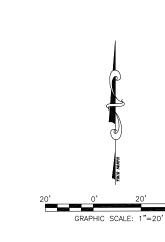

PROPERTY LINES ARE BASED FROM MAP NO. 5155 RECORD OF SURVEY NO. 20314 CORNER RECORD NO. 30848 CORNER RECORD NO. 30867 UTILITY POLE PROFILE


DATED JUNE 1942 DATED SOME 1942
DATED AUGUST 1988
DATED SEPTEMBER 2008
DATED SEPTEMBER 2008

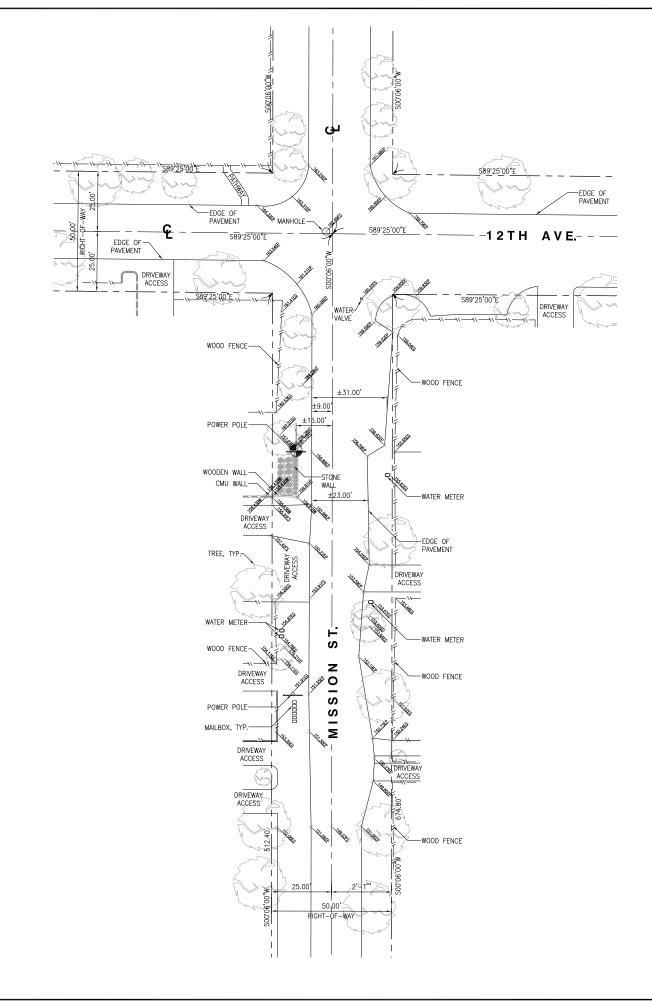







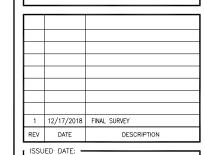

DECEMBER 17, 2018

ISSUED-FOR: -

FINAL SURVEY

LICENSURE: L.S. 8780 Exp. 12/31/20

SOUTH CARMEL 005

IFO MISSION ST 2SW 12TH AVE., CARMEL, CA 93923


DRAWN BY: APL

SHEET-TITLE:

TOPOGRAPHIC SURVEY

SHEET-NUMBER:

LS-1

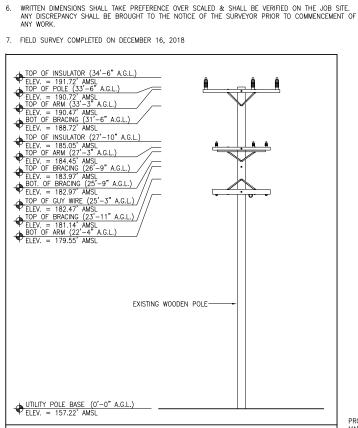


SITE NOTES:

- 1. REPRESENTATIONS OF TRUE NORTH, OTHER THAN THOSE FOUND ON THE PLOT OF SURVEY DRAWINGS SHALL NOT BE USED TO IDENTIFY OR ESTABLISH BEARING OF TRUE NORTH AT THE SITE. THE CONTRACTOR SHALL RELY SOLELY ON THE PLOT OF SURVEY DRAWING AND ANY SURVEYOR'S MARKINGS AT THE SITE FOR THE ESTABLISHMENT OF TRUE NORTH, AND SHALL NOTIFY THE ARCHITECT/ENGINEER PRIOR TO PROCEEDING WITH THE WORK IF ANY DISCREPANCY IS FOUND BETWEEN THE VARIOUS ELEMENTS OF THE WORKING PAWNINGS AND THE TRUE NORTH ORIENTATION AS DEPICTED ON THE CIVIL SURVEY. THE CONTRACTOR SHALL ASSUME SOLE LIABILITY FOR ANY FAILURE TO NOTIFY THE ARCHITECT/ ENGINEER.
- CONTRACTOR TO VERIFY LOCAL UTILITY REQUIREMENTS FOR DEPTH, SIZES, AND SEPARATION OF CONDUITS PRIOR TO INSTALLATION. NOTIFY CONSTRUCTION MANAGER IMMEDIATELY OF ANY DISCREPANCIES.
- PROPOSED UTILITY SERVICES SHOWN NEED TO BE VERIFIED AND APPROVED BY UTILITY COMPANIES BEFORE START OF CONSTRUCTION. CONTRACTOR TO VERIFY WITH CLIENT PROJECT MANAGER TO OBTAIN FINAL APPROVAL.
- 4. VERIFY, LOCATE, AND PROTECT ALL EXISTING SUBSTRUCTURES AS REQUIRED, CALL DIG ALERT ® (800) 227–2600 48 HOURS BEFORE ANY EXCAVATION. CONTRACTOR IS RESPONSIBLE TO HAVE ALL NON-PUBLIC UTILITIES LOCATED AT THEIR OWN EXPENSE.
- CONTRACTOR SHALL IMMEDIATELY INFORM CLIENT OF ANY ACCIDENTAL DAMAGE TO EXISTING UTILITIES VA PHONE OR EMAIL REGARDLESS OF ABILITY TO REPAIR OR MITIGATE. A FOLLOW-UP EMAIL REPORT WITH DIGITAL PHOTOS WILL BE REQUIRED DAILY UNTIL RESOLUTION HAS BEEN ACCEPTED BY CLIENT, AFFOCTED SERVICE PROVIDERS, AND RECIPIENTS. AT THEIR OWN EXPENSE, CONTRACTOR WILL EXERCISE ALL EFFORTS TO HAVE REPAIRS MADE BY QUALIFIED TECHNICIANS AS APPROVED BY SERVICE PROVIDER.
- REPAIRS MADE BY QUALIFIED TECHNICIANS AS APPRIVED BY SERVICE PROVIDER.

 6. CONTRACTOR SHALL VERIETY ALL EXISTING UTILITIES, BOTH HORIZONTAL AND VERTICALLY, PRIOR TO THE START OF CONSTRUCTION. ANY DISCREPANCIES OR DOUBTS AS TO THE INTERPERTATION OF PLANS SHOULD BE IMMEDIATELY REPORTED TO THE ARCHITECT/ENGINEER FOR RESOLUTION AND INSTRUCTION, AND NO FURTHER WORK SHALL BE REFORMED UNTIL THE DISCREPANCY IS CHECKED AND CORRECTED BY THE ARCHITECT/ENGINEER, FAILURE TO SECURE SUCH INSTRUCTION MEANS CONTRACTOR WILL HAVE WORKED AT HIS/HER OWN RISK AND EXPENSE.
- ALL NEW AND EXISTING UTILITY STRUCTURES ON SITE AND IN AREAS TO BE DISTURBED BY CONSTRUCTION SHALL BE ADJUSTED TO FINISH ELEVATIONS PRIOR TO FINAL INSPECTION OF WORK.
- 8 ANY DRAIN AND YOR FIELD THE ENCOUNTERED/DISTURBED DURING CONSTRUCTION SHALL ANT DRAIN AND TOR FIELD THE ENCOUNTERCY DISTORBED UNRING CONSIDERING THE BE RETURNED TO IT'S ORIGINAL CONDITION PRIOR TO COMPLETION OF WORK, SIZE, LOCATION AND TYPE OF ANY UNDERGROUND UTILITIES OR IMPROVEMENTS SHALL BE ACCURATELY NOTED AND PLACED ON "AS-BUILT" DRAWINGS BY GENERAL CONTRACTOR, AND ISSUED TO THE ARCHITECT OR ENGINEER AT COMPLETION OF PROJECT.
- ALL TEMPORARY EXCAVATIONS FOR THE INSTALLATION OF FOUNDATIONS, UTILITIES, ETC., SHALL BE PROPERLY LAID BACK OR BRACED IN ACCORDANCE WITH THE CORRECT OCCUPATIONAL SAFETY AND HEALTH ADMINISTRATION (OSHA) REQUIREMENTS.
- 10. NEW CONDUITS SHALL BE INSTALLED IN TRENCH SUCH THAT THE TOP OF CONDUIT SHALL HAVE A MINIMUM COVER OF 30-INCHES BELOW ADJACENT EDGE OF PAVEMENT OR ORIGINAL GROUND, WHICHEVER IS LOWER IN ELEVATION.
- ALL PULL BOXES SHALL BE PRECAST REINFORCED CONCRETE AND HAVE NON CONDUCTIVE LIDS. EXISTING PULL BOX COVERS THAT ARE MARKED INCORRECTLY SHALL BE REPLACED.
- 12. REGRADE LANDSCAPING AS NEEDED AND REPLACE DAMAGED IRRIGATION LINES WITHIN



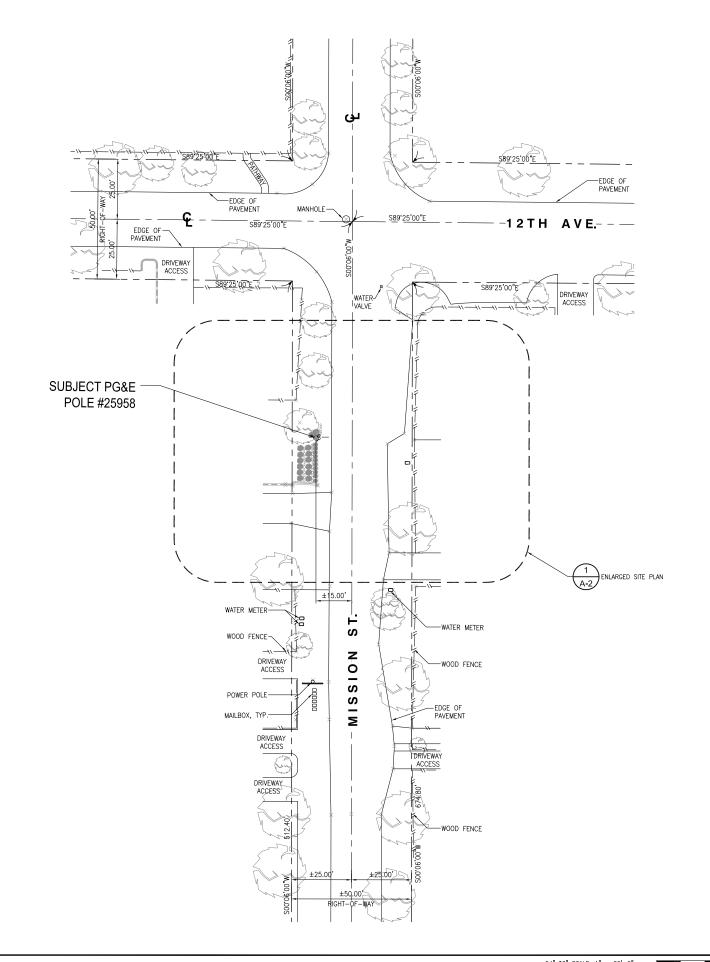







10650 SCRIPPS RANCH BLVD., SUITE 224 SAN DIEGO, CA 92131 tel: (858) 433-7173 / (858) 433-7176

П			
П			
П			
П			
П	С	05/17/2019	SETBACK ADDED
П	В	03/08/2019	100% CD'S
П	Α	02/01/2019	90% CD'S SET
	REV	DATE	DESCRIPTION

ISSUED DATE: •

MAY 17, 2019

ISSUED FOR: -

100% CD SET

LICENSURE: 뮏 No. C 83930 , ★ \ Exp. 9-30-19

PROJECT INFORMATION:

SOUTH CARMEL 005 LOCATION CODE: 428220

IFO MISSION ST. 2 SW 12TH AVE. CARMEL, CA 93923

DRAWN BY: CHECKED BY:


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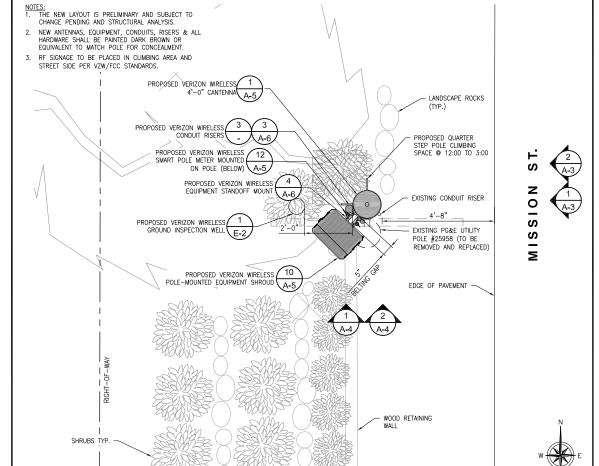
SHEET NUMBER:

SITE PLAN

UNDERGROUND UTILITIES NOTE:

UNDERGROUND UTILITIES NOTE:
ALL EXISTING SUB-SURFACE UTILITIES, FACILITIES, CONDITIONS, AND THEIR
DIMENSIONS SHOWN ON THE PLAN HAVE BEEN PLOTTED FROM FIELD SURVEY
AND/OR AVAILABLE RECORDS, THE ARCHITECT/ ENGINEER AND THE OWNER
ASSUME NO RESPONSIBILITY WHATSOEVER AS TO THE SUFFICIENCY OR THE
ACCURACY OF THE INFORMATION SHOWN ON THE PLANS, OR THE MANNER OF
THEIR REMOVAL OR ADJUSTMENT. CONTRACTORS SHALL BE RESPONSIBLE FOR
THEIR DETERMINING EXACT LOCATION OF ALL EXISTING UTILITIES AND FACILITIES
PRIOR TO START OF CONSTRUCTION. CONTRACTORS SHALL ALSO DETAIN FROM
EACH UTILITY COMPANY DETAILED INFORMATION RELATIVE TO WORKING
SCHEDULES AND METHODS OF REMOVING OR ADJUSTING EXISTING UTILITIES.
THERE MAY BE EXISTING UTILITIES OFTHER THAN THOSE SHOWN ON THIS PLAN.
THE CONTRACTOR IS REQUIRED TO TAKE PRECAUTIONARY MEASURES TO
PROTECT THE UTILITY LINE SHOWN AND ANY OTHER LINES NOT SHOWN ON
THIS PLAN.



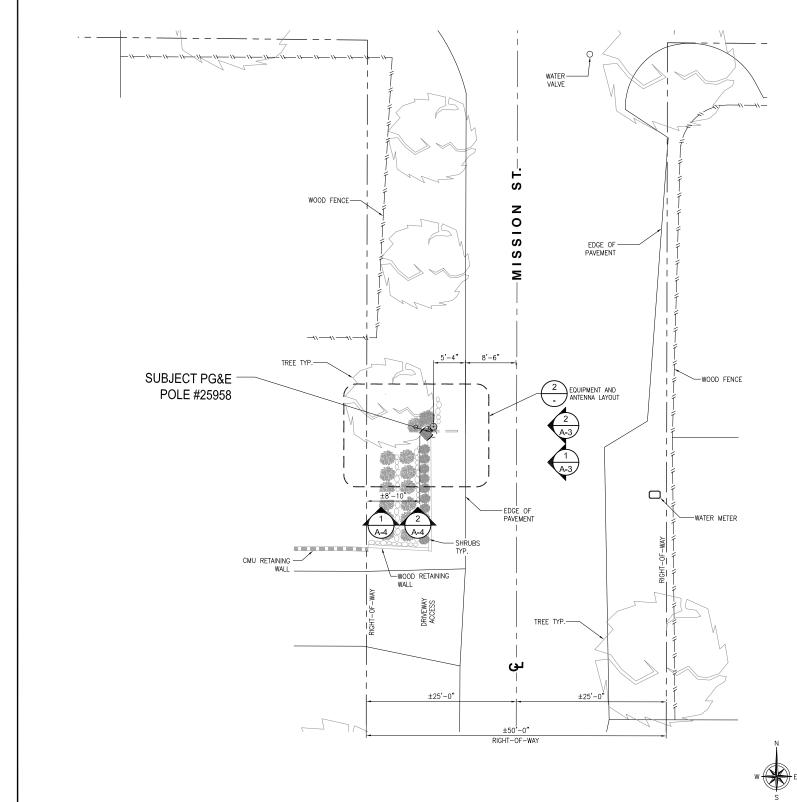

EQUIPMENT AND ANTENNA LAYOUT

EXISTING POLE INFORMATION PROPOSED POLE INFORMATION POLE HEIGHT: 40 FT POLE HEIGHT: 50 FT MATERIAL: MATERIAL: POLE CLASS: POLE TYPE: JOINT UTILITY POLE YEAR SET: 1984 POLE CLASS: TBD YEAR SET: TBD

MAKE-READY SCOPE:

VERIZON TO INSTALL (1) SMART POLE METER ON STANDOFF MOUNT AT 10:30 POSITION.

2. VERIZON TO INSTALL (1) DISTRIBUTION PANEL AND DISCONNECT SWITCH ON STANDOFF MOUNT AT 10:30 PROPOSED 36"x36".

POSITION. POSITION.

3. VERIZON TO INSTALL (1) EQUIPMENT SHROUD ON STANDOFF MOUNT AT 10:30 POSITION. 4. VERIZON TO INSTALL (1) POLE TOP CANTENNA MOUNTING BRACKET

5. VERIZON TO INSTALL (1) 4FT CANTENNA ON TOP OF

6. VERIZON TO INSTALL 2" SCHEDULE 80 PVC POWER RISER MOUNTED ON CONDUIT STANDOFF AT 9:30 POSITION FROM SERVICE DROP TO METER. VERIZON TO INSTALL 4" SCHEDULE 80 PVC HYBRID RISER MOUNTED ON CONDUIT STANDOFF AT 11:30 POSITION FROM RRUS TO ANTENNA.

INSTALL 2" SCHEDULE 80 PVC FIBER RISER MOUNTED ON CONDUIT STANDOFF AT 10:00 POSITION FROM SERVICE DROP TO EQUIPMENT CABINET.

9. VERIZON TO STEP POLE @ 12:00 TO 3:00

10. VERIZON TO PULL, TRANSPORT AND DISPOSE EXISTING

ഗ Z 0 EXISTING UTILITY PG&E POLE #25958 TO BE REMOVED AND REPLACED S S Ξ **EXISTING POLE** 8 PROPOSED VERIZON WIRELESS POLE STEPS S PROPOSED VERIZON Z PROPOSED GROUND ON-WIRELESS RF SIGNAGE PER VZW STANDARDS HARDWOOD MOLDING 0 S CONDUIT RISER FROM S RRUS TOWARDS ANTENNA RELOCATED EXISTING CONDUIT RISER ALONG POLE Σ PROPOSED 50' UTILITY


PROPOSED POLE

24"x36" SCALE: 1/2" = 1'-0" 11"x17" SCALE: 1/4" = 1'-0"







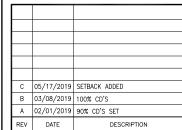

ISSUED DATE:

MAY 17, 2019

ISSUED FOR: -

EXISTING CONDUIT RISER ALONG POLE

100% CD SET

LICENSURE: 뀓 No. C 83930 (★) Exp. 9-30-19

PROJECT INFORMATION:

SOUTH CARMEL 005 LOCATION CODE: 428220 IFO MISSION ST. 2 SW 12TH AVE.

DRAWN BY: CHECKED BY:

CARMEL, CA 93923

ENLARGED SITE PLAN AND EQUIPMENT ANTENNA LAYOUT

SHEET-NUMBER

A-2

8' 6' 4' 2' 0" 11"x17" SCALE: 1/16" = 1'-0"

24"x36" SCALE: 1/8" = 1'-0"

EXISTING PG&F UTILITY


POLE #25958 (TO BE

REMOVED AND REPLACED)

(N) 2" SCH, 80 FIBER-

(N) 2" SCH. 80 POWER CONDUIT RISER


CONDUIT RISER TOWARDS
FIBER PATCH PANEL

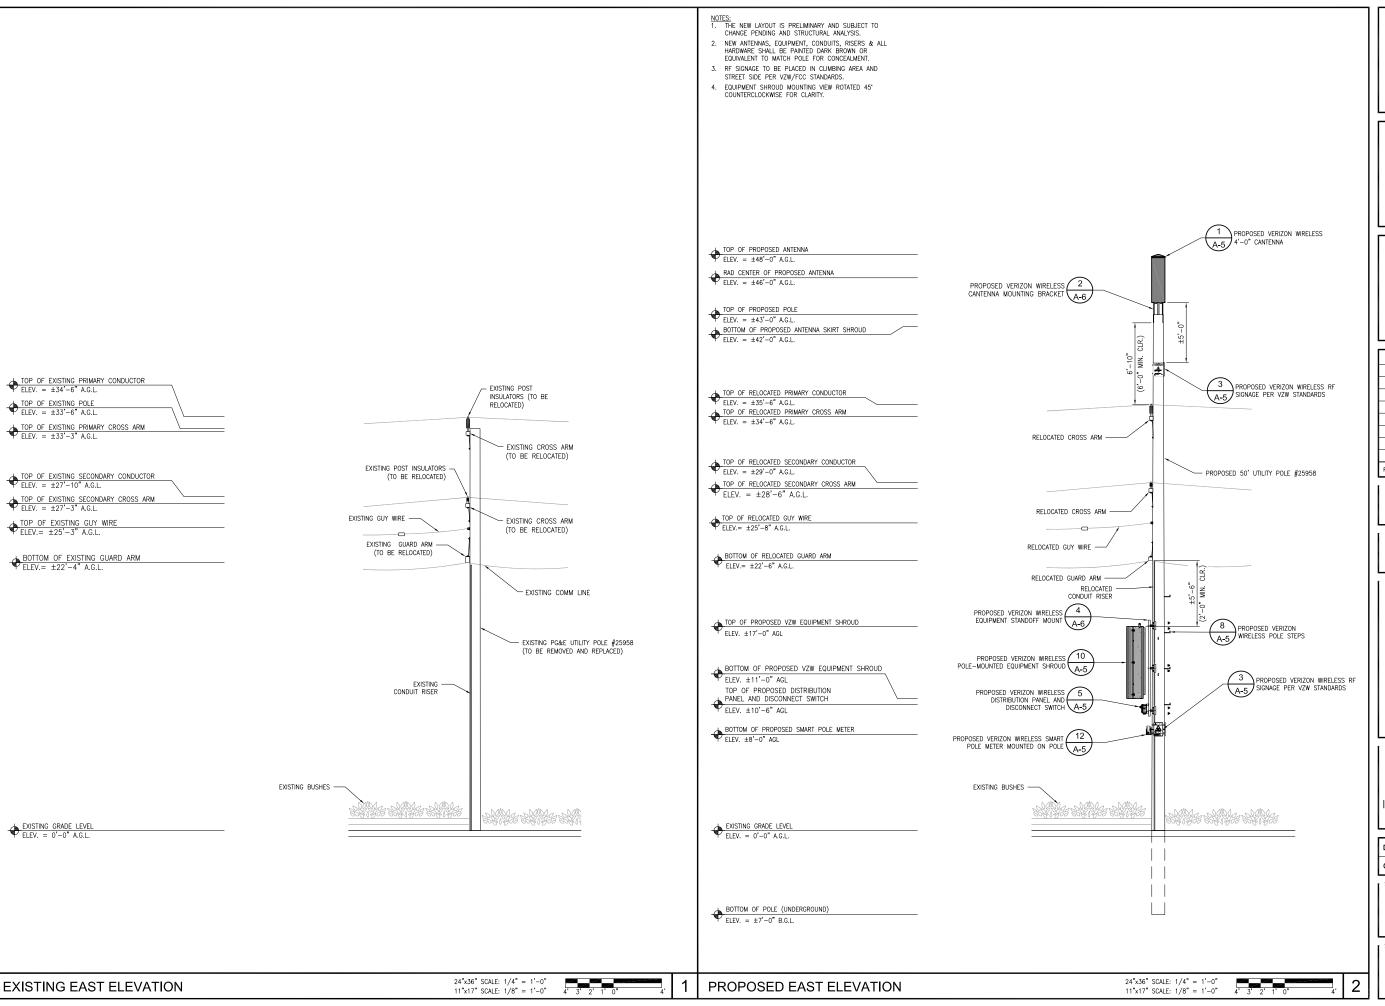







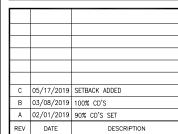

MAY 17, 2019

ISSUED FOR: -

100% CD SET

No. C 83930 Exp. 9-30-19

PROJECT INFORMATION:


SOUTH CARMEL 005
LOCATION CODE: 428220
IFO MISSION ST. 2 SW 12TH AVE.,
CARMEL, CA 93923

DRAWN BY: SAC
CHECKED BY: RGG

SHEET-TITLE:

ARCHITECTURAL ELEVATIONS


SHEET NUMBER: -

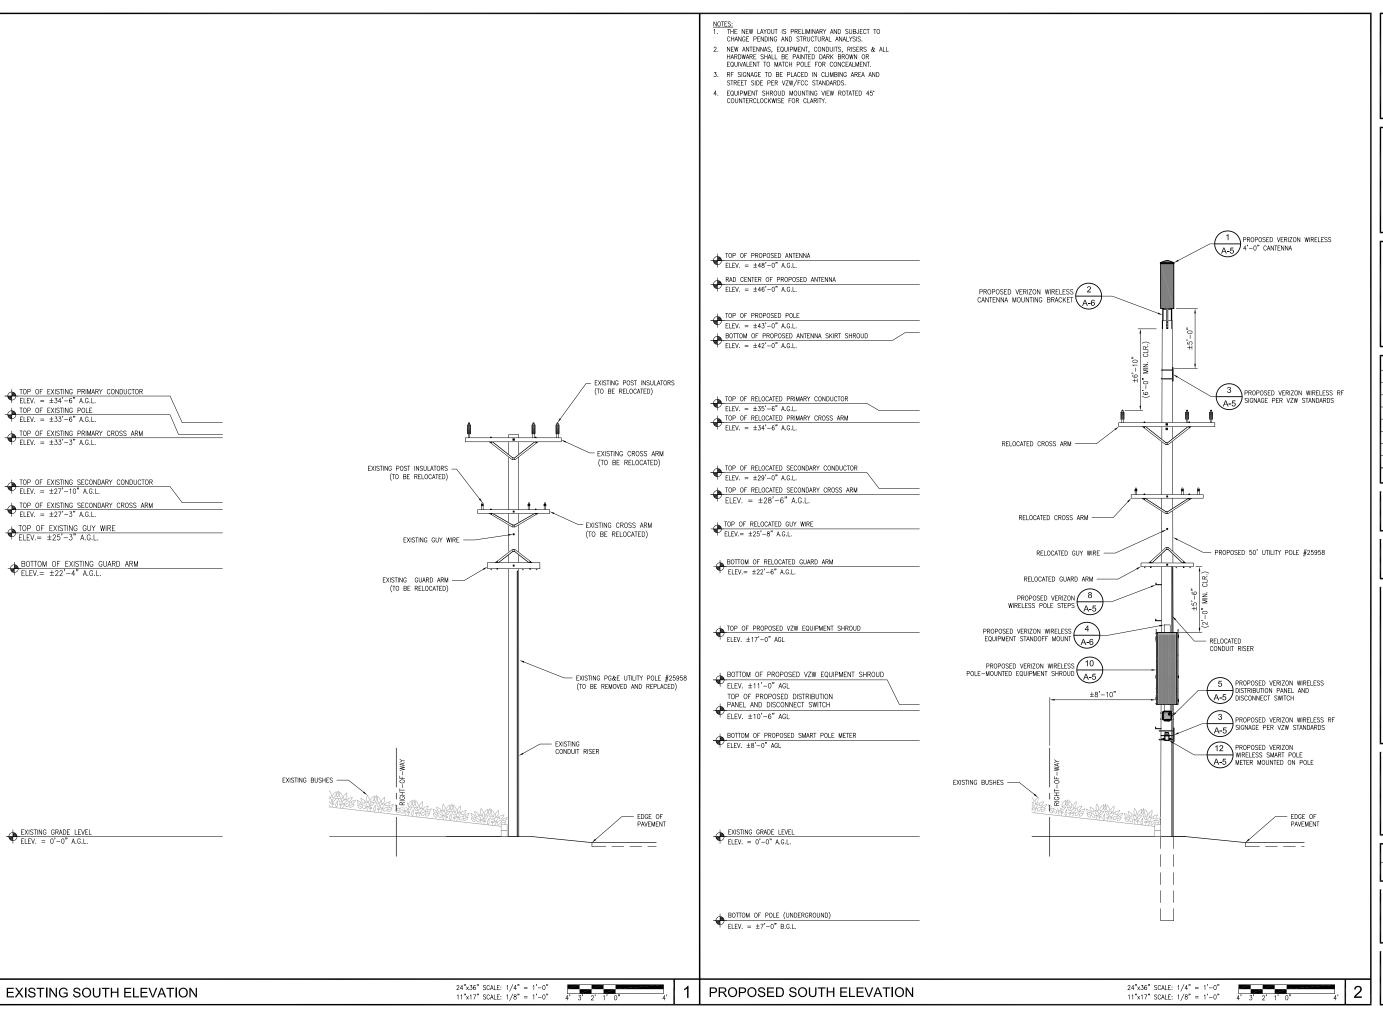







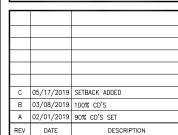

MAY 17, 2019

ISSUED FOR: -

100% CD SET



PROJECT INFORMATION:

SOUTH CARMEL 005 LOCATION CODE: 428220


IFO MISSION ST. 2 SW 12TH AVE., CARMEL, CA 93923

DRAWN BY: SAG CHECKED BY: RGG

SHEET-TITLE:

ARCHITECTURAL ELEVATIONS

SHEET NUMBER: -

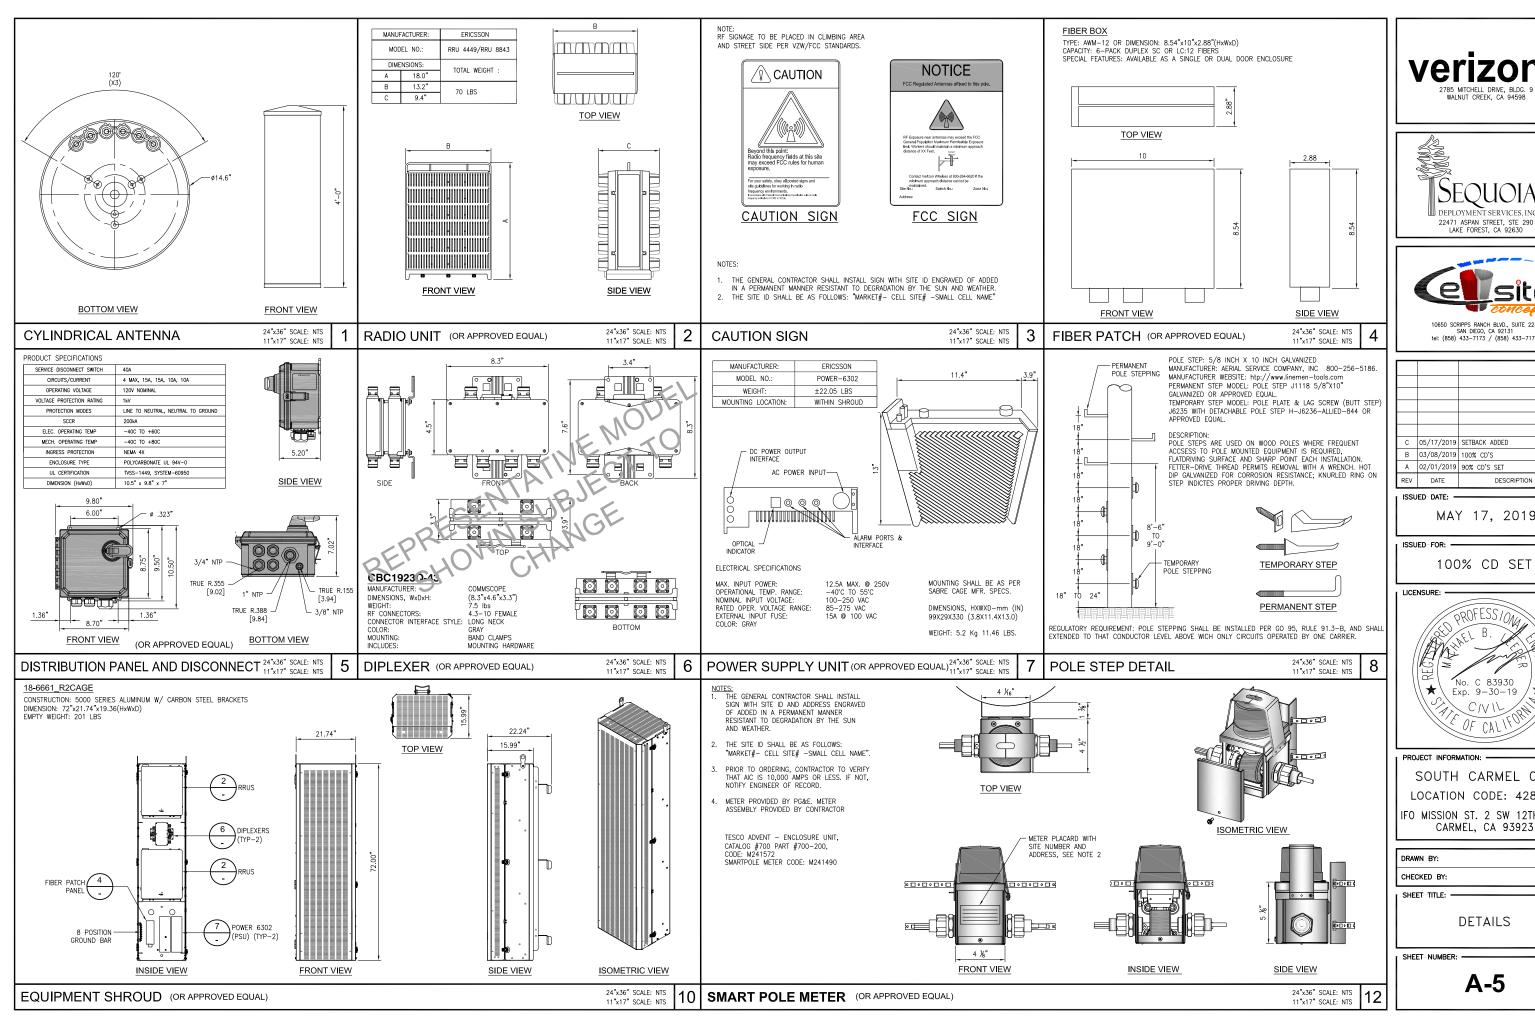







C 05/17/2019 SETBACK ADDED B 03/08/2019 100% CD'S A 02/01/2019 90% CD'S SET DESCRIPTION

MAY 17, 2019


100% CD SET



SOUTH CARMEL 005 LOCATION CODE: 428220 IFO MISSION ST. 2 SW 12TH AVE.

CHECKED BY:

DETAILS

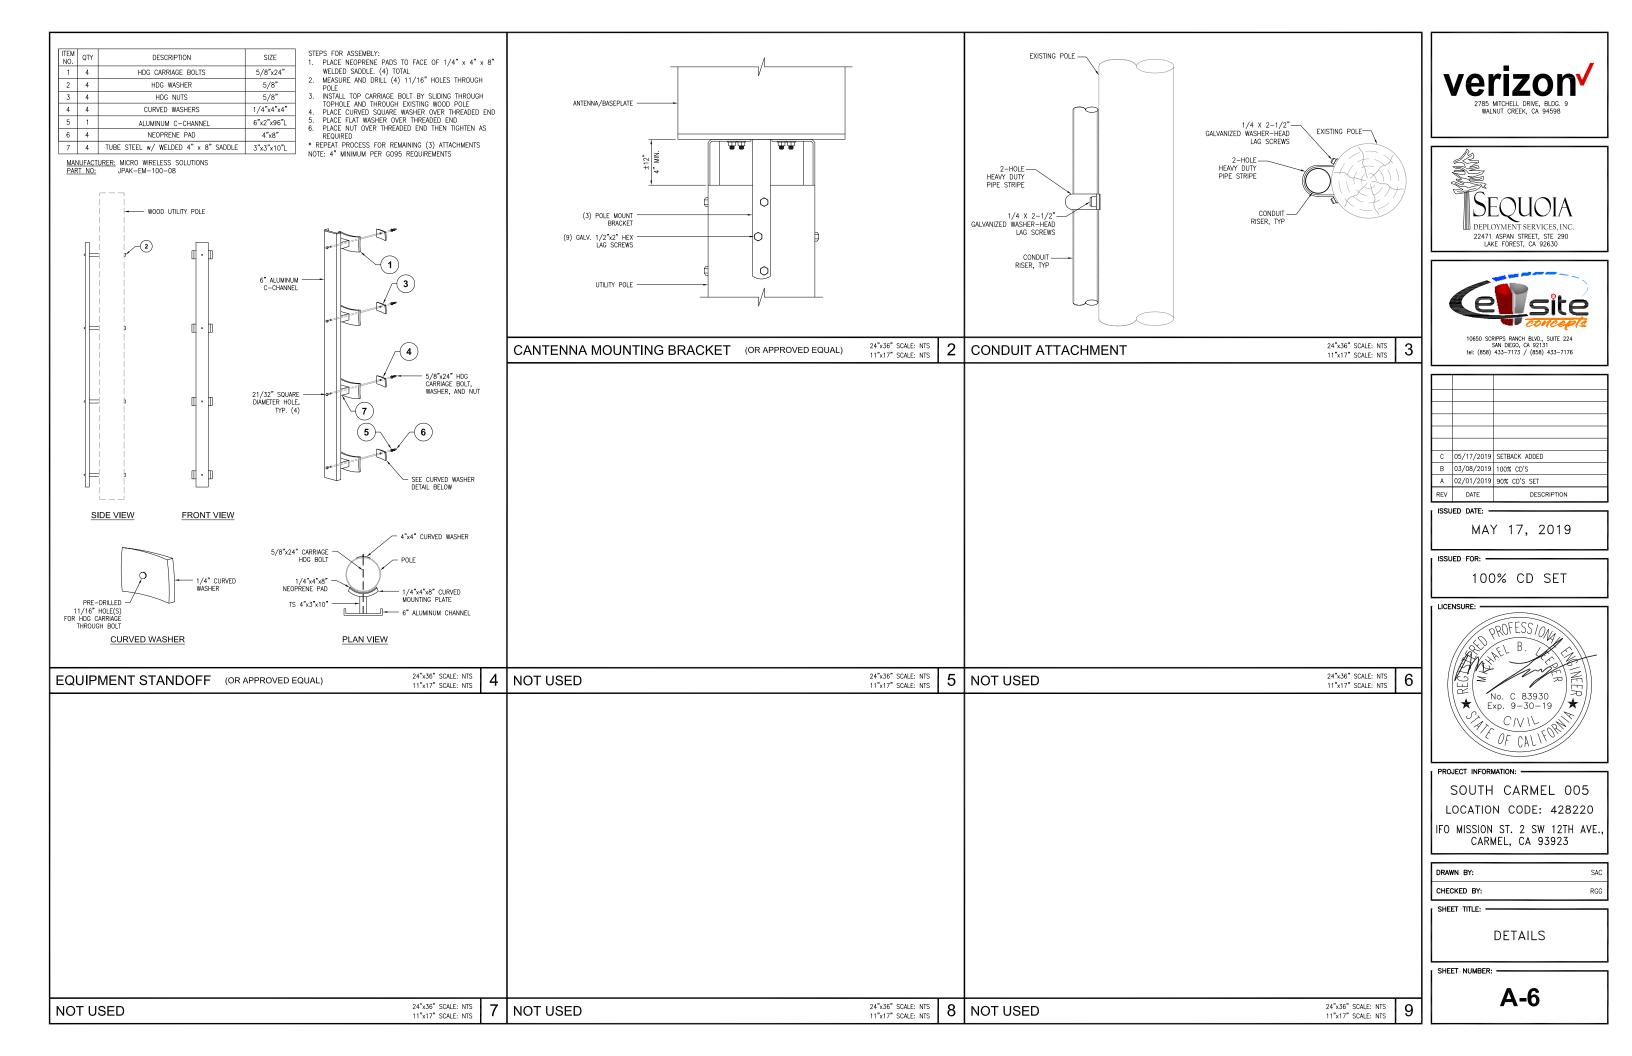

ELECTRICAL NOTES

- THIS INSTALLATION SHALL COMPLY WITH THE CURRENTLY ADOPTED EDITION OF THE CALIFORNIA ELECTRICAL CODE (CEC), WITH THE UTILITY COMPANY AND LOCAL CODE RECHIREMENTS
- POWER, CONTROL AND FOUIPMENT GROUND WIRING IN CONDUIT SHALL BE SINGLE CONDUCTOR (#12 AWG AND LARGER), 600V, OIL RESISTANT THHN OR THWN-2, CLASS B STRANDED COPPER CABLE RATED FOR 90°C (WET AND DRY) OPERATION; LISTED OR LABELED FOR THE LOCATION AND RACEWAY SYSTEM USED.
- CUT, COIL AND TAPE A 3 FOOT PIGTAIL FROM END OF LFMC FOR TERMINATING AT EQUIPMENT, IF REQUIRED.
- SUPPLEMENTAL EQUIPMENT GROUND WIRING LOCATED OUTDOORS OR BELOW GRADE SHALL BE SINGLE CONDUCTOR #2 AWG SOLID, TINNED, COPPER WIRE
- ALL POWER AND GROUNDING CONNECTIONS SHALL BE CRIMP STYLE, COMPRESSION, WIRE LUGS AND WIRENUTS BY THOMAS AND BETTS (OR EQUAL). LUGS AND WIRENUTS SHALL BE RATED FOR OPERATION AT NO LESS THAN 75°C.
- ALL ELECTRICAL COMPONENTS SHALL BE CLEARLY LABELED WITH ENGRAVED LAMINATED PLASTIC LABELS. ALL EQUIPMENT SHALL BE LABELED WITH THEIR VOLTAGE RATING, PHASE CONFIGURATION, WIRE CONFIGURATION, POWER OR AMPACITY RATING AND BRANCH CIRCUIT ID NUMBERS (PANELBOARD AND CIRCUIT IDENTIFICATION).
- 7. ALL CONDUIT RUN ABOVE GROUND OR EXPOSED SHALL BE RIGID STEEL.
- CABINETS, BOXES AND WIREWAYS SHALL BE LISTED OR LABELED FOR ELECTRICAL USE IN ACCORDANCE WITH NEMA, UL, ANSI/IEEE AND CEC.
- PROVIDE NECESSARY TAGGING ON THE BREAKERS CARLES AND DISTRIBUTION PANELS N ACCORDANCE WITH APPLICABLE CODES AND STANDARDS TO SAFEGUARD LIFE AND
- ALL ELECTRODE SYSTEMS (INCLUDING TELECOMMUNICATION, RADIO, LIGHTNING PROTECTION AND AC POWER) SHALL BE BONDED TOGETHER AT OR BELOW GRADE BY TWO OR MORE COPPER BONDING CONDUCTORS IN ACCORDANCE WITH THE CEC.
- PERFORM IFFE FALL-OF-POTENTIAL RESISTANCE TO FARTH TESTING (PER IFFE 1100 PERFORM IEEE FALL—OF—POTAINER RESISTANCE TO EARTH TESTING FER TEEE THOU AND 81) FOR NEW GROUND ELECTRODE SYSTEMS. THE CONTRACTOR SHALL FURNISH AND INSTALL SUPPLEMENTAL GROUND ELECTRODES AS NEEDED TO ACHIEVE A TEST RESULT OF 5 OHMS OR LESS.
- METAL RACEWAY SHALL NOT BE USED AS THE CEC REQUIRED EQUIPMENT GROUND CONDUCTOR. STRANDED COPPER CONDUCTORS WITH GREEN INSULATION SIZED IN ACCORDANCE WITH THE CEC SHALL BE FURNISHED AND INSTALLED WITH THE POWER CIRCUITS TO FQUIPMENT.
- 13. EXPOSED GROUND CONNECTIONS SHALL BE MADE WITH COMPRESSION CONNECTORS WHICH ARE THEN BOLTED TO EQUIPMENT USING STAINLESS STEEL HARDWARE. INSTALLATION TORQUE SHALL BE PER MANUFACTURER'S REQUIREMENTS.
- PROVIDE SUPPORTING DEVICES FOR ALL ELECTRICAL EQUIPMENT, FIXTURES, BOXES, PANEL, FIC., SUPPORT LUMINARIES FROM UNDERSIDE OF STRUCTURAL CELIAGO, EQUIPMENT SHALL BE BRACED TO WITHSTAND HORIZONTAL FORCES IN ACCORDANCE WITH STATE AND LOCAL CODE REQUIREMENTS. PROVIDE PRIOR ALIGNMENT AND LEVELING OF ALL DEVICES AND FIXTURES.

POLE CONSTRUCTION NOTES:

- METER SHALL NOT FACE THE STREET, ALLEY, OR PROPERTY SIDE OF THE POLE.
- METER BASE AND DISCONNECT SHALL BE BONDED TO A SEPARATE GROUND FROM THE POLE GROUND WITH CONDUCTOR HAVING A CURRENT CAPACITY THAN NO LESS THAN #6 SOLID COPPER CONDUCTOR.
- 3. EQUIPMENT CANNOT OVERHANG THE ROADWAY
- 4. VERIFY AND RECORD ALL CHANGES AND FOOTAGES IN FIELD ON THE FINAL AS-BUILT DRAWINGS.
- 5. GROUNDS ARE TO BE TESTED: REQUIRES 5 OHMS OR LESS RESISTANCE.
- 6. ALL LANDSCAPING TO BE RESTORED TO ORIGINAL CONDITION. 7. NOTIFY PROPERTY OWNER BEFORE WORKING ON OR AROUND PRIVATE PROPERTY.
- 8. OBTAIN SPECIAL PERMITS AND PAY FEES AS REQUIRED WHEN WORKING ON CITY AND
- 9. MAINTAIN 36" MINIMUM COVER IN PARKWAY.
- 10. MAINTAIN 30" MINIMUM COVER BELOW GUTTER GRADE ON SURFACE STREETS.
- 11. CONDUITS MAY BE MOUNTED DIRECTLY TO THE POLE OR U-GUARD MAY BE USED IF THE POLE IS WITHIN 15" OF A BUCKET TRUCK ACCESSIBLE PAVED ROAD. IF NOT ACCESSIBLE AND THE CONDUIT IS GREATER THAN 1-1/2", THE CONDUIT IS OF BE MOUNTED WITH A STANDOFF BRACKET THAT PROVIDES 7" CLEARANCE FROM THE POLE TO THE CONDUIT.
- 12. CONTRACTOR TO PROVIDE MOUNTS OR ADDITIONAL HARDWARE IF REQUIRED FOR INSTALLATION OF PROPOSED ANTENNAS.

13. <u>CONDUIT REQUIREMENTS:</u>
UNDERGROUND — SCHEDULE 40 PVC OR BETTER
RISERS — SCHEDULE 80 PVC WITH FIRST 10' ABOVE GROUND LEVEL TO BE RGS FOR PROTECTION PURPOSES. ALL CONDUITS WILL BE MANDRELED AND EQUIPPED WITH 3/8" PULL ROPE AND MEASURE TAPE IF REQUIRED.

GROUNDING NOTES

- ALL DETAILS ARE SHOWN IN GENERAL TERMS. ACTUAL GROUNDING INSTALLATION REQUIREMENTS AND CONSTRUCTION SHALL BE ACCORDING TO SITE CONDITIONS.
- ALL GROUNDING CONDUCTORS: #2 AWG SOLID BARE TINNED COPPER WIRE UNLESS OTHERWISE NOTED.
- GROUND BAR LOCATED IN BASE OF FOUIPMENT WILL BE PROVIDED. FURNISHED AND INSTALLED BY THE VENDOR
- ALL BELOW GRADE CONNECTIONS: EXOTHERMIC WELD TYPE, ABOVE GRADE CONNECTIONS: MECHANICAL/ CONNECTIONS U.N.O.
- INSTALL GROUND CONDUCTORS AND GROUND ROD MINIMUM OF 1'-0" FROM EQUIPMENT CONCRETE SLAB, SPREAD FOOTING, OR FENCE.
- ALL GROUNDING INSTALLATIONS AND CONNECTIONS SHALL BE MADE BY ELECTRICAL
- ALL GROUNDING FOR ANTENNAS SHALL BE CONNECTED SO THAT IT WILL BY-PASS MAIN BUSS BAR.
- USE SEPARATE HOLES FOR GROUNDING AT BUSS BAR. NO "DOUBLE-UP" OR
- NO LB'S ALLOWED ON GROUNDING.
- PROVIDE STAINLESS STEEL CLAMP AND BRASS TAGS ON ANY COAX AT ANTENNAS AND RADIOS.
- ALL ELECTRICAL AND GROUNDING AT THE CELL SITE SHALL COMPLY WITH THE CALIFORNIA ELECTRICAL CODE (CEC).
- EXOTHERMIC WELDING IS REQUIRED FOR GROUNDING BELOW GRADE CONNECTIONS
- MECHANICAL, ABOVE GRADE CONNECTIONS MAY BE MADE USING COMPRESSION TYPE-2 HOLES. LONG BARREL LUGS OR DOUBLE CRIMP CLAMP "C" CLAMP. THE COPPER CABLES SHALL BE COATED WITH ANTIOXIDANT (COPPER SHIELD) BEFORE MAKING THE CONNECTIONS. THE MANUFACTURER'S TORQUE RECOMMENDATIONS ON THE BOLT ASSEMBLY TO SECURE CONNECTIONS SHALL BE FOLLOWED. ALL TWO HOLE LONG BARREL LUGS SHALL HAVE VIEW PORTS TO ENSURE PROPER
- PROVIDE PVC SLEEVES FOR GROUNDING CONDUCTORS AS NEEDED.
- 15. GROUND ANTENNA BASES, FRAMES, CABLE RACKS AND OTHER METALLIC COMPONENTS WITH #2 GROUNDING CONDUCTORS AND CONNECT TO INSULATED SURFACE MOUNTED GROUND BARS. CONNECTION DETAILS SHALL FOLLOW MANUFACTURER'S SPECIFICATIONS FOR GROUNDING
- 16. PERFORM IEEE FALL-OF-POTENTIAL RESISTANCE TO EARTH TESTING (PER IEEE 1100 AND 81) FOR NEW GROUND ELECTRODE SYSTEMS. THE SUBCONTRACTOR SHALL FURNISH AND INSTALL SUPPLEMENTAL GROUND ELECTRODES AS NEEDED TO ACHIEVE A TEST RESULT OF 5 OHMS OR LESS.
- 17. SURFACES TO BE CONNECTED TO GROUND CONDUCTORS SHALL BE CLEANED TO A BRIGHT SURFACE AT ALL CONNECTIONS.

18 GROUND REQUIREMENTS:

GROUND REQUIREMENTS:
5/8" SS, COPPER CLAD GROUNDING ROD—10' LENGTH
GROUND TESTED AT 5 OHMS OR LESS
#2 GROUND WIRE, SOLID, TINNED

HARDWOOD MOLDING, STAPLED TO POLE EVERY 2'-0" AND AT EACH END GROUND RODS MUST BE 24" FROM POLE AND THE TOP OF ROD MUST BE BELOW GRADE LEVEL PER PLAN DETAILS.

LEGEND SYMBOLS:

GROUNDING WIRE, DASHED LINE

INDICATES UNDERGROUND DC POWER LINE, DASHED INDICATES UNDERGROUND

TELEPHONE LINE, DASHED LINE INDICATES UNDERGROUND COAXIAL CABLE, DASHED LINE

NDICATES UNDERGROUND FIBER CABLE, DASHED LINE

INDICATES UNDERGROUND

DETAIL REFERENCE DETAIL NO. 2 ON SHEET E3

 \otimes GROUND ROD \boxtimes GROUND ROD WITH ACCESS

 $\frac{2}{E3}$

AC POWER LINE, DASHED

CIRCUIT BREAKER

FUSE

M UTILITY METER

■ DUPLEX RECEPTACLE WITH GFCI IN WEATHERPROOF ENCLOSURE

CLAMP OR DOUBLE HOLE LUG TYPE GROUND CONNECTION

EXOTHERMIC CONNECTION TO

DISCONNECT SWITCH


- . ALL CONDUIT ROUTING IS SCHEMATIC. CONTRACTOR SHALL INSTALL CONDUITS SO THAT ACCESS TO EQUIPMENT IS NOT IMPEDED.
- 2 CONDUIT SIZES INDICATED ON THE DRAWINGS ARE NOT NECESSARILY BASED ON THE MINIMUM CONDUIT SIZES INDICATED ON THE DRAWINGS ARE NOT NECESSARILE BASED ON THE MINIMUM SIZE ALLOWED BY THE CEC AND MAY BE PURPOSELY OVERSIZED FOR FUTURE CONDUCTORS OR TO AVOID CONDUCTOR HEATING. CONDUIT SIZES NOT CALLED OUT ON THE DRAWINGS SHALL BE SIZED BY THE CONTRACTOR, BASED ON THE ACTUAL NUMBER OF CONDUCTORS TO BE INSTALLED, USING THE CEC AS A GUIDE. IN NO CASE SHALL CONDUIT SIZES BE SMALLER THAN 1/2'
- 3. THE CONTRACTOR SHALL PROVIDE AND INSTALL ALL JUNCTION AND PULLBOXES REQUIRED FOR THE INSTALLATION OF ELECTRICAL DEVICES AND EQUIPMENT, WHETHER OR NOT SPECIFICALLY INDICATED ON THE PLANS. SIZING OF THESE BOXES SHALL BE PER THE CEC.
- ALL ELECTRICAL WORK SHALL BE CONSTRUCTED IN ACCORDANCE WITH PROJECT SPECIFICATIONS AND ALL APPLICABLE LOCAL CODES AND REGULATIONS.
- UTILITY ELECTRICAL SERVICE WILL BE 120/240 VOLTS OR 120/208 VOLTS, SINGLE PHASE, MIN. 30 AMPS CAPACITY. SEE PLANS FOR DETAILS.
- 6 PROJECT CONDITIONS MAY REQUIRE REARRANGEMENT OF ELECTRICAL WORK. THE SUBCONTRACTOR SHALL INDICATE SUCH CHANGES ON THE AS-BUILT DRAWINGS. WHERE CHANGES REQUIRE ALTERNATE METHODS TO THOSE SPECIFIED IN THE PLANS, THE SUBCONTRACTOR SHALL REQUEST APPROVAL. AND SHALL NOT PROCEED UNTIL APPROVAL IS OBTAINED.
- CONTRACTOR SHALL PAINT ALL EXPOSED EXTERIOR CONDUITS AND JUNCTION BOXES TO MATCH EXISTING FINISH ON WHICH THEY ARE ATTACHED.
- 8 FIRER TRUNKS AND/OR BACKHAUL LENGTHS AND ROLLTES ARE NOT VERIFIED DURING THE SITE WALK CONTRACTOR TO VERIFY ACTUAL ROUTE AND TRUNK LENGTH DURING PRE-CONSTRUCTION WALF
- O. CONTRACTOR SHALL COORDINATE WITH UTILITY COMPANY FOR FINAL AND EXACT WORK/MATERIALS REQUIREMENTS AND CONSTRUCT TO UTILITY ENGINEERING PLANS AND SPECIFICATIONS ONLY WHERE APPLICABLE PER PROJECT SCOPE OF WORK.
- 10. CONTRACTOR SHALL FURNISH AND INSTALL CONDUIT, PULL WIRES, CABLE PULL BOXES, CONCRETE ENCASEMENT OF CONDUIT, TRANSFORMER PAD, BARRIERS, POLE RISER TRENCHING, BACK FILL, AND UTILITY FEES, AND INCLUDE REQUIREMENTS IN SCOPE.
- 11. TEST ALL ELECTRICAL & GROUNDING SYSTEMS (CONTINUITY, MEGGER, ETC.) UPON COMPLETION OF INSTALLATION PRIOR TO FINALIZING WORK.
- CONTRACTOR TO VERIFY ALL CONDUIT ROUTING FOR, (N) VZW METER AND (N) GROUND ROD LOCATION WITH LANDLORD AND UTILITY COORDINATOR IN FIELD.
- 13. CONDUIT REQUIREMENTS (TYP., U.N.O.): UNDERGROUND: PVC (SCHED. 40 OR 80). INDOOR: EMT (RGS IN TRAFFIC AREAS). OUTDOOR: (ABOVE GRADE) RGS.

10 (N) POLE-MOUNTED

14. PROVIDE A MIN. 36" WORK CLEARANCE IN FRONT OF PANELS/ ELECTRICAL EQUIPMENT.

BREAKER LEGEND							
CIRCUIT #	DESCRIPTION	ACB /	#POLES				
1	PSU #1	15A 1P	10A 2P				
2	PSU #2	15A 1P	10A 2P				
3	SPARE	10A 1P	-				
,	SPAIL	TUA IF	-				
4	SPARE	10A 1P	-				
*	SPARE	TOA IF	_				

SINGLE LINE DIAGRAM

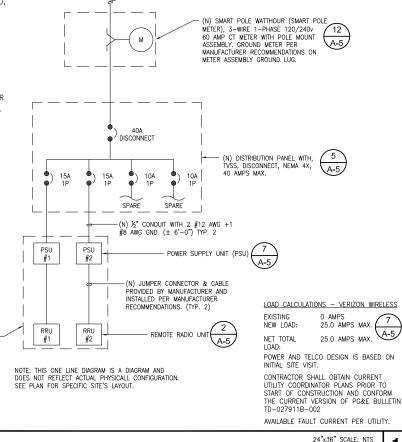

PG&E REQUIREMENTS FOR

(N) OVER HEAD SERVICE

PG&E POWER SOURCE 120 VAC, 1PHASE 40 AMPS MIN. (FROM PG&E SERVICE DROP ON POLE) A-3

11"x17" SCALE: NTS








C 05/17/2019	SETBACK ADDED				
B 03/08/2019	100% CD'S				
A 02/01/2019	90% CD'S SET				
REV DATE	DESCRIPTION				
ISSUED DATE:					

MAY 17, 2019

ISSUED-FOR:

100% CD SET

LICENSURE:

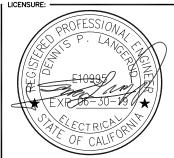

SOUTH CARMEL 005 LOCATION CODE: 428220 IFO MISSION ST. 2 SW 12TH AVE.

CARMEL, CA 93923

DRAWN RY SAG


CHECKED BY SHEET-TITLE:

ELECTRICAL NOTES AND SINGLE LINE DIAGRAM

SHEET NUMBER:

E-1

24"x36" SCALE: NTS **NOT USED** 2 11"x17" SCALE: NTS

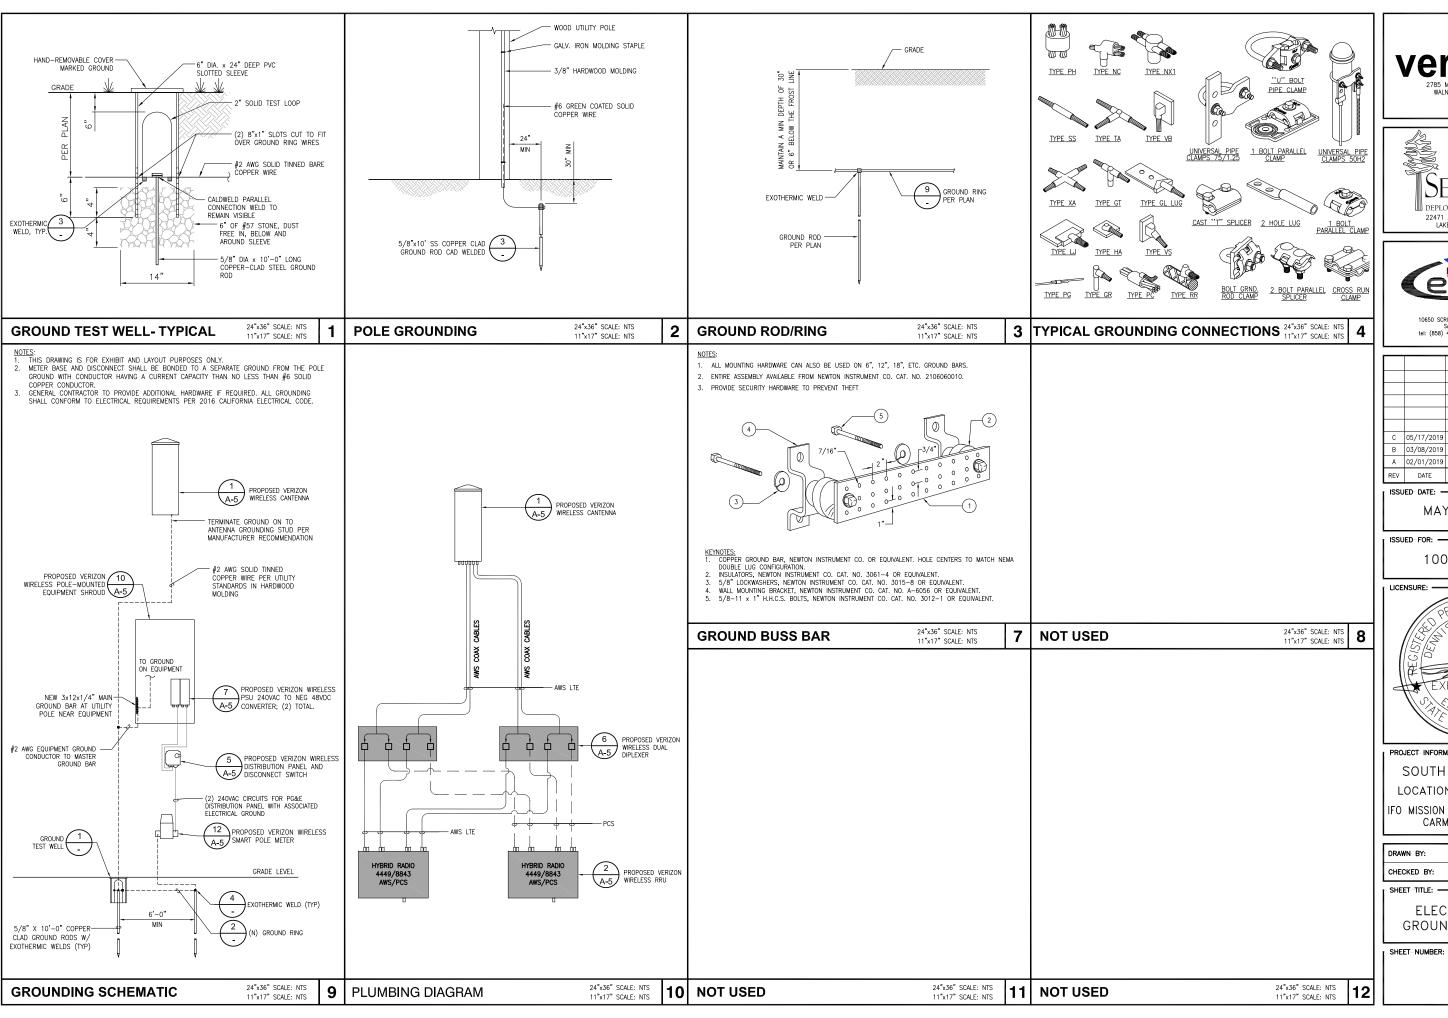







П			
П			
П			
П	С	05/17/2019	SETBACK ADDED
П	В	03/08/2019	
	Α	02/01/2019	90% CD'S SET


ISSUED DATE:

MAY 17, 2019

DESCRIPTION

ISSUED FOR: -

100% CD SET

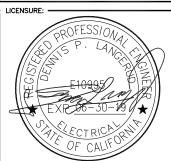

SOUTH CARMEL 005 LOCATION CODE: 428220

IFO MISSION ST. 2 SW 12TH AVE. CARMEL, CA 93923

DRAWN BY: CHECKED BY:

SHEET-TITLE:

ELECTRICAL AND GROUNDING DETAILS

E-2