



## LEGEND

P⊕ 10 W = WALL MOUNTED DOWNLIGHT LIGHT FIXTURE 10 WATTS

EXTERIOR LIGHTING PLAN

1-25 WATTS MAX. WITH PHOTO SENSOR MINKA-LAVERY BAYTREE LANE OUTDOOR FIXTURES

IXISTIN SHED EXT. WALL MOUNT LIGHT FIXTURE

SHAPED 8X8
CEDAR POST
FENCE

13" CUT-OUTS
EVERY 3RD PLANK

ENTRY GATE AND FENCE

(E) WOOD DECK SERVICE YARD GARAGE PROPOSED RESIDENCE 10 / NI. ENTRY PATH PROPERTY COURTYARD ENTRY COURT FIREPIT

JUN A. SILLANO, AIA

ARCHITECTURE + PLANNING + INTERIOR DESI

721 LIGHTHOUSE AVE PACIFIC GROVE CA 93950

DISCLAIMER:



CTA

1/2"=1'-0"

PROJECT/CLIENT:

DONOVAN-HUANG RESIDENCE

PROJECT ADDRESS:

MONTE VERDE ST. 3SW OF 10TH AVE. CARMEL BY-THE-SEA,

APN: 070-185-003

DATE: NOVEMBER 01, 2018
CLIENT REVIEW

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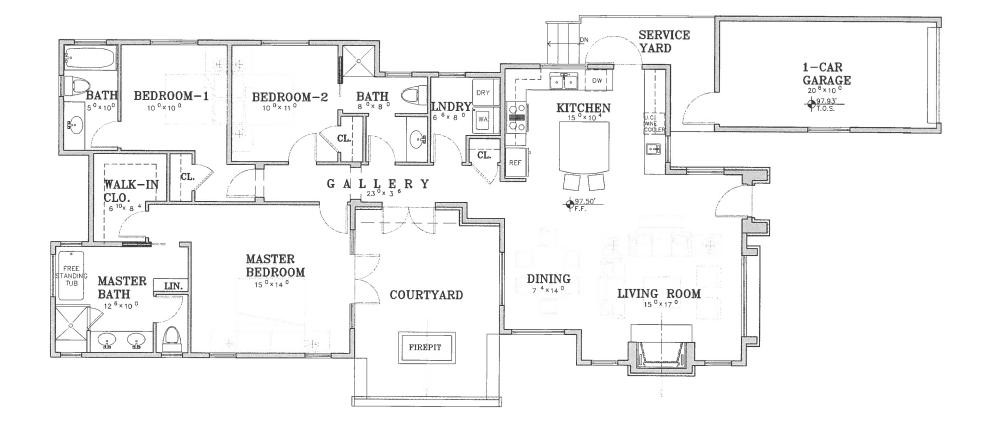
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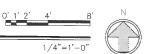
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EXTERIOR LIGHTING PLAN

SHEET NO.

A1.1







721 LIGHTHOUSE AVE PACIFI**C** GROVE CA. **93**950

DISCLAIMER:

STAMPS:

PROJECT/CLIENT:

DONOVAN-HUANG RESIDENCE

PROJECT ADDRESS:

MONTE VERDE ST. 3SW OF 10TH AVE. CARMEL BY-THE-SEA,

DATE: NOVEMBER 01, 2018


CLIENT REVIEW

REVISIONS:

FLOOR PLAN

SHEET NO.

A2.0

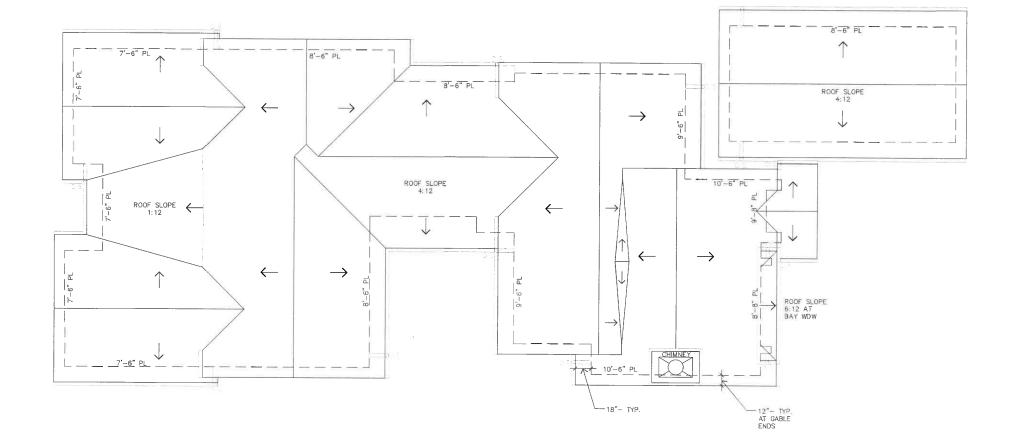

ROOF PLAN

0'.1'.2'.4'.8'.N



721 LIGHTHOUSE AVE PACIFIC GROVE CA. 93950

DISCLAIMER

DISCLAMER:

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STAMPS:

PROJECT/CLIENT:

DONOVAN-HUANG RESIDENCE

PROJECT ADDRESS:

MONTE VERDE ST.
3SW OF 10TH AVE.
CARMEL
BY-THE-SEA,

DATE: NOVEMBER 01, 2018
CLIENT REVIEW

REVISIONS:


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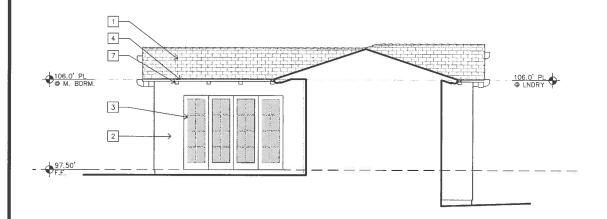
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ROOF PLAN

SHEET NO.

A5.0






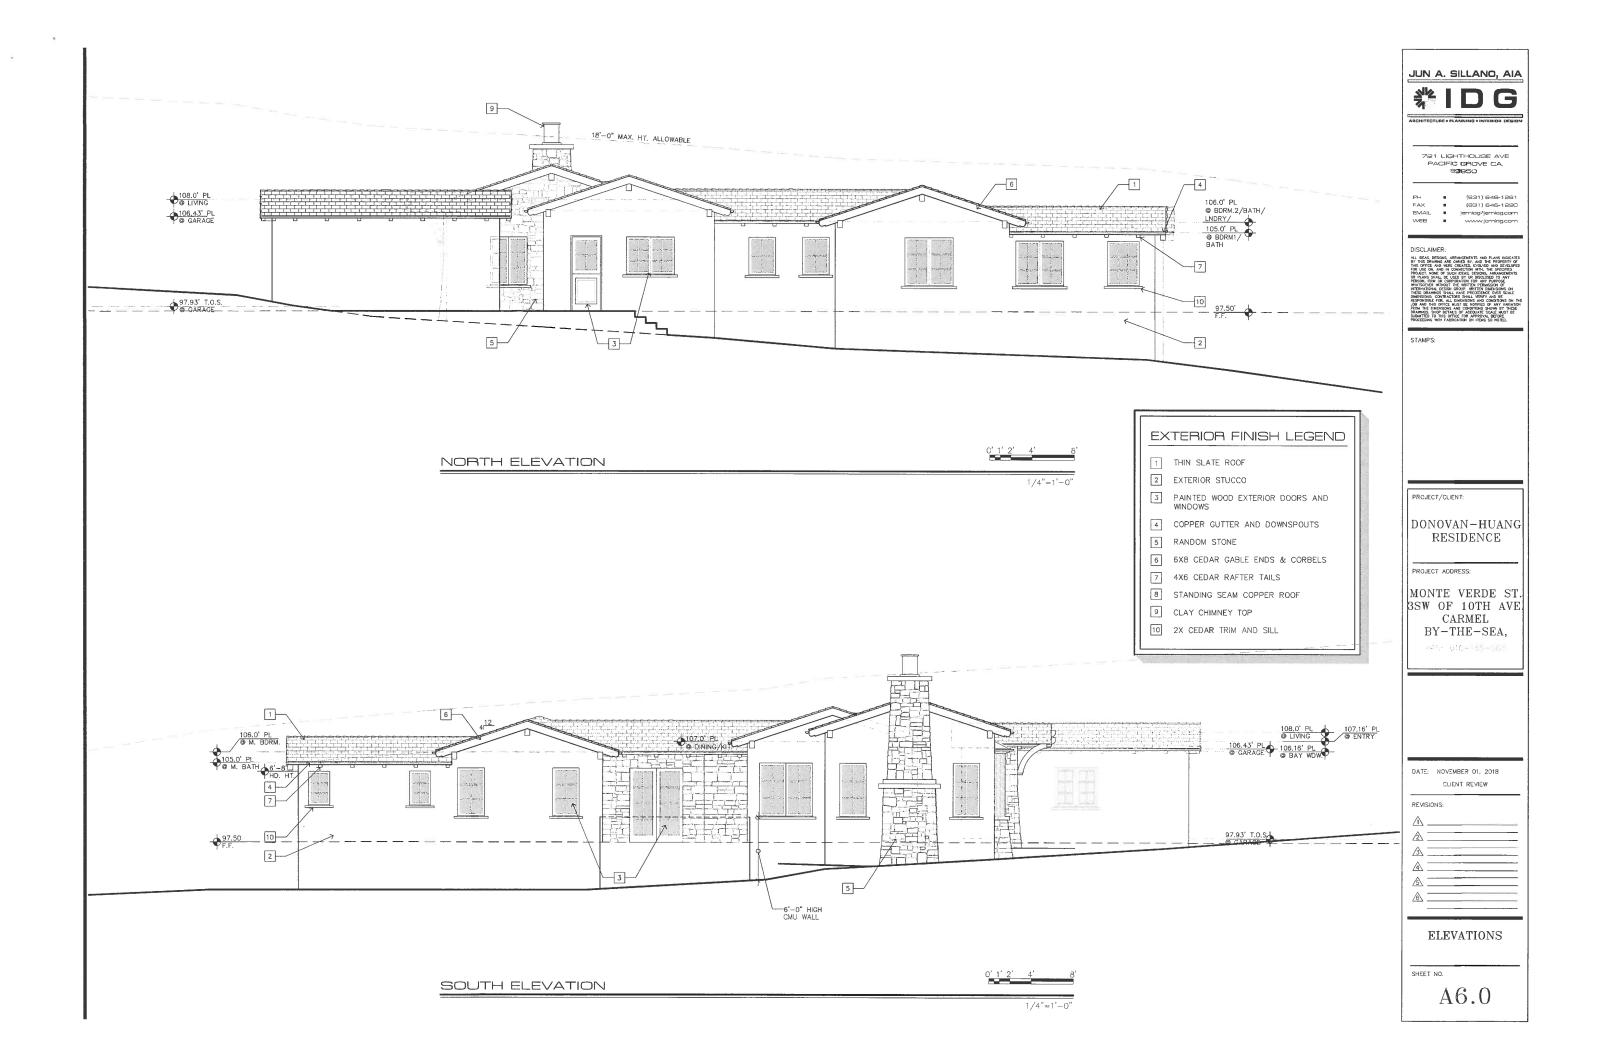






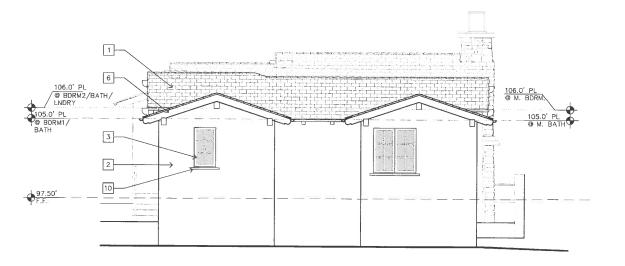

WEST ELEVATION

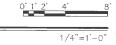

EXTERIOR FINISH LEGEND

PAINTED WOOD EXTERIOR DOORS AND WINDOWS
 COPPER GUTTER AND DOWNSPOUTS

6 6X8 CEDAR GABLE ENDS & CORBELS

7 4X6 CEDAR RAFTER TAILS 8 STANDING SEAM COPPER ROOF

9 CLAY CHIMNEY TOP

10 2X CEDAR TRIM AND SILL

1 THIN SLATE ROOF
2 EXTERIOR STUCCO

5 RANDOM STONE

JUN A. SILLANO, AIA

# ID G

721 LIGHTHOUSE AVE PACIFIC GROVE CA. 93950

DISCLAIMER

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STAMPS:

PROJECT/CLIENT:

DONOVAN-HUANG RESIDENCE

PROJECT ADDRESS:

MONTE VERDE ST. 3SW OF 10TH AVE. CARMEL BY-THE-SEA,

AFA: 016-135-1603

DATE: NOVEMBER 01, 2018

CLIENT REVIEW

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ELEVATIONS

SHEET NO.

A6.1

					L	000F	4 50		JULE		
Door	Door S	ize (Fi	nished)			Glass		Finish			
No.	Width	Height	Thick	Material	Core	Туре	Tempered	Interior	Exterior	Action	Remarks
MAIN	LEVEL										
1	3'-0"	8'-0"	2-1/4"	WD	SOLID			PAINTED	PAINTED	SWING	AT ENTRY;; CUSTOM DR.; ARCHTOP.
2	PR2'-6"	7'-0"	1-3/4"	WD	SOLID	DBLPANE	YES	PAINTED	PAINTED	SWING	AT GALLERY; DBL. FRENCH DR.
3	PR2'~4"	7'-0"	1-3/4"	WD	SOLID	DBLPANE	YES	PAINTED	PAINTED	SWING	DBL. FRENCH DR.;
4	2'-8"	7'-0"	1-3/4"	WD	SOLID	DBLPANE	YES	PAINTED	PAINTED	SWING	AT KITCHEN; DUTCH DR.
5	3'-0"	7'~0"	1-3/4"	WD	SOLID	SNGLPANE	YES	PAINTED	PAINTED	SWING	AT GARAGE
6	9'-0"	7'-0"	PER MANUF.	WD	SOLID			PAINTED	PAINTED	ROLL-UP	AT GARAGE
7	2'-8"	7'-0"	1-3/4"	WD	SOLID			PAINTED	PAINTED	SWING	AT MASTER BEDRM.
8	2'-6"	7'-0"	1-3/4"	WD	SOLID			PAINTED	PAINTED	SWING	AT MASTER W.C.
9	2'-8"	7'-0"	1-3/4"	WD	SOLID			PAINTED	PAINTED	SLIDING	AT MASTER BATH; POCKET DR.
10	2'-6"	7'-0"	1-3/4"	WD	SOLID			PAINTED	PAINTED	SWING	AT WALK-IN CLO.
11	2'-6"	7'-0"	1-3/4"	WD	SOLID			PAINTED	PAINTED	SWING	AT BEDRM. 1 BATH
12	2'-6"	7'-0"	1-3/4"	WD	SOLID			PAINTED	PAINTED	SWING	AT BEDRM. 1 CLO.
13	2'-8"	7'-0"	1-3/4"	WD	SOLID			PAINTED	PAINTED	SWING	AT BEDRM. 1/ GALLERY
14	2'-8"	7'-0"	1-3/4"	WD	SOLID			PAINTED	PAINTED	SWING	AT BEDRM. 2
15	2'-6"	7'-0"	1-3/4"	WD	SOLID			PAINTED	PAINTED	SWING	AT CLO. IN BDRM.2
16	2'-6"	7'-0"	1-3/4"	WD	SOLID			PAINTED	PAINTED	SLIDING	AT BATH/ BDRM. 2; POCKET DR.
17	2'-6"	7'-0"	1-3/4"	WD	SOLID			PAINTED	PAINTED	SWING	AT BATH/ GALLERY
18	2'-6"	7'-0"	1-3/4"	WD	SOLID			PAINTED	PAINTED	SWING	AT LAUNDRY; LOUVERED DR.; SEE KEYNOTE #29 ON SHT.A2.0
19	2'-6"	7'-0"	1-3/4"	WD	SOLID			PAINTED	PAINTED	SWING	AT CLO. IN GALLERY
20-22	NOT USED										

Wdw.	Window	Size (F	inished)			Glass		Finish		
No.	Width	Height	Head Height	Туре	Material	Туре	Tempered	Interior	Exterior	Remarks
MAIN	LEVEL									
1	7'-6"	5'-6"	8'-0"	CSMNT-FIXED-CSMNT	WD	DBLPANE	YES	PAINTED	PAINTED	3 EQUAL PANELS; WITH UPPER DIVIDED LIGHTS; SEE ELEV.
2	2'-6'	5'-0"	7'-6"	CASEMENT	WD	DBLPANE		PAINTED	PAINTED	
3	2'-6'	5'-0"	7'-6"	CASEMENT	WD	DBLPANE		PAINTED	PAINTED	
4	5'-0"	5'-0"	7'-6"	DBL.CASEMENT	WD	DBLPANE		PAINTED	PAINTED	
5	5'-0"	5'-0"	7'-6"	DBL.CASEMENT	WD	DBLPANE		PAINTED	PAINTED	
6	2'-6"	4'-6"	7'-0"	CASEMENT	WD	DBLPANE		PAINTED	PAINTED	
7	2'-6"	4'-6"	7'-0"	CASEMENT	WD	DBLPANE		PAINTED	PAINTED	
8	2'-0"	3'-0"	6'-8"	CASEMENT	WD	DBLPANE		PAINTED	PAINTED	
9	2'-0"	3'-0"	6'-8"	CASEMENT	WD	DBLPANE	YES	PAINTED	PAINTED	
10	4'-0"	4'-2"	6'-8"	CASEMENT	WD	DBLPANE	YES	PAINTED	PAINTED	
11	2'-0"	4'-2"	6'-8"	CASEMENT	WD	DBLPANE	YES	PAINTED	PAINTED	
12	2'-0"	3-8"	6'-8"	CASEMENT	WD	DBLPANE	YES	PAINTED	PAINTED	
13	3'-0"	4'-2"	6'-8"	FIXED	WD	DBLPANE	NO	PAINTED	PAINTED	
14	4'-6"	4'-2"	6'-8"	DBL. CASEMENT	WD	DBLPANE	NO	PAINTED	PAINTED	EGRESS WDW; AT BDRM. 1
15	4'-6"	4'-6"	7'-0"	DBL. CASEMENT	WD	DBLPANE	NO	PAINTED	PAINTED	EGRESS WDW; AT BDRM. 2
16	2'-6"	3'-6"	7'-0"	CASEMENT	WD	DBLPANE	YES	PAINTED	PAINTED	
17	2'-6"	3'-6"	7'-0"	CASEMENT	WD	DBLPANE		PAINTED	PAINTED	
18	4'-6"	3'-6"	7'-0"	DBL. CASEMENT	WD	DBLPANE	YES	PAINTED	PAINTED	
19	4'-6"	3'-6"	7'-0"	CASEMENT	WD	DBLPANE	YES	PAINTED	PAINTED	
20	3'-6"	4'-6"	7'-0"	DBL. CASEMENT	WD	DBLPANE		PAINTED	PAINTED	
21	4'-0"	3'-8"	6'-8"	DBL. CASEMENT	WD	DBLPANE		PAINTED	PAINTED	

## DOOR NOTES:

ALL GLAZING IN DOORS SHALL BE TEMP. GLASS.

DOOR SIZES SHOWN ARE PROPOSED FINISHED OPENING SIZES. GENERAL CONTRACTOR TO VERIFY MANUFACTURER'S NEAREST STOCK SIZES FOR DESIGNER/OWNER TO REVIEW AND APPROVE.

SPECIALTY DOORS SHALL BE COORDINATED WITH GENERAL CONTRACTOR FOR SITE VERIFICATION AND INSTALLATION.

ALL EXTERIOR DOORS SHALL HAVE A COPPER PAN, 1/2" MAX THRESHOLD, & BRASS HINGES. OUTSWING DOORS SHALL HAVE A 1/2" MAX CHANGE IN ELEVATION TO THE EXTERIOR.

ALL EXPOSED EDGES TO BE SEALED TO PREVENT MOISTURE PENETRATION AND WARPING.

ALL FRENCH DOORS ARE TO HAVE DEAD BOLTS.

CONTRACTOR TO VERIFY ALL ASPECTS OF DOORS WITH OWNER PRIOR TO ORDERING.

## WINDOW NOTES:

ALL CASEMENT WINDOWS USED IN BEDROOMS AS EMERGENCY EGRESS MUST BE "BREAK AWAY" TYPE TO ENSURE COMPLETE OPENABLE AREA FOR ACCESS.

WINDOW DIMENSIONS ARE PROPOSED FINISHED OPENING SIZES. GENERAL CONTRACTOR IS TO VERIFY MANUFACTURER'S NEAREST STOCK SIZES. ALL WINDOW SIZES, SHAPES, COLORS, HARDWARE, SCREENS, GLAZING, ETC. MUST BE APPROVED BY OWNER PRIOR TO ORDERING.

SPECIALTY WINDOWS SHALL BE COORDINATED WITH THE GENERAL CONTRACTOR FOR SITE VERIFICATION AND INSTALLATION.

ALL WINDOWS ARE TO BE DOUBLE GLAZED.

OWNERS TO SPECIFY WHICH WINDOW ARE TO BE LOW "E".

ALL GLAZING SUBJECT TO HUMAN IMPACT SHALL BE TEMPERED GLASS OR WIRE SAFETY GLASS (CBC 2406.3)

GLAZING IN FIXED OR OPERABLE PANELS ADJACENT TO A DOOR WHERE THE NEAREST EXPOSED EDGE OF THE GLAZING IS WITHIN A 24" ARC OF EITHER VERTICAL EDGE OF THE DOOR IN A CLOSED POSITION AND WHERE THE BOTTOM EXPOSED EDGE OF THE GLAZING IS LESS THAN 60" ABOVE THE WALKING SURFACE SHALL BE SAFETY GLASS (CBC 2406.3).

FOR WINDOWS THAT SERVE AS EMERGENCY EGRESS FROM SLEEPING AREAS:

- MINIMUM NET CLEAR OPENABLE DIMENSION OF 24 INCHES IN HEIGHT.

- MINIMUM NET CLEAR OPENABLE DIMENSION OF 20 INCHES IN WIDTH.

- MINIMUM NET CLEAR OPENABLE DIMENSION OF 5.7 SQUARE FEET IN AREA.

- BOTTOM OF SUCH OPENINGS SHALL NOT EXCEED 44 INCHES ABOVE FLOOR

PROJECT/CLIENT:

DONOVAN-HUANG RESIDENCE

JUN A. SILLANO, AIA

721 LIGHTHOUSE AVE PACIFIC GROVE CA. 93950

WEB

DISCLAIMER:

STAMPS:

(831) 646-1261 (831) 646-1290 jemidg@jemidg.com www.jemidg.com

PROJECT ADDRESS:

MONTE VERDE ST. BSW OF 10TH AVE CARMEL BY-THE-SEA,

APN: 010-135-003




DATE: NOVEMBER 01, 2018 PLANNING PACKAGE

12-03-18 DS REVISION

DOOR & WINDOW SCHEDULES

SHEET NO.

A9.0

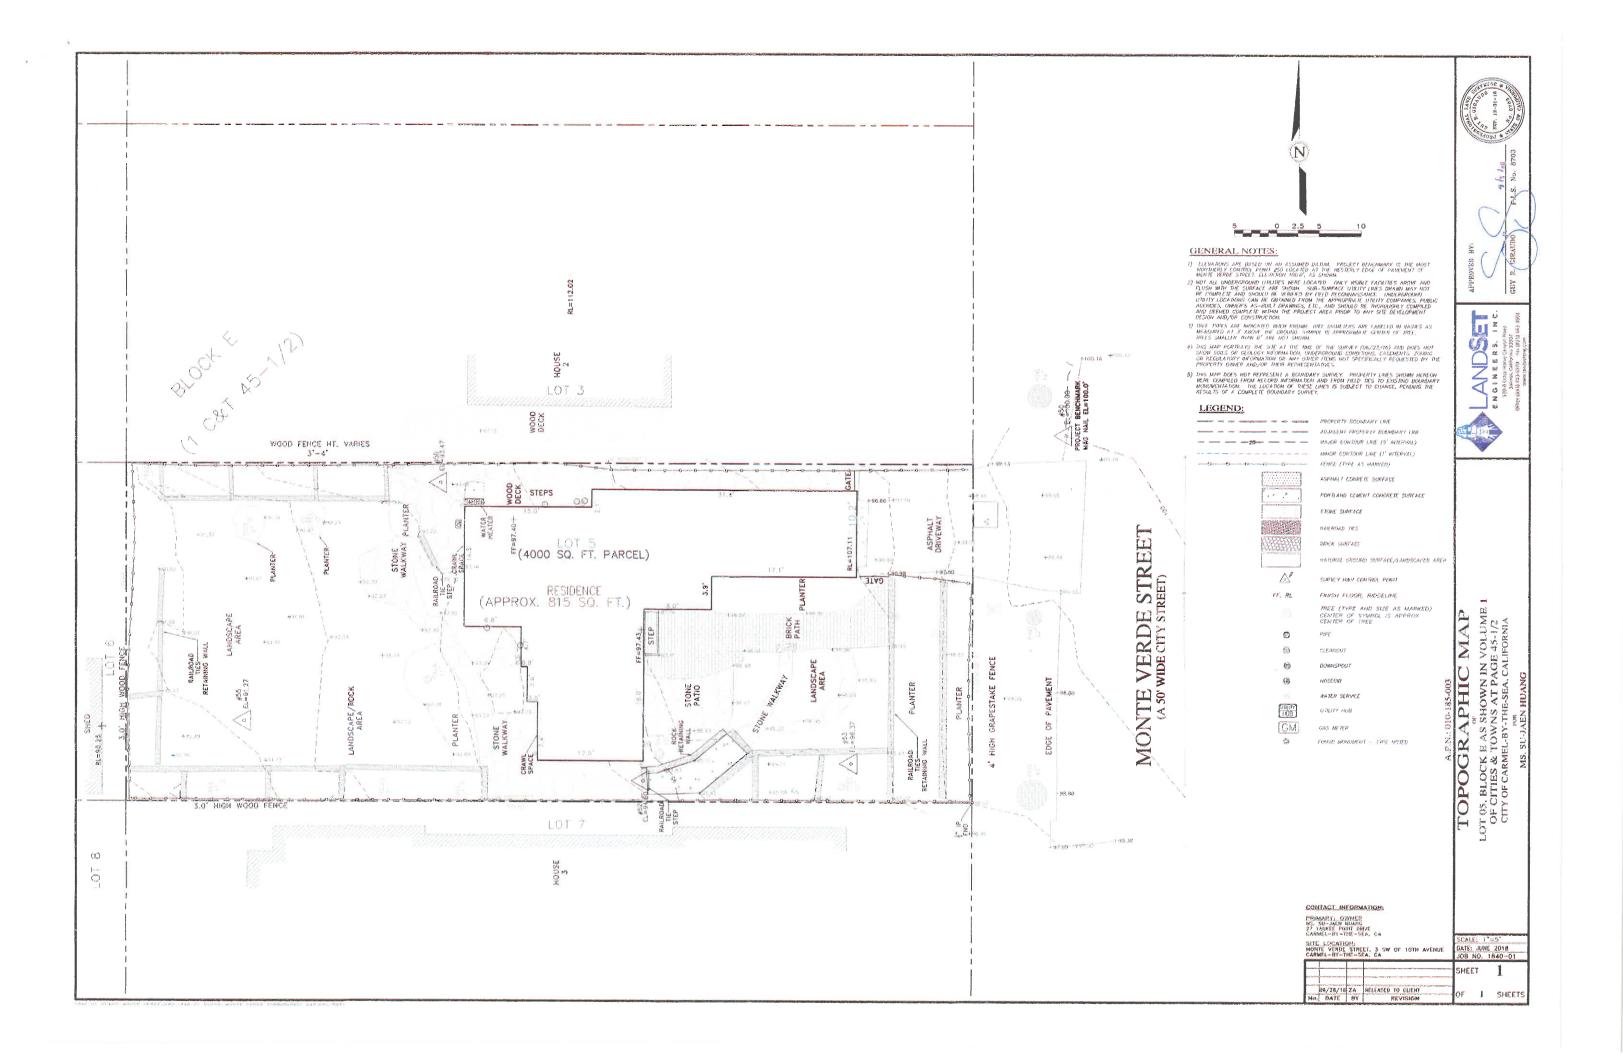

BOTANICAL NAME	COMMON NAME	QUANTITY	SIZE	WUCOLS
Acer palmatum	Japanese Maple	2	15 gal	Med
Agapanthus 'Storm Cloud'	Storm Cloud Agapanthus	8	1 gal	Med
Arctostaphylos edmunsii 'Carmel Sur'	Carmel Sur Manzanita	10	1 gal	Low
Arctostaphylos densitlora 'Howard McMinn'	Howard McMinn Manzanita	9	5 gal	Low
Convolvulus mauritanicus	Ground Morning Glory	7	1 gal	Low
Correa 'Ivory Bells'	Ivory Bells Australian Fuchsia	5	1 gal	Low
Heuchera maxima	Coral Bells	10	1 gal	Med
Limonium perezii	Sea Lavander	11	1 gal	Law
Olea europea Little Ollie'	Little Ollie	4	5 gal	Low
Rosmarinus 'Tuscan Blue'	Tuscan Blue Rosemary	7	5 gal	Low
Salvia leucantha	Mexican Bush Sage	5	1 gal	Low
Teucrium chamaedrys	Germander	16	1 gal	Łow
Woodwardia fimbriata	Giant Chain Fern	16	5 gal	Low
	Acer palmatum Agapanthus 'Storm Cloud' Arctostaphylos edmunsii 'Carmel Sur' Arctostaphylos densiltora 'Howard McMinn' Convolvulus mauritanicus Corres 'Ivory Bells' Heuchera maxima Limonium perezii Olea europea Little Ollie' Rosmarinus 'Tuscan Blue' Salvia leucantha Taucrium chamaedrys	Acer palmatum Japanese Maple Agapanthus 'Storm Cloud' Storm Cloud Agapanthus Arctostaphylos edmunsii 'Carmel Sur' Carmel Sur Manzanita Arctostaphylos densiltora 'Howard McMinn' Howard McMinn Manzanita Convolvulus mauritanicus Ground Morning Glory Corres 'Ivory Bells' Ivory Bells Australian Fuchsia Heuchera maxima Coral Bells Limonium perezii Sea Lavander Olea europea Little Ollie' Little Ollie Rosmarinus 'Tuscan Blue' Tuscan Blue Rosemary Salvia leucantha Mexican Bush Sege Germander	Acer palmatum         Japanese Maple         2           Agapanthus 'Storm Cloud'         Storm Cloud Agapanthus         8           Arctostaphylos edmunsii 'Carmel Sur'         Carmel Sur Manzanita         10           Arctostaphylos densiltora 'Howard McMinn'         Howard McMinn Manzanita         9           Corvotivulus mauritanicus         Ground Morning Glory         7           Correa 'Ivory Bells'         Ivory Bells Australian Fuchsia         5           Heuchera maxima         Coral Bells         10           Limonium perezii         Sea Lavander         11           Olea europea Little Ollie'         Little Ollie         4           Rosmarinus 'Tuscan Blue'         Tuscan Blue Rosemary         7           Salvia leucantha         Mexican Bush Sage         5           Teucrium chamaedrys         Gemander         16	Acer palmatum         Japanese Maple         2         15 gal           Agapanthus 'Storm Cloud'         Storm Cloud Agapanthus         8         1 gal           Arctostaphylos edmunsii 'Carmel Sur'         Carmel Sur Manzanita         10         1 gal           Arctostaphylos densitlora' Howard McMinn'         Howard McMinn Manzanita         9         5 gal           Corvolvulus mauritanicus         Ground Morning Glory         7         1 gal           Correa 'Ivory Bells'         Ivory Bells Australian Fuchsia         5         1 gal           Heuchera maxima         Coral Bells         10         1 gal           Limonium perezii         Saa Lavander         111         1 gal           Olea europea Little Clile'         Little Clile         4         5 gal           Rosmarinus 'Tuscan Blue'         Tuscan Blue Rosemary         7         5 gal           Salvia leucantha         Mexican Bush Sege         5         1 gal           Teucrium chamaedrys         Germander         16         1 gal

## BUILDING DEPARTMENT NOTES:

PERMITS & INSPECTIONS:

THE CONTRACTOR SHALL OBTAIN ALL REQUIRED INSPECTIONS FOR THE WORK AND GIVE THE OWNER TIMELY NOTICE OF INTENT TO EACH INSPECTION.

ALL MATERIAL, WORKMANSHIP AND METHODS OF CONSTRUCTION SHALL CONFORM TO THE APPLICABLE REQUIREMENTS OF THE UBC AND LOCAL BUILDING CODES.

NO POTABLE WATER MAY BE USED FOR COMPACTION OR DUST CONTROL PURPOSES IN CONSTRUCTION ACTIVITIES WHERE THERE IS A REASONABLY AVAILABLE SOURCE OF RECLAIMED WATER.

CONTRACTOR TO USE AUTO SHUT-OFF NOZZLES ON ANY WATER HOSES USED ON THE PROJECT.

LAYOUT NOTES: ANNOTATED DIMENSIONS TO TAKE PRECEDENCE OVER SCALED DRAWINGS.

FIRE SAFETY NOTES: ALL NON IRRIGATED BRUSH TO BE KEPT AT GROUND LEVEL FOR AN AREA OF 50' SURROUNDING THE PROPOSED RESIDENCE.

TREES TO BE CLEARED OF DEAD LIMBS WITHIN A 50' RADIUS OF THE PROPOSED RESIDENCE. ANY TREE LIMBS WITHIN 10' OF A CHIMNEY WILL BE REMOVED.

## XERISCAPE PRACTICES:

- LOW WATER USE, DROUGHT TOLERANT PLANTS
   WATER CONSERVING IRRIGATION TECHNIQUES AND SYSTEMS
   J. DRIP IRRIGATE ALL, PLANT MATERIAL
   INSTALLATION OF RAIN SENSOR

## PLANTING NOTES:

ALL LANDSCAPE AREAS SHALL BE CONTINUOUSLY MAINTAINED IN A LITTER FREE, WEED FREE CONDITION AND ALL PLANT MATERIAL SHALL BE CONTINUOUSLY MAINTAINED IN A HEALTHY GROWING CONDITION.

STAKING.
STAKING SHALL BE PROVIDED FOR TREES AND SHRUBS AS NEEDED.
TIES TO BE LOCATED AND SIZED TO ALLOW FOR EXPANSION AND

MULCHING: SPREAD 3\* OF MULCH OVER ALL EXPOSED PLANTING AREAS

COMPOST MINIMUM OF 4 CUBIC YARDS PER 1,000SQFT OF PERMEABLE AREA TO A DEPTH OF  $6^{\circ}$ 

STAGING: WHEN STAGING PLANT MATERIAL ON SITE INSTALL A TEMPORARY DRIP LINE AS NEEDED.

SOIL AMENDMENT TO BE ADDED TO PLANTED ARE AS NEEDED FOR PLANT MATERIAL

0' 1' 2' 4'

## SCOPE OF WORK:

THIS IS NEW LANDSCAPE INSTALLTION WITH A NEW LOW FLOW DRIP IRRIGATION SYSTEM. LANDSCAPE DESIGNED TO USE ALL NATIVE AND/OR DROUGHT TOLERANT PLANTING.

## PROJECT INFORMATION:

OWNER

DONOVAN-HUANG

SITE

MONTE VERDE ST., 3 SW OF 10TH AVE. CARMEL-BY-THE-SEA, CA

TOPOGRAPHY SLOPED

TREE REPLACEMENT PLAN TO MEET MONTEREY COUNTY REQUIERMENTS TREE REMOVAL

010-185-003

SOILS REPORT SEE SOILS REPORT GRADING

### LANDSCAPING STATEMENT:

I PATRICK WILSON CERTIFY THAT THIS LANDSCAPING AND IRRIGATION PLAN COMPLIES WITH ALL CITY OF CARMEL'S LANDSCAPING AND ANALYS. REQUIREMENTS INCLUDING USE OF NATIVE, DROUGHT TOLERANT, NON-INVASVE SPECIES, UNITED TURF; AND LOW-FLOW, WATER CONSERVING IRRIGATION FIXTURES

I HAVE COMPLIED WITH THE CRITERIA OF THE ORDINANCE AND APPLIED THEM FOR THE EFFICIENT USE OF WATER IN THE LANDSCAPE DESIGN PLAN.

Donovan - Huang Residence Monte Verde St. 3SW of 10th Ave. Carmel By-The-Sea, CA 93921

APN: 010-185-003

MISSION

LANDSCAPING

P.O. BOX 875

PACIFIC GROVE

CALIFORNIA 93950 P 831 373 8293

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www.missionlandscaping.com

email: missionlandscaping@me.com Landscape & General Contractors C27 & B 392291 Landscape Architecture CA Lic #5806




Planting Plan

10/23/2018 As Shown DW

L1.0

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SYSTEM DESIGNED TO PREVENT LOW HEAD DRAINAGE AND NO OVERSPRAY

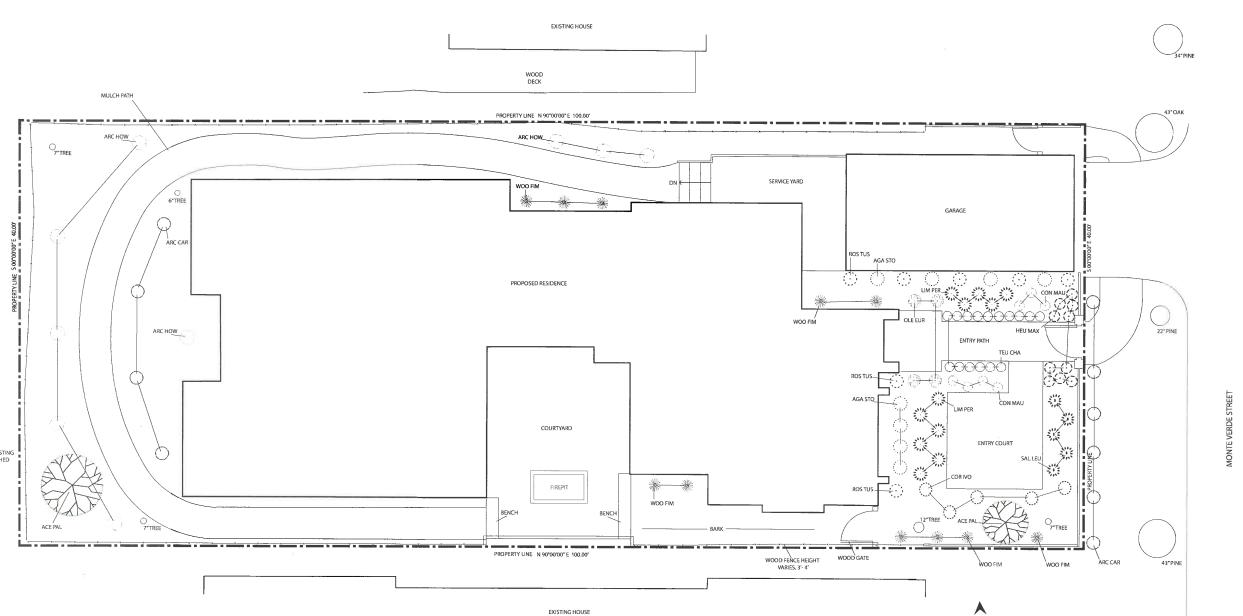IRRIGATION LAID OUT TO CONFORM TO HYDROZONES INDICATED ON LANDSCAPE PLAN

SYSTEM DESIGNED TO ACHIEVE MINIMUM IRRIGATION EFFICIENCY OF .75 FOR OVERHEAD SPRAY AND .81 FOR DRIP ZONES

SYSTEM USES LOW VOLUME IRRIGATION IN MULCHED PLANTING AREAS

SYSTEM HAS MATCHED PRECIPITATION RATES FOR HEAD AND EMISSION DEVICES

THE IRRIGATION HEADS ARE LAID OUT FOR OPTIMAL SPACING

SWING JOINTS ARE USED ON ALL SPRINKLER HEADS

SYSTEM USES CHECK OR ANTI-DRAIN VALVES

SUBSURFACE IRRIGATION OR OTHER MEANS THAT PRODUCES NO RUNOFF OR OVERSPRAY FOR TURF OR OTHER AREAS LESS THAN 10 FEET IN WIDTH

WHERE SPRINKLER HEADS ARE CLOSER THAN 24" TO HARDSCAPE, HARDSCAPE IS DESIGNED TO DRAIN ENTIRELY INTO LANDSCAPE

EACH VALVE IRRIGATES HYDROZONE WITH SIMILAR CONDITIONS WITH SPRINKLER HEADS AND EMISSION DEVICES THAT ARE APPROPRIATE FOR THE PLANT TYPE WITHIN

TREES WILL BE PLACED ON SEPARATE VAVLES FROM SHRUBS, GROUNDCOVERS, AND TURF WHERE FEASIBLE

DRIP EMITTERS TO BE 1 GPH UNLESS OTHERWISE NOTED

### IRRIGATION NOTES:

ALL IRRIGATION MAIN LINE TRENCHING SHALL BE A MINIMUM OF 18" MIN. BELOW FINISH AT PLANTER BEDS AND 24" MIN. BELOW PAVED SURFACES. LATERAL LINES TO BE 12" BELOW FINISH AND DRIP LINES TO BE 5" BELOW FINISH.

CONNECT IRRIGATION WATER LINE TO DOMESTIC MAIN SUPPLY VIA BACKFLOW PREVENTION DEVICE. (SEE DETAIL.)

ALL BANKS OF IRRIGATION VALVES TO BE CONNECTED TO RIGATION MAINLINE AFTER A GATE VALVE FOR SERVICING OF INDIVIDUAL BANKS.

14GPM AT 55 PSI STATIC UPSTREAM OF BACKFLOW PREVENTOR, VERIFY EXACT PRESSURE PRIOR TO COMMENCEMENT OF WORK.

## LANDSCAPING STATEMENT:

I PATRICK WILSON CERTIFY THAT THIS LANDSCAPING AND IRRIGATION PLAN COMPLIES WITH ALL MONTEREY COUNTY LANDSCAPING REQUIREMENTS INCLUDING USE OF NATIVE, DROUGHT TOLERANT, NON-INVASIVE SPECIES; LIMITED TURF; AND LOW-FLOW, WATER CONSERVING IRRIGATION FIXTURES

I HAVE COMPLIED WITH THE CRITERIA OF THE ORDINANCE AND APPLIED THEM ACCORDINGLY FOR THE EFFICIENT USE OF WATER IN THE IRRIGATION DESIGN PLAN.

### XERISCAPE PRACTICES:

1. LOW WATER USE, DROUGHT TOLERANT PLANTS

2. WATER CONSERVING IRRIGATION TECHNIQUES AND SYSTEMS

3. DRIP IRRIGATE ALL NON-TURE PLANT MATERIAL

4. INSTALLATION OF WEATHER SENSOR AND SMART CONTROLLER TO REGULATE EFFICIENT WATERING.

5. IRRIGATION ZONES TO BE BASED ON LIKE WATER NEEDS.

## AUTOMATIC CONTROLLER DEVICE:

SHALL BE WALL MOUNTED AS DIRECTED BY LANDSCAPE CONTRACTOR. SERVICE TO BE 120 VOLT AC HARDWIRED PER ELECTRICAL CONTRACTOR.

TO BE INSTALLED IN ELECTRAL CONDUIT. RUN ADDITIONAL 2° CHASES AND EXTRA WIRES AS NEEDED. LOCATE BEOW MAIN IRRIGATION LINES. SEE ELECTRICAL PLAN.

TO BE BRASS AND INSTALLED ON A 4"X4" PRESSURE

VALVE BOXES, PIPE, AND HOSE BIBS: ALL EXPOSED COMPONENTS OF IRRIGATION SYSTEM TO BE PURPLE IN COLOR TO SHOW IT I**S** RECLAIMED WATER.

RRIGATION SCHEDULE:
FOR ESTABLISHMENT PERIOD - ONE YEAR
1 AND 2 GALLON PLANTS 15 MINS X 2 TIMES PER WEEK
5 AND 15 GALLON PLANTS 20 MINS X 2 TIMES PER WEEK
24" BOX TREES 30 MINS X 2 TIMES PER WEEK

FOR MATURE PERIOD - AFTER ONE YEAR OR DETERMINE ON PLANT TO
PLANT BASIS

1 AND 2 GALLON PLANTS 15 MINS X 1 TIMES PER WEEK
5 AND 15 GALLON PLANTS 20 MINS X 1 TIMES PER WEEK
24" BOX TREES 30 MINS X 1 TIMES PER WEEK

AS PLANTS MATURE AND BECOME MORE ESTABLISHED, THE IRRIGATION CAN BEGIN TO TAPER OFF AS MUCH AS THE PLANTS WILL ALLOW.

## IRRIGATION LEGEND:

1.5" DIA SCH. 40 PVC MAIN SUPPLY LINE

FEBCO BACKFLOW PREVENTION DEVICE

 $\boxtimes$ MAINLINE MASTER VALVE

 $\odot$ RAINBIRD ESP-SMT SMART IRRIGATION CONTROLLER

 $\widetilde{\odot}$ 

RAINBIRD ESP RAIN SENSOR

 $\bowtie$ GATE VALVE

4" SCH 40 PVC CHASE PIPE

MISSION LANDSCAPING

P.O. BOX 875 PACIFIC GROVE CALIFORNIA 93950

P 831 373 8293 F 831 373 2283 www.missionlandscaping.com email:

missionlandscaping@me.com Landscape & General Contractors C27 & B 392291 Landscape Architecture CA Lic #5806

Donovan - Huang Residence Monte Verde St. 3SW of 10th Ave. Carmel By-The-Sea, CA 93921

APN: 010-185-003


Renewal Date 10/23/2018


Drawing Title:

Irrigation Plan

10/23/2018 As Shown Drawn By: DW


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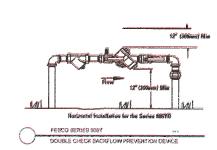


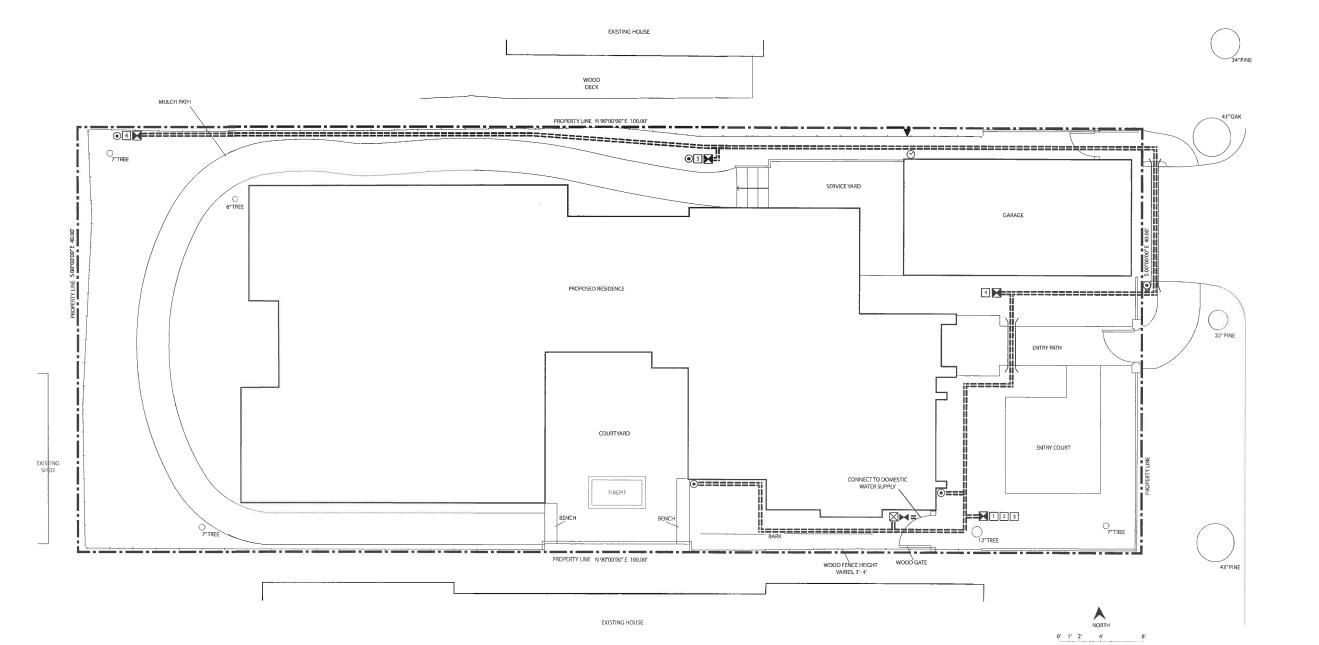

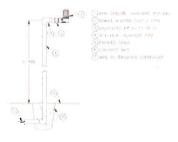D PAIN SENSOR
SO RSD CEX POLE MOUNT





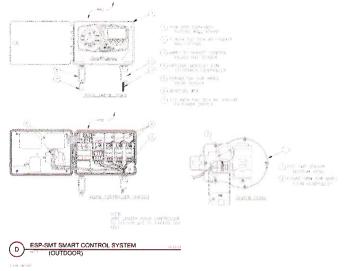


SGH 80 NIPPLE (2-INCH LENGTH, HIDDEN) AND SCH 40 EL

PVC MAINLINE PPE

PVC SCH 40 TEE OR EUL

3.0-INCH MIRMAN DEPTH OF

3/4-INCH WASHED GRAVEL

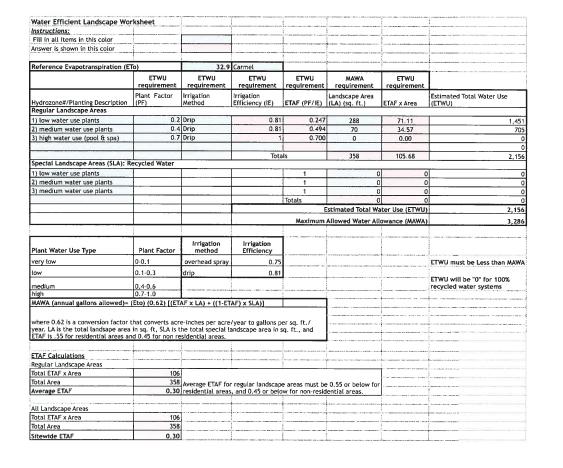



## MISSION LANDSCAPING P.O. BOX 875 PACIFIC GROVE CALIFORNIA 93950

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Project:

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APN: 010-185-003



Drawing Title:

Details Plan

Date:	10/23/2018				
Scale:	As Shown				
Drawn By:	DW				

L2.1

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# PONOVAN RESIDENCE CARMEL BY THE SEA

RECEIVED

NOV 6 2018

City of Carmel-by-the-Sea Planning & Building Dept.

# RECEIVED

NOV 6 2018

# City of Carmel-by-the-Sea Planning & Building Dept.

# DONOVAN – HUANG PROJECT MONTE VERDE ST., 3 SW OF 10<sup>TH</sup> AVE., CARMEL-BY-THE-SEA CA APN: 010-185-003

**COLOR AND MATERIAL SAMPLES FOR** 

CLASS 'A' NATURAL **SLATE ROOF** AMERICAN SLATE OR EQUAL



**EXTERIOR STUCCO WALLS** 



STAINED CEDAR CORBELS, SILLS, RAFTER TAILS, TRIM AND GARAGE DOOR



CABOT SEMI-SOLID STAIN: THATCH

# RANDOM EXTERIOR STONE

HALF-ROUND COPPER **GUTTERS & DOWNSPOUTS** 





## PAINTED WOOD EXTERIOR **DOORS AND WINDOWS**

