


DONOVAN RESIDENCE CARMEL BT - THE SEA

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NOV 6 2018

City of Carmel-by-the-Sea Planning & Building Dept.

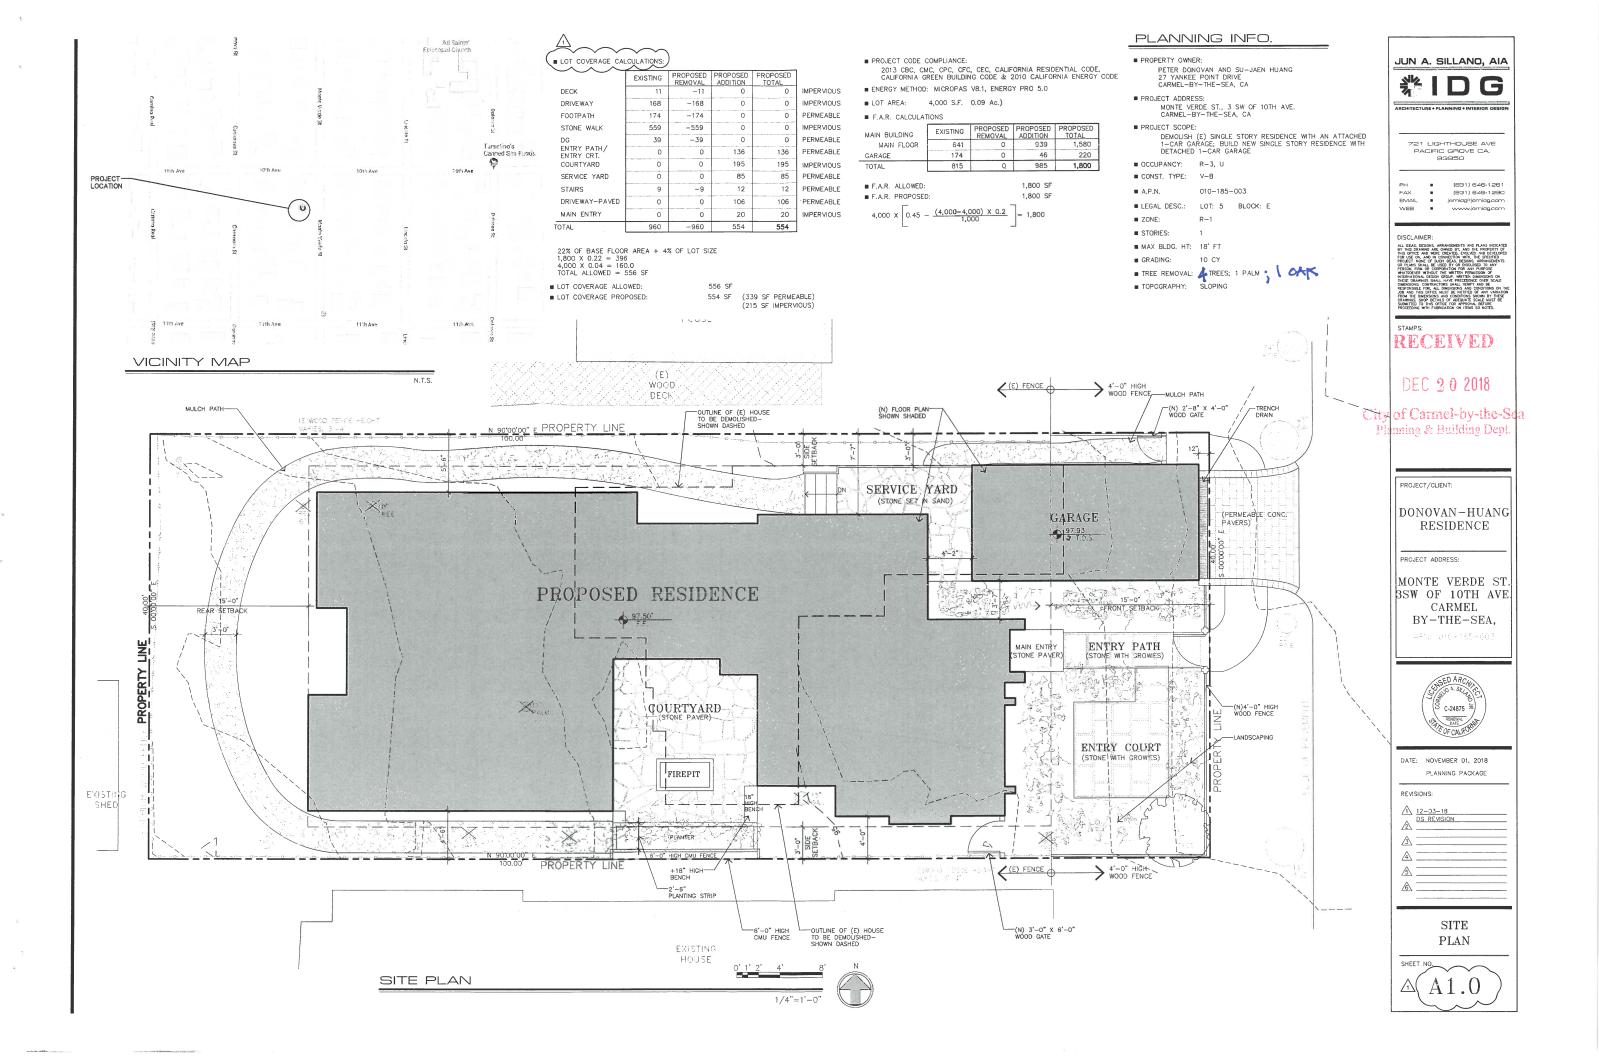



LEGEND


HO W = WALL MOUNTED
DOWNLIGHT
LIGHT FIXTURE
10 WATTS

EXTERIOR LIGHTING PLAN


1-25 WATTS MAX. WITH PHOTO SENSOR MINKA-LAVERY BAYTREE LANE OUTDOOR FIXTURES

XISTING SHED

EXT. WALL MOUNT LIGHT FIXTURE

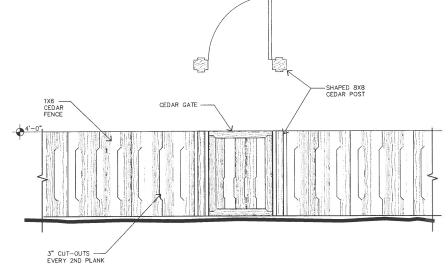

ENTRY GATE AND FENCE

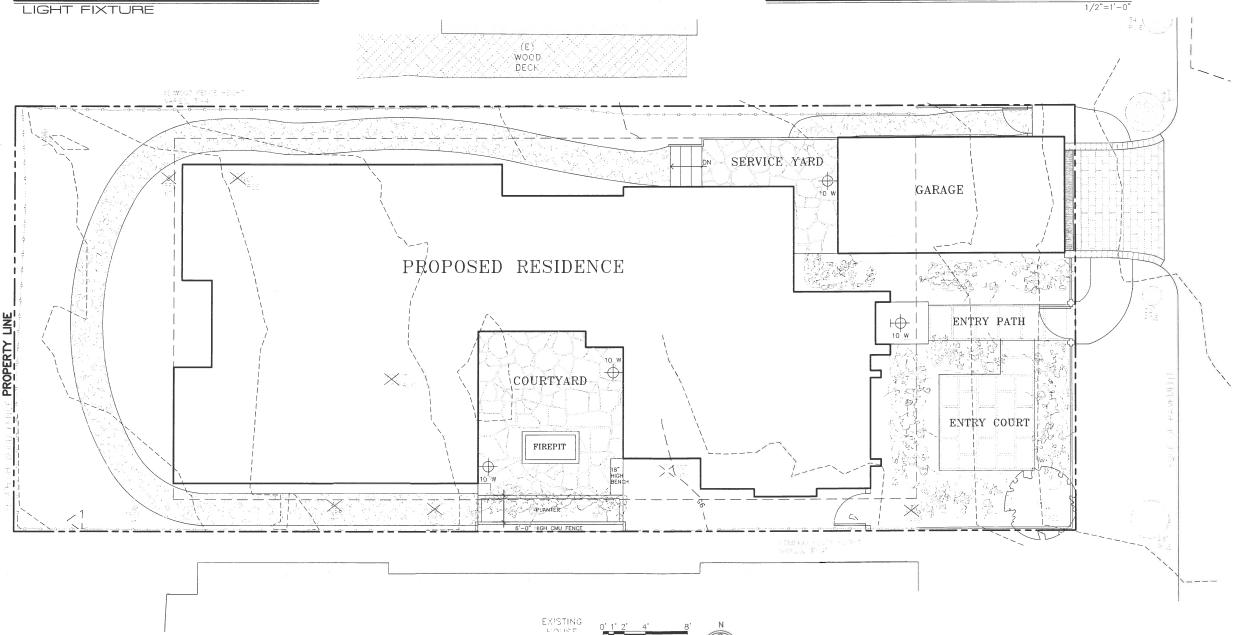



JUN A. SILLANO, AIA

DISCLAIMER:

PROJECT/CLIENT:

DONOVAN-HUANG RESIDENCE

PROJECT ADDRESS:

MONTE VERDE ST. BSW OF 10TH AVE. CARMEL BY-THE-SEA,




DATE: NOVEMBER 01, 2018 PLANNING PACKAGE

REVISIONS:

EXTERIOR LIGHTING PLAN



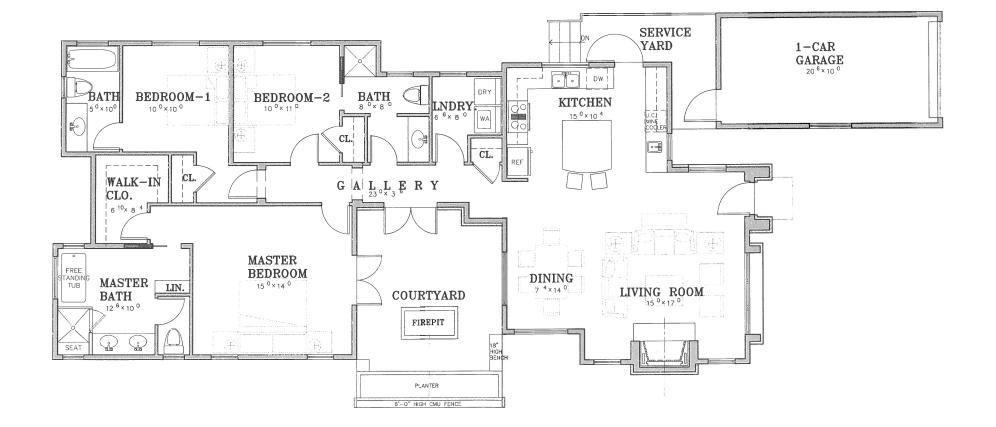

8' N



721 LIGHTHOUSE AVE PACIFIC GROVE CA. 93950

DISCLAIMER:

LIDUCAMMENT: ADMINISTRATION PARE INC.

AT REST DESCRIPTION OF A PA

STAMPS:

PROJECT/CLIENT:

DONOVAN-HUANG RESIDENCE

PROJECT ADDRESS:

MONTE VERDE ST. 3SW OF 10TH AVE. CARMEL BY-THE-SEA,

Fir 010-185-003



DATE: NOVEMBER 01, 2018
PLANNING PACKAGE

REVISION

12-03-18 DS REVISION


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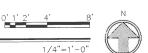
3

FLOOR PLAN

SHEET NO.

A2.0



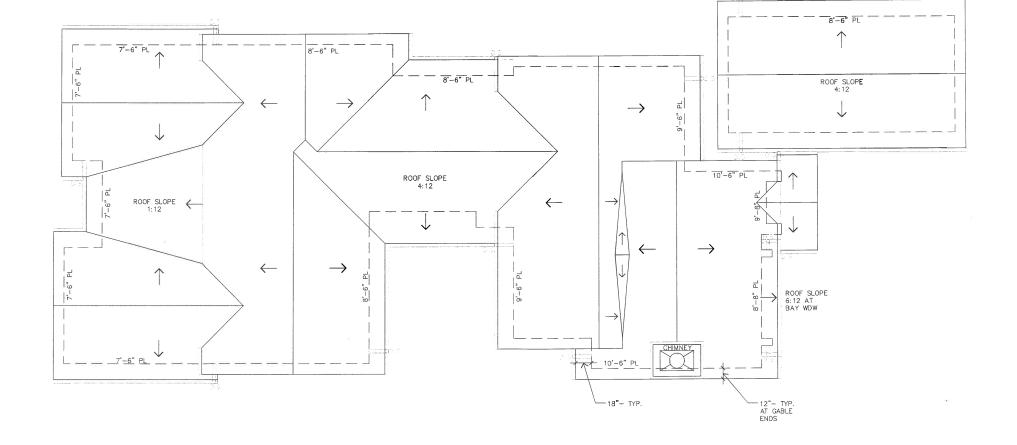



ARCHITECTURE A DI ANNUNIO A INTERIOR DESIGN

721 LIGHTHOUSE AVE PACIFIC GROVE CA.

DISCLAIM

LISCULARMENT:

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STAMPS:

PROJECT/CLIENT:

DONOVAN-HUANG RESIDENCE

PROJECT ADDRESS:

MONTE VERDE ST. BSW OF 10TH AVE. CARMEL BY-THE-SEA,

APIN 010-185-00



DATE: NOVEMBER 01, 2018
PLANNING PACKAGE

REVISIO


12-03-18 DS REVISION


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ROOF PLAN

SHEET NO.

A5.0




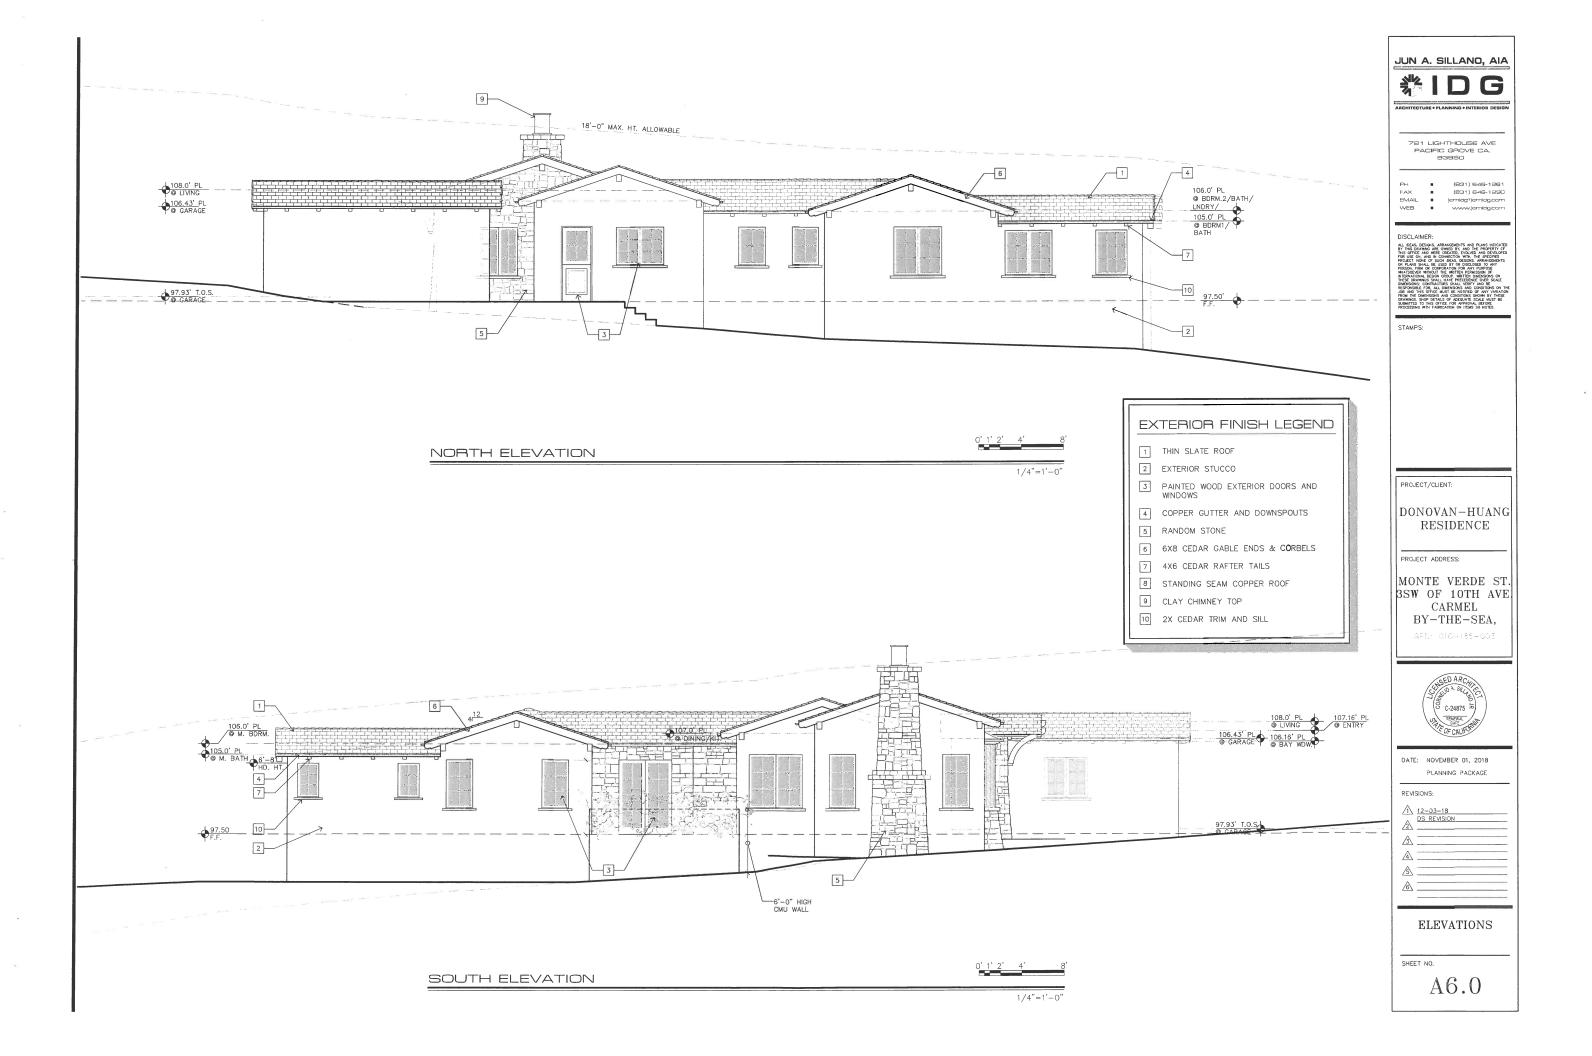

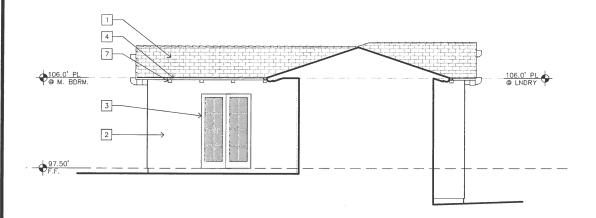EAST ELEVATION- COURTYARD 0' 1' 2' 4' 8 1/4"=1'-0"





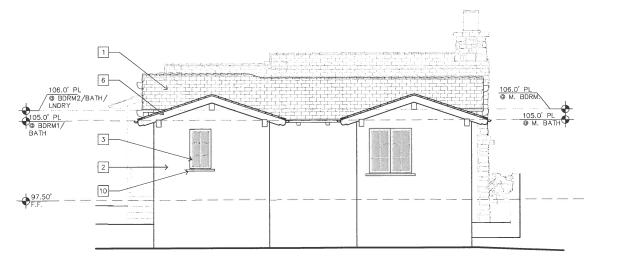

WEST ELEVATION



JUN A. SILLANO, AIA

ARCHITECTURE + PLANNING + INTERIOR DESIGN

721 LIGHTHOUSE AVE PACIFIC GROVE CA. 93950

DISCLAIMER

EXTERIOR FINISH LEGEND

PAINTED WOOD EXTERIOR DOORS AND WINDOWS

4 COPPER GUTTER AND DOWNSPOUTS

6 6X8 CEDAR GABLE ENDS & CORBELS

7 4X6 CEDAR RAFTER TAILS

8 STANDING SEAM COPPER ROOF

9 CLAY CHIMNEY TOP
10 2X CEDAR TRIM AND SILL

1 THIN SLATE ROOF
2 EXTERIOR STUCCO

5 RANDOM STONE

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STAMPS:

PROJECT/CLIENT:

DONOVAN-HUANG RESIDENCE

PROJECT ADDRESS:

MONTE VERDE ST. 3SW OF 10TH AVE. CARMEL BY-THE-SEA,

APN: 010-135-003



DATE: NOVEMBER 01, 2018
PLANNING PACKAGE

REVISIONS:

12-03-18 DS REVISION

4

ELEVATIONS

SHEET NO.

A6.1

PLANTING LEGEND

SYMBOL	BOTANICAL NAME	COMMON NAME	QUANTITY	SIZE	WUCOLS
ACE PAL	Acer palmatum	Japanese Maple	2	15 gal	Med
AGA STO	Agapanthus 'Storm Cloud'	Storm Cloud Agapanthus	8	1 gal	Med
ARC CAR	Arctostaphylos edmunsii 'Carmel Sur'	Carmel Sur Manzanita	10	1 gal	Low
ARC HOW	Arctostaphylos densiflora 'Howard McMinn'	Howard McMinn Manzanita	9	5 gal	Low
CON MAU	Convolvulus mauritanicus	Ground Morning Glory	7	1 gal	Low
COR IVO	Correa 'Ivory Bells'	Ivory Bells Australian Fuchsia	5	1 gal	Low
CUP MAC	Cupressus macrocarpa	Monterey Cypress	1	15 gal	Low
HEU MAX	Heuchera maxima	Coral Bells	10	1 gal	Med
LIM PER	Limonium perezii	Sea Lavander	11	1 gal	Low
OLE EUR	Olea europea Little Ollie'	Little Ollie	4	5 gal	Low
ROS TUS	Rosmarinus 'Tuscan Blue'	Tuscan Blue Rosemary	7	5 gal	Low
PRU CAR	Prunus caroliniana	Carolina Cherry Laural	24	5 gal	Low
SAL LEU	Salvia leucantha	Mexican Bush Sage	5	1 gal	Low
TEU CHA	Teucrium chamaedrys	Germander	16	1 gal	Low
WOO FIM	Woodwardia fimbriata	Giant Chain Fern	16	5 gal	Low

BUILDING DEPARTMENT NOTES:

PERMITS & INSPECTIONS:

THE CONTRACTOR SHALL OBTAIN ALL REQUIRED INSPECTIONS FOR THE WORK AND GIVE THE OWNER TIMELY NOTICE OF INTENT TO EACH INSPECTION.

ALL MATERIAL, WORKMANSHIP AND METHODS OF CONSTRUCTION SHALL CONFORM TO THE APPLICABLE REQUIREMENTS OF THE UBC AND LOCAL BUILDING CODES.

NO POTABLE WATER MAY BE USED FOR COMPACTION OR DUST CONTROL PURPOSES IN CONSTRUCTION ACTIVITIES WHERE THERE IS A REASONABLY AVAILABLE SOURCE OF RECLAIMED WATER.

CONTRACTOR TO USE AUTO SHUT-OFF NOZZLES ON ANY WATER HOSES USED ON THE PROJECT.

LAYOUT NOTES: ANNOTATED DIMENSIONS TO TAKE PRECEDENCE OVER SCALED DRAWINGS.

FIRE SAFETY NOTES: ALL NON IRRIGATED BRUSH TO BE KEPT AT GROUND LEVEL FOR AN AREA OF 50' SURROUNDING THE PROPOSED RESIDENCE.

TREES TO BE CLEARED OF DEAD LIMBS WITHIN A 50' RADIUS OF THE PROPOSED RESIDENCE. ANY TREE LIMBS WITHIN 10' OF A CHIMNEY WILL BE REMOVED.

XERISCAPE PRACTICES:

- LOW WATER USE, DROUGHT TÖLERANT PLANTS
 WATER CONSERVING IRRIGATION TECHNIQUES AND SYSTEMS
 JORIP IRRIGATE ALL PLANT MATERIAL
 INSTALLATION OF RAIN SENSOR

PLANTING NOTES:

ALL LANDSCAPE AREAS SHALL BE CONTINUOUSLY MAINTAINED IN A LITTER FREE, WEED FREE CONDITION AND ALL PLANT MATERIAL SHALL BE CONTINUOUSLY MAINTAINED IN A HEALTHY GROWING CONDITION.

STAKING: STAKING SHALL BE PROVIDED FOR TREES AND SHRUBS AS NEEDED. TIES TO BE LOCATED AND SIZED TO ALLOW FOR EXPANSION AND GROWTH.

MULCHING: SPREAD 3" OF MULCH OVER ALL EXPOSED PLANTING AREAS

COMPOST MINIMUM OF 4 CUBIC YARDS PER 1,000SQFT OF PERMEABLE AREA TO A DEPTH OF 6°

STAGING: WHEN STAGING PLANT MATERIAL ON SITE INSTALL A TEMPORARY DRIP LINE AS NEEDED.

SOIL AMENDMENT TO BE ADDED TO PLANTED ARE AS NEEDED FOR PLANT MATERIAL

SCOPE OF WORK:

THIS IS NEW LANDSCAPE INSTALLTION WITH A NEW LOW FLOW DRIP IRRIGATION SYSTEM. LANDSCAPE DESIGNED TO USE ALL NATIVE AND/OR DROUGHT TOLERANT PLANTING.

PROJECT INFORMATION:

DONOVAN-HUANG OWNER

MONTE VERDE ST., 3 SW OF 10TH AVE. CARMEL-BY-THE-SEA, CA SITE

010-185-003 APN

SLOPED TOPOGRAPHY

TREE REPLACEMENT PLAN TO MEET MONTEREY COUNTY REQUIERMENTS TREE REMOVAL

SOILS REPORT SEE SOILS REPORT GRADING

LANDSCAPING STATEMENT:

I PATRICK WILSON CERTIFY THAT THIS LANDSCAPING AND IRRIGATION PARICK WILSON DERIFFT INTO AN ADVANCE PRINCH AND TRINGARD PLAN COMPUES WITH A LLL CITY OF CARMEL'S LANDSCAPING REQUIREMENTS INCLUDING USE OF NATIVE, DROUGHT TOLERANT, NON-INVASIVE SPECIES, LIMITED TURF; AND LOW-FLOW, WATER CONSERVING IRRIGATION FIXTURES

I HAVE COMPLIED WITH THE CRITERIA OF THE ORDINANCE AND APPLIED THEM FOR THE EFFICIENT USE OF WATER IN THE LANDSCAPE DESIGN PLAN.

Donovan - Huang Residence Monte Verde St. 3SW of 10th Ave.

Carmel By-The-Sea, CA 93921

MISSION

LANDSCAPING

P.O. BOX 875

PACIFIC GROVE

CALIFORNIA 93950

P 831 373 8293 F 831 373 2283

missionlandscaping@me.com Landscape & General Contractors C27 & B 392291 Landscape Architecture CA Lic #5806

APN: 010-185-003

Revisions: Revision 1: 12/17/18




Planting Plan

Date:	10/23/2018	
Scale:	As Shown	
Drawn By:	DW	
Dogo Mumb	281	

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IRRIGATION NOTES:

SYSTEM DESIGNED TO PREVENT LOW HEAD DRAINAGE AND NO OVERSPRAY

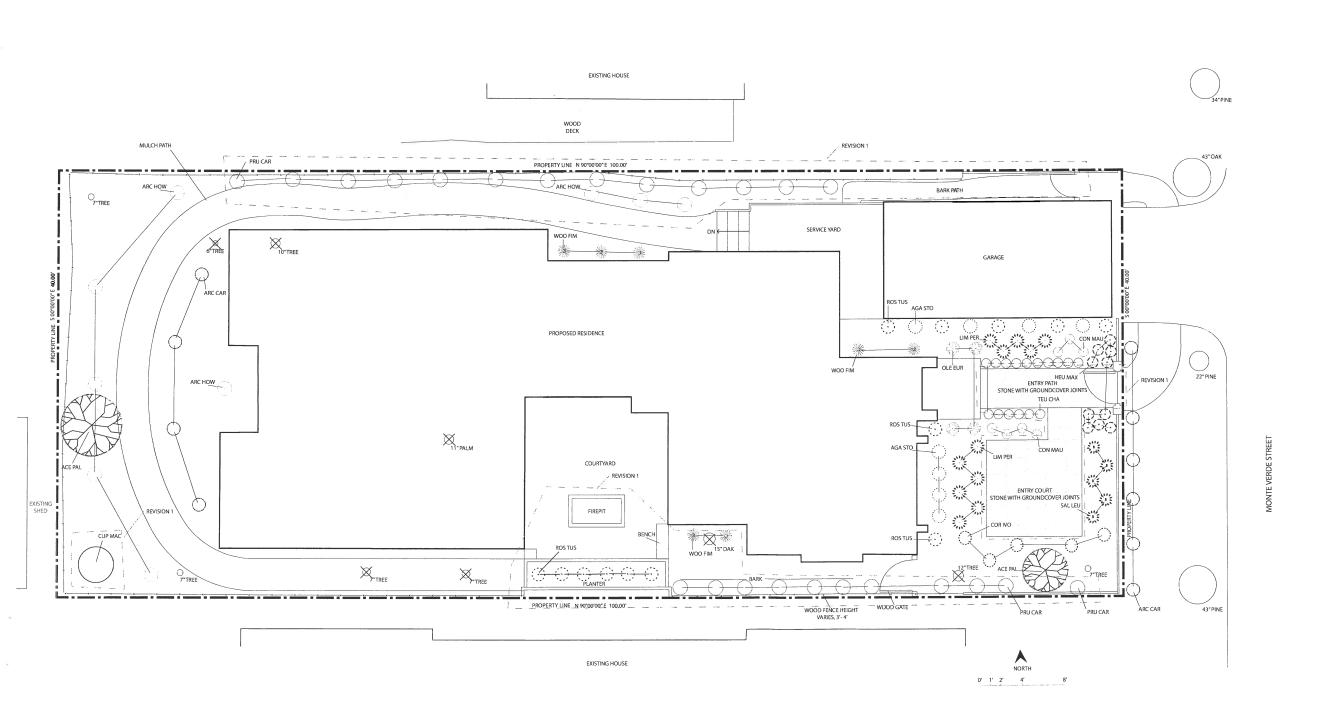IRRIGATION LAID OUT TO CONFORM TO HYDROZONES INDICATED ON

SYSTEM DESIGNED TO ACHIEVE MINIMUM IRRIGATION EFFICIENCY OF .75 FOR OVERHEAD SPRAY AND .81 FOR DRIP ZONES

SYSTEM USES LOW VOLUME IRRIGATION IN MULCHED PLANTING AREAS

SYSTEM HAS MATCHED PRECIPITATION RATES FOR HEAD AND EMISSION DEVICES

THE IRRIGATION HEADS ARE LAID OUT FOR OPTIMAL SPACING

SWING JOINTS ARE USED ON ALL SPRINKLER HEADS

SYSTEM USES CHECK OR ANTI-DRAIN VALVES

SUBSURFACE IRRIGATION OR OTHER MEANS THAT PRODUCES NO RUNOFF OR OVERSPRAY FOR TURF OR OTHER AREAS LESS THAN 10 FEET IN WIDTH

WHERE SPRINKLER HEADS ARE CLOSER THAN 24" TO HARDSCAPE, HARDSCAPE IS DESIGNED TO DRAIN ENTIRELY INTO LANDSCAPE

EACH VALVE IRRIGATES HYDROZONE WITH SIMILAR CONDITIONS WITH SPRINKLER HEADS AND EMISSION DEVICES THAT ARE APPROPRIATE FOR THE PLANT TYPE WITHIN THE HYDROZONE

TREES WILL BE PLACED ON SEPARATE VAVLES FROM SHRUBS, GROUNDCOVERS, AND TURF WHERE FEASIBLE

DRIP EMITTERS TO BE 1 GPH UNLESS OTHERWISE NOTED

IRRIGATION NOTES:

ALL IRRIGATION MAIN LINE TRENCHING SHALL BE A MINIMUM OF 18" MIN. BELOW FINISH AT PLANTER BEDS AND 24" MIN.
BELOW PAVED SURFACES. LATERAL LINES TO BE 12" BELOW
FINISH AND DRIP LINES TO BE 5" BELOW FINISH.

CONNECT IRRIGATION WATER LINE TO DOMESTIC MAIN SUPPLY VIA BACKFLOW PREVENTION DEVICE. (SEE DETAIL.)

ALL BANKS OF IRRIGATION VALVES TO BE CONNECTED TO IRRIGATION MAINLINE AFTER A GATE VALVE FOR SERVICING OF INDIVIDUAL BANKS.

IRRIGATION DEMAND:

14GPM AT 55 PSI STATIC UPSTREAM OF BACKFLOW PREVENTOR. VERIFY EXACT PRESSURE PRIOR TO COMMENCEMENT OF WORK.

LANDSCAPING STATEMENT:

I PATRICK WILSON CERTIFY THAT THIS LANDSCAPING AND IRRIGATION PLAN COMPLIES WITH ALL MONTEREY COUNTY LANDSCAPING REQUIREMENTS INCLUDING USE OF NATIVE, DROUGHT TOLERANT, NON-INVASIVE SPECIES; LIMITED TURF; AND LOW-FLOW, WATER CONSERVING IRRIGATION FIXTURES

I HAVE COMPLIED WITH THE CRITERIA OF THE ORDINANCE AND APPLIED THEM ACCORDINGLY FOR THE EFFICIENT USE OF WATER IN THE IRRIGATION DESIGN PLAN.



XERISCAPE PRACTICES:

1 LOW WATER USE DROUGHT TOLERANT PLANTS

2. WATER CONSERVING IRRIGATION TECHNIQUES AND SYSTEMS

3. DRIP IRRIGATE ALL NON-TURF PLANT MATERIAL

4. INSTALLATION OF WEATHER SENSOR AND SMART CONTROLLER TO REGULATE EFFICIENT WATERING.

5. IRRIGATION ZONES TO BE BASED ON LIKE WATER NEEDS.

AUTOMATIC CONTROLLER DEVICE:

SHALL BE WALL MOUNTED AS DIRECTED BY LANDSCAPE CONTRACTOR. SERVICE TO BE 120 VOLT AC HARDWIRED PER ELECTRICAL CONTRACTOR.

TO BE INSTALLED IN ELECTRAL CONDUIT. RUN ADDITIONAL 2° CHASES AND EXTRA WIRES AS NEEDED. LOCATE BEOW MAIN IRRIGATION LINES. SEE ELECTRICAL PLAN.

TO BE BRASS AND INSTALLED ON A 4"X4" PRESSURE TREATED POST.

VALVE BOXES, PIPE, AND HOSE BIBS: ALL EXPOSED COMPONENTS OF IRRIGATION SYSTEM TO BE PURPLE IN COLOR TO SHOW IT IS RECLAIMED WATER.

IRRIGATION SCHEDULE:

INNIGATION SCHEDULE:
FOR ESTABLISHMENT PERIOD - ONE YEAR
1 AND 2 GALLON PLANTS
5 AND 15 GALLON PLANTS
20 MINS X 2 TIMES PER WEEK
24 BOX TREES
20 MINS X 2 TIMES PER WEEK

FOR MATURE PERIOD - AFTER ONE YEAR OR DETERMINE ON PLANT TO PLANT BASIS

1 AND 2 GALLON PLANTS 15 MINS X 1 TIMES PER WEEK
5 AND 15 GALLON PLANTS 20 MINS X 1 TIMES PER WEEK
24" BOX TREES 30 MINS X 1 TIMES PER WEEK

AS PLANTS MATURE AND BECOME MORE ESTABLISHED, THE IRRIGATION CAN BEGIN TO TAPER OFF AS MUCH AS THE PLANTS WILL ALLOW.

IRRIGATION LEGEND:

 \boxtimes

 \odot

•

 \bowtie

1.5" DIA SCH. 40 PVC MAIN SUPPLY LINE

FEBCO BACKFLOW PREVENTION DEVICE

MAINLINE MASTER VALVE

VALVE BOX

RAINBIRD ESP-SMT SMART IRRIGATION CONTROLLER

HOSE BIB

RAINBIRD ESP RAIN SENSOR GATE VALVE

4" SCH 40 PVC CHASE PIPE

MISSION LANDSCAPING P.O. BOX 875 PACIFIC GROVE CALIFORNIA 93950 P 831 373 8293

F 831 373 2283 www.missionlandscaping.com email: missionlandscaping@me.com Landscape & General Contractors C27 & B 392291 Landscape Architecture CA Lic #5806

Project

Donovan - Huang Residence Monte Verde St. 3SW of 10th Ave. Carmel By-The-Sea, CA 93921

APN: 010-185-003 Revisions: Revision 1: 12/17/18


Irrigation Plan


10/23/2018 As Shown DW


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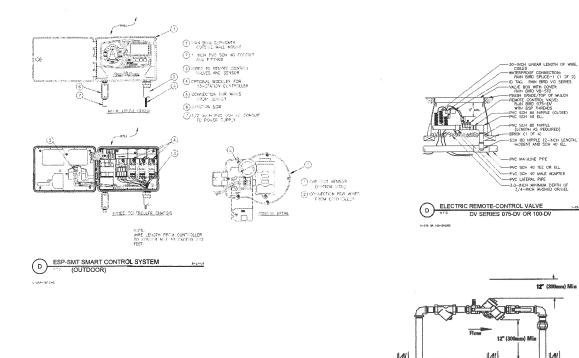
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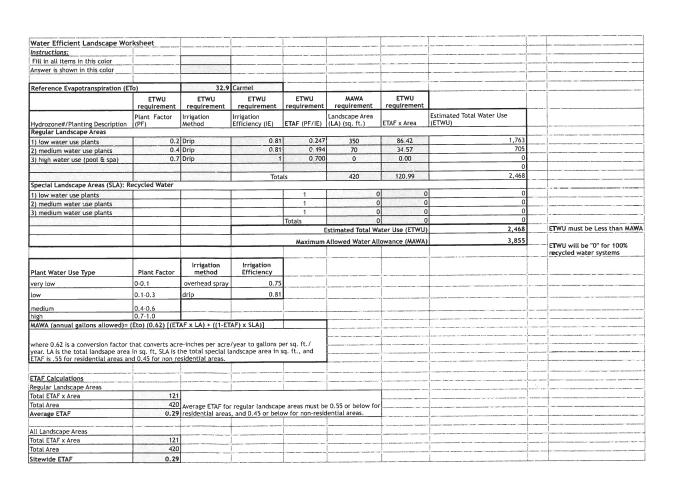
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missionlandscaping@me.com Landscape & General Contractors C27 & B 392291 Landscape Architecture CA Lic #5806

Project:

12" (300mm) Min

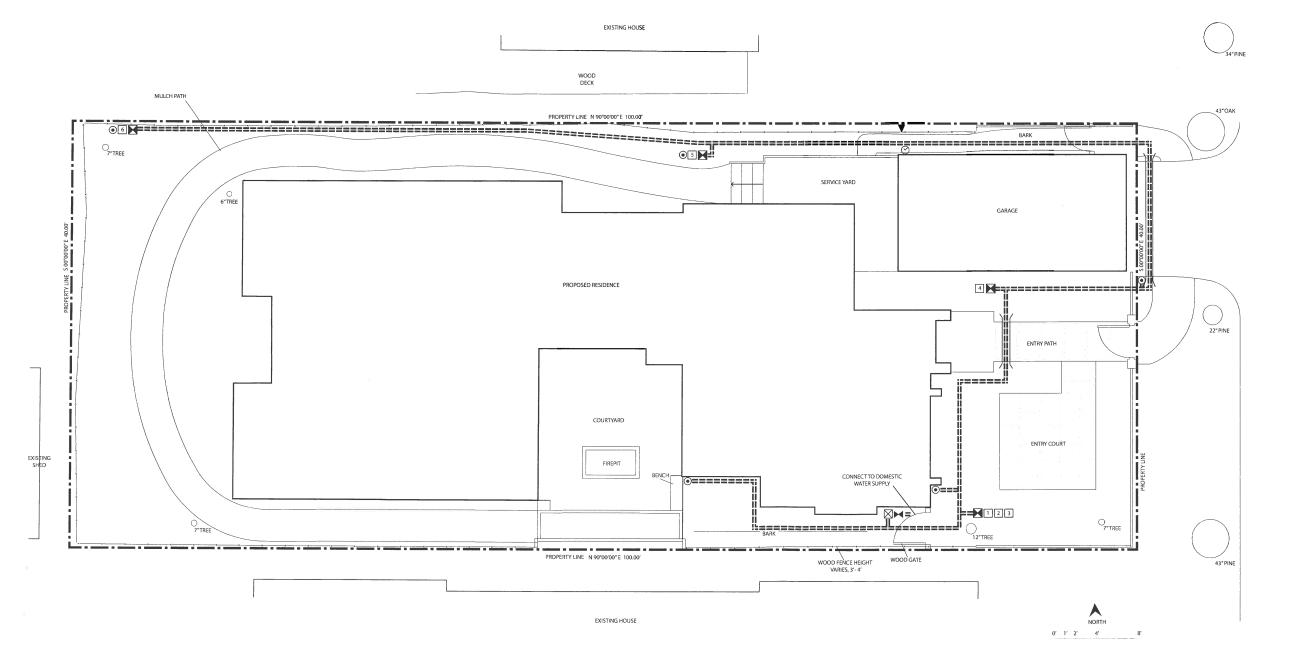Horizontal Installation for the Series 805YD

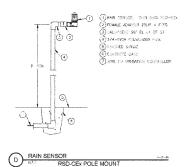DOUBLE CHECK BACKFLOW PREVENTION DEVICE

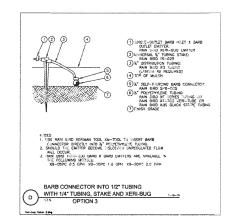FEBCO SERIES 805Y

Donovan - Huang Residence Monte Verde St. 3SW of 10th Ave. Carmel By-The-Sea, CA 93921

APN: 010-185-003

Revisions: Revision 1: 12/17/18



Drawing Title:


Details Plan

10/23/2018 Scale: As Shown

Drawn By: DW

Page Number:

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COLOR AND MATERIAL SAMPLES FOR

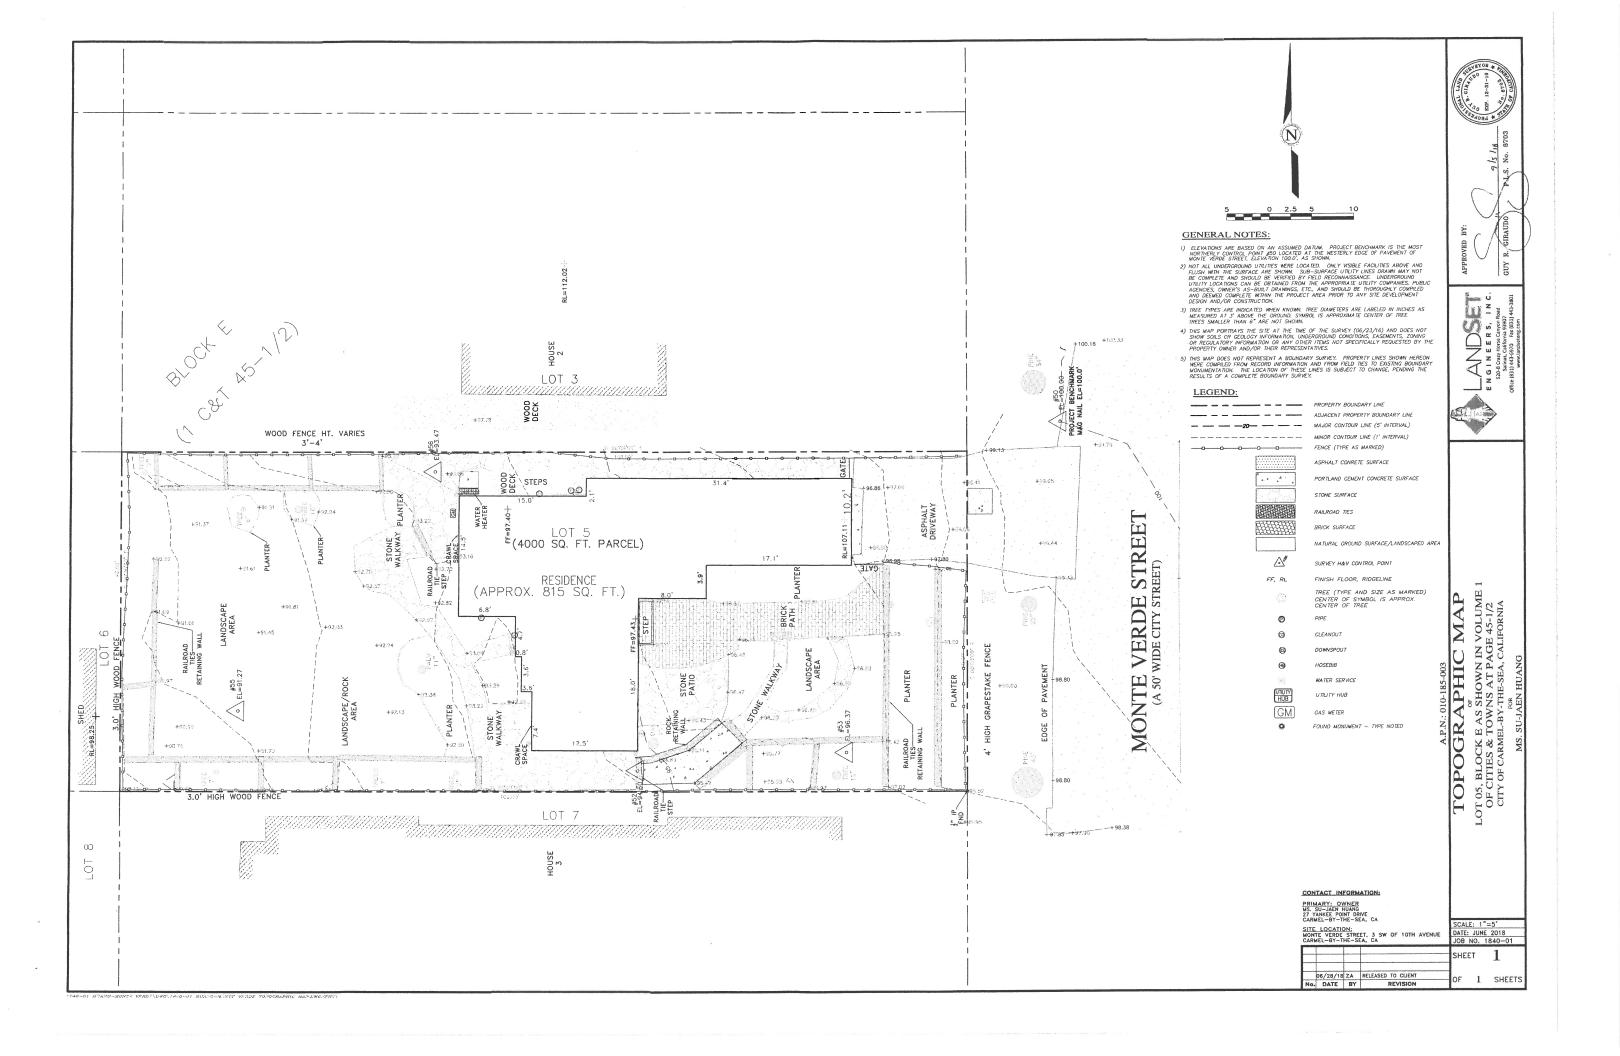DONOVAN – HUANG PROJECT MONTE VERDE ST., 3 SW OF 10TH AVE., CARMEL-BY-THE-SEA CA APN: 010 -185-003

RECEIVED

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City of Carmel-by-the-Sea Planning & Building Dept.


CLASS 'A' NATURAL SLATE ROOF AMERICAN SLATE OR EQUAL



EXTERIOR STUCCO WALLS




STAINED CEDAR CORBELS, SILLS, RAFTER TAILS, TRIM AND GARAGE DOOR

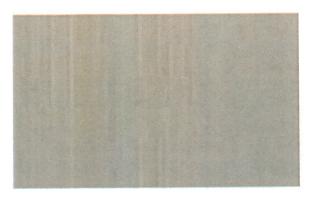

CABOT SEMI-SOLID STAIN: THATCH

STONE WITH GROWIES



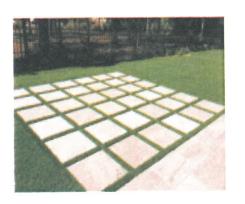



STONE PAVER





RANDOM EXTERIOR STONE



PAINTED WOOD
EXTERIOR
DOORS AND WINDOWS



CONCRETE PAVER

