

716 LIGHTHOUSE AVE. SUITE C PACIFIC GROVE, CA. 93950

TEL: 831.372-7251 FAX: 831.372-7252 CEL: 831.915-9518

PROJECT/CLIENT

HUNTER RESIDENCE

JR & CINDY HUNTER NW CASANOVA & 13TH CARMEL, CA.



SHEET TITLE

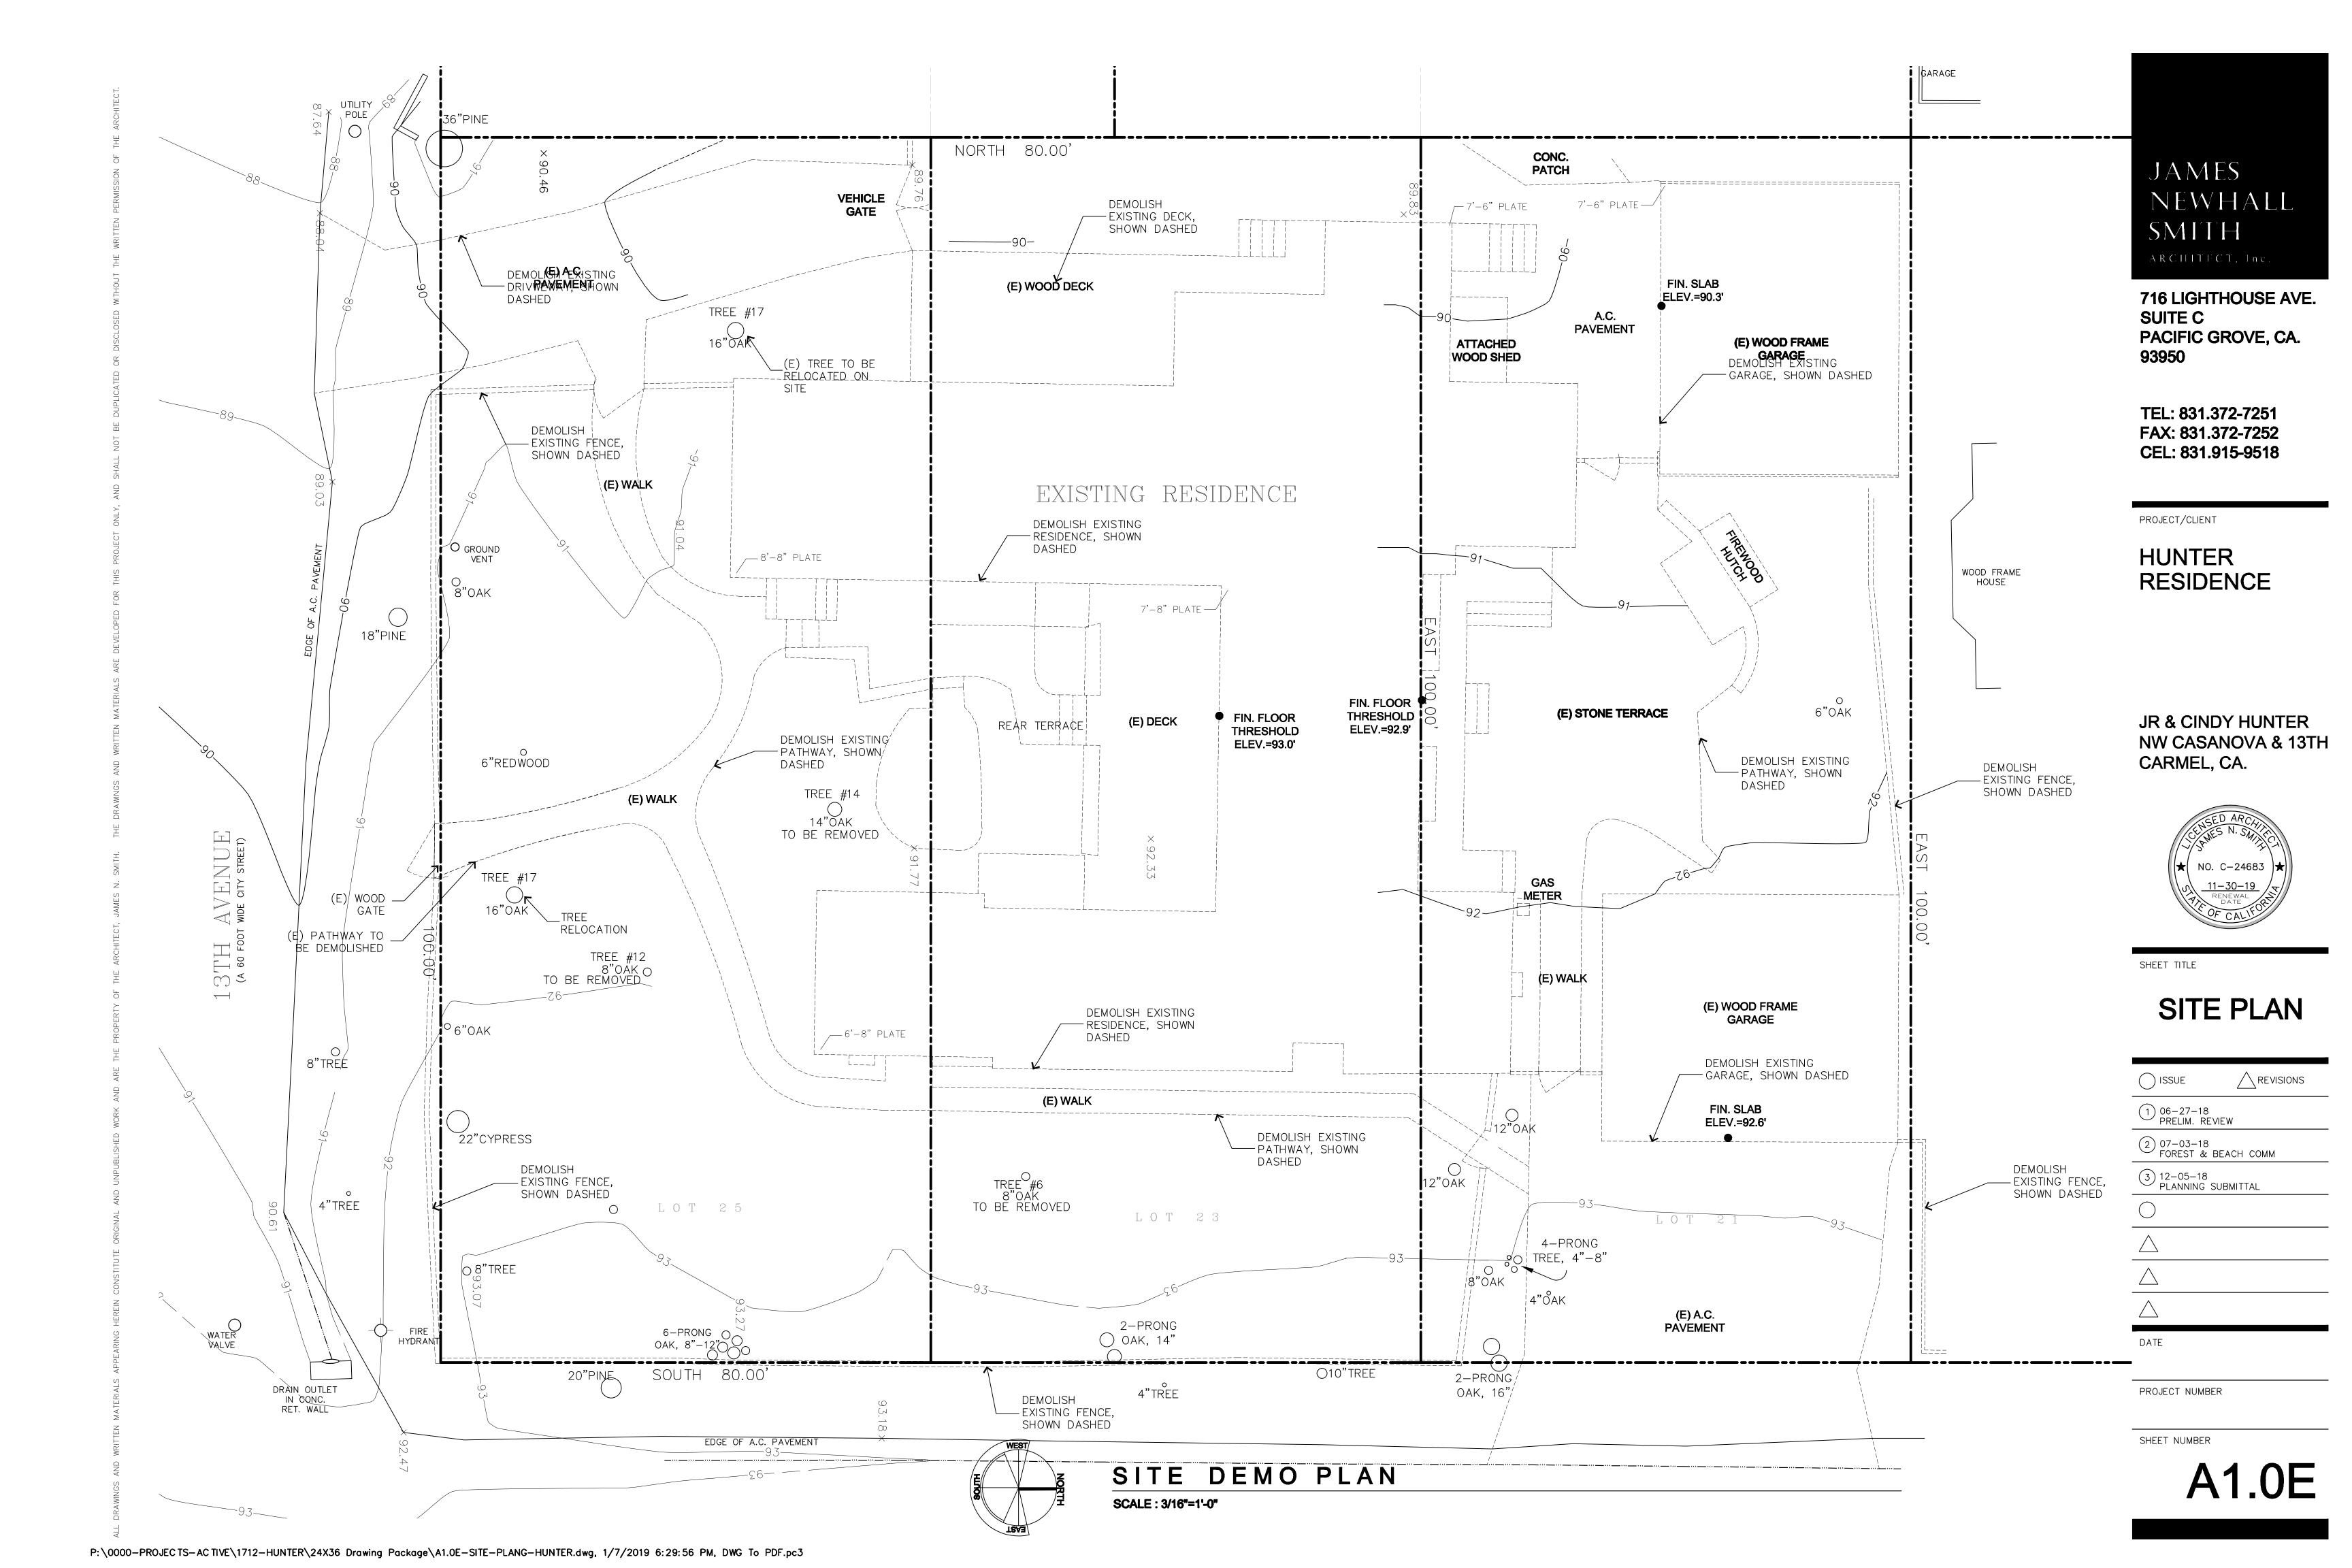
SITE PLAN

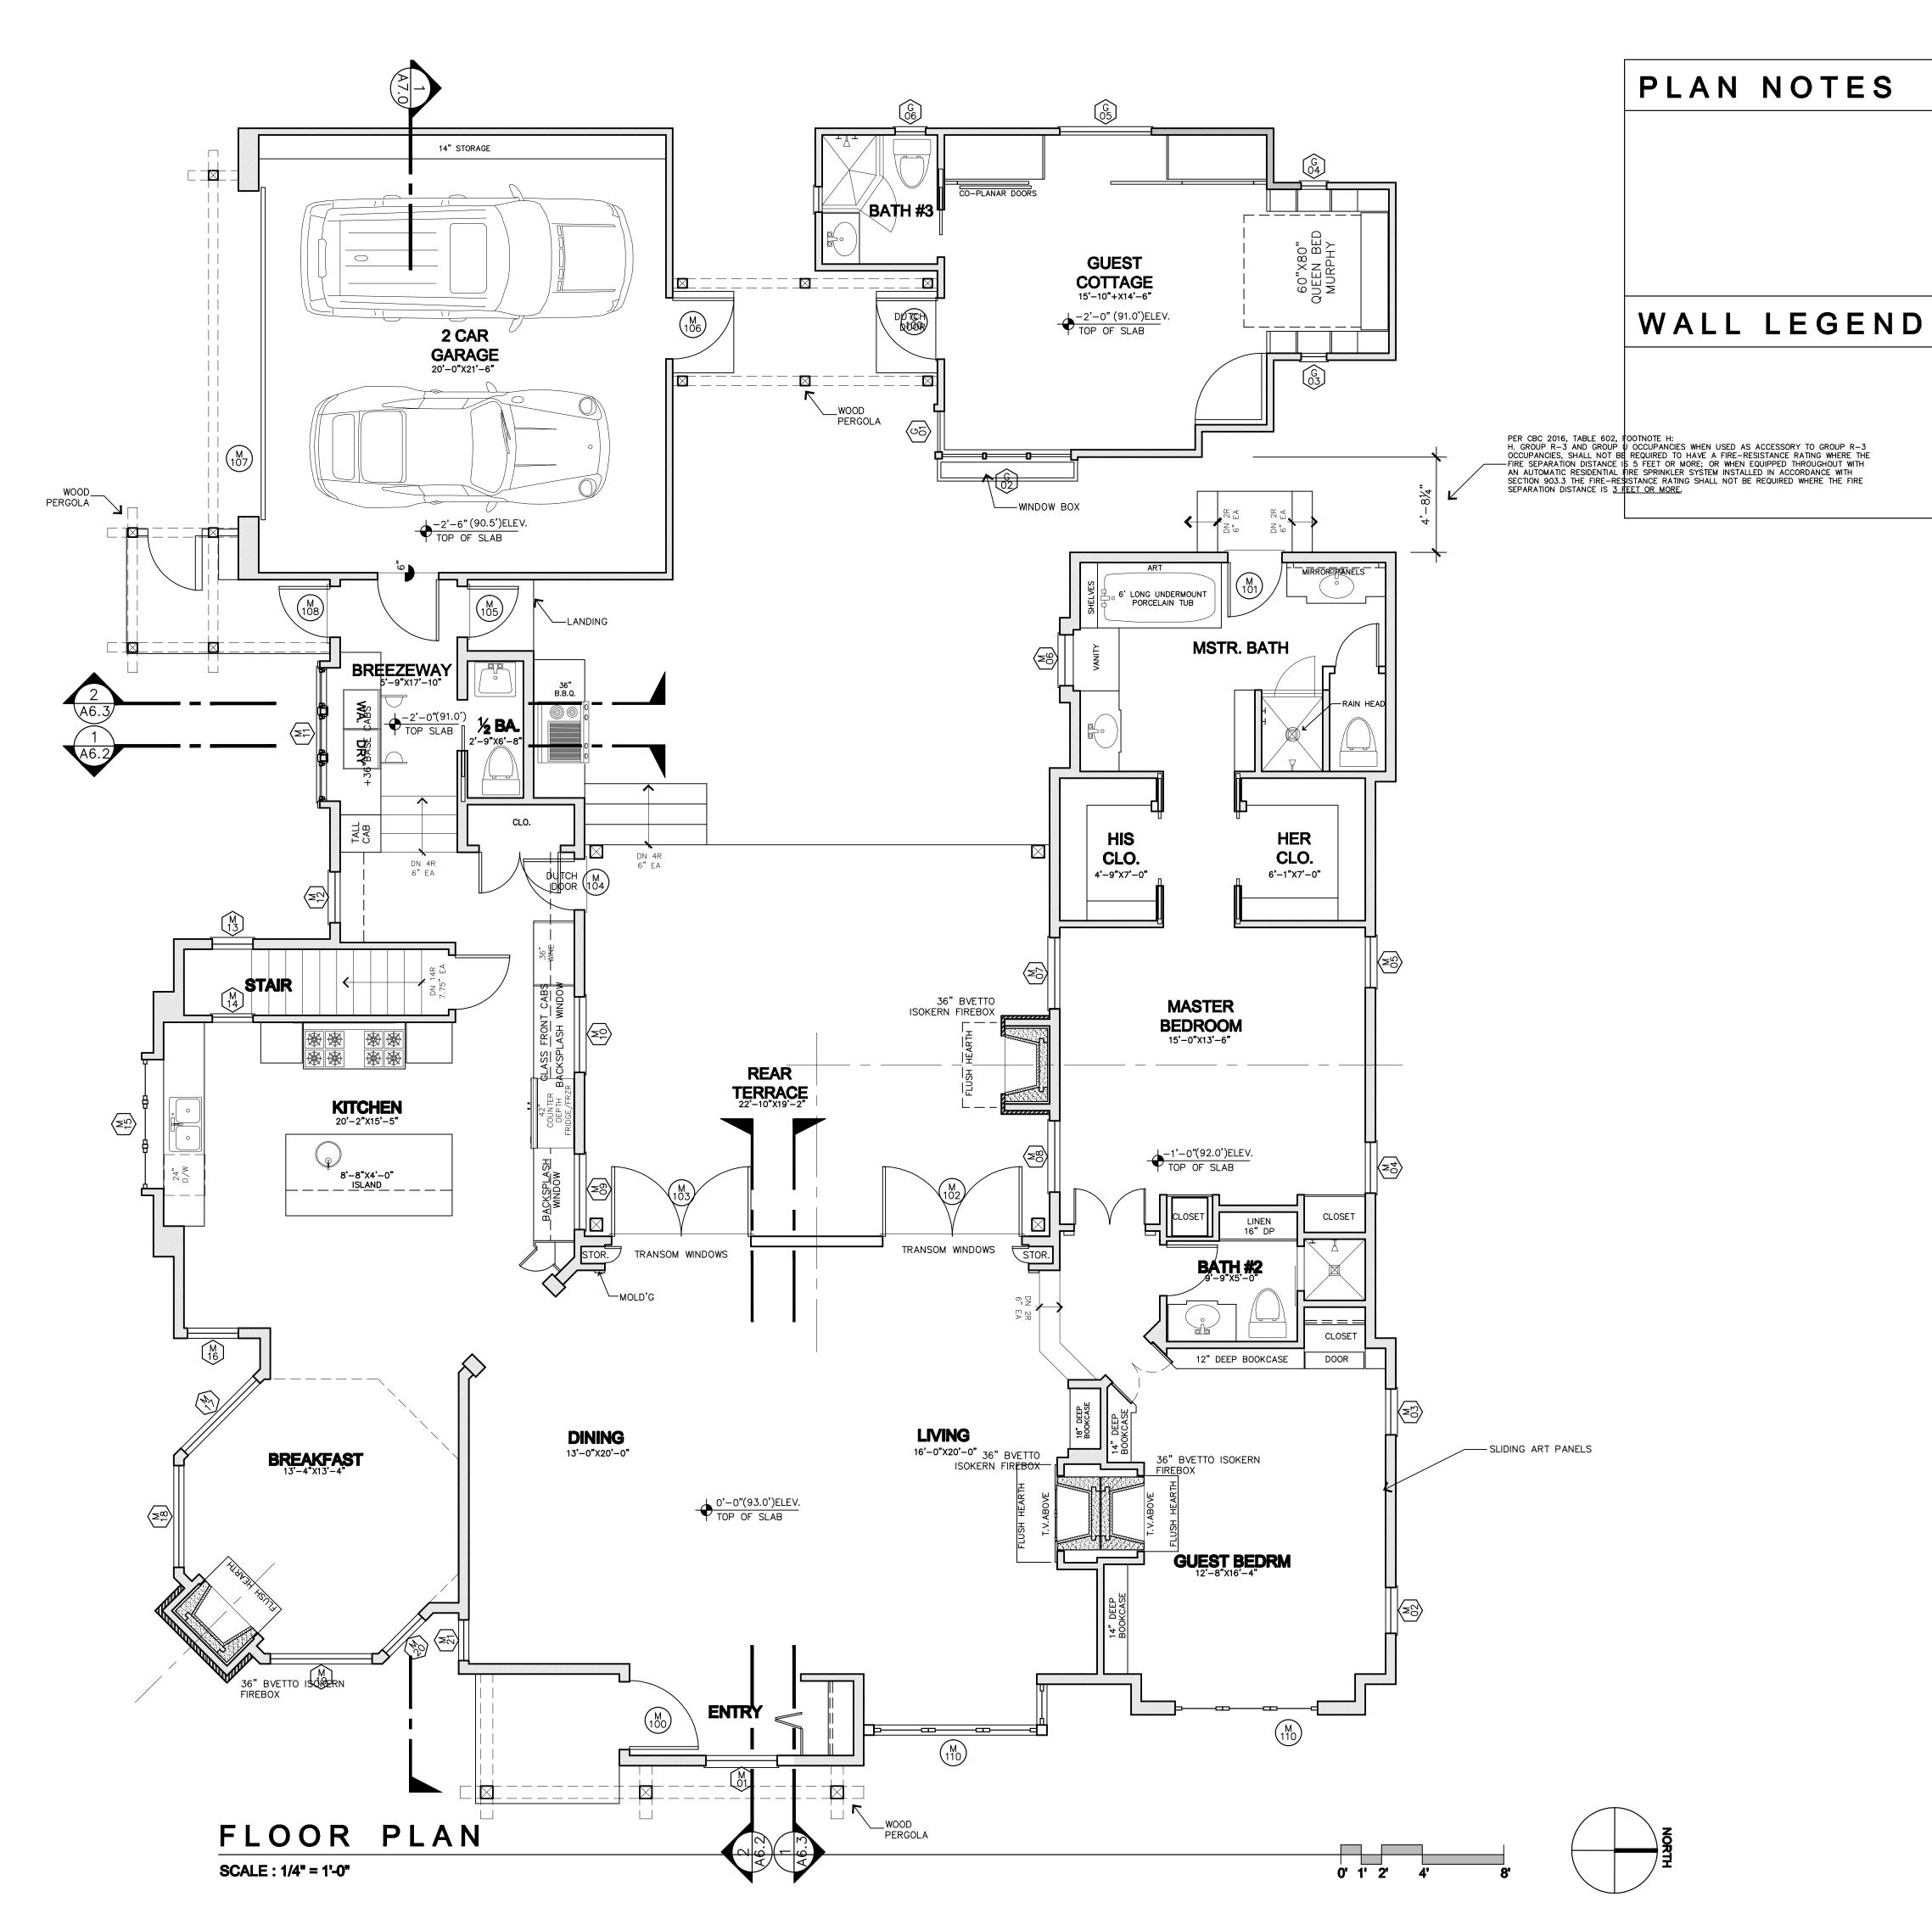
ISSUE REVISIONS
1 06-27-18 PRELIM. REVIEW
2 07-03-18 FOREST & BEACH COMM
3 12-05-18 PLANNING SUBMITTAL
4 01-23-19 FINAL PLANNING REVIEW
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DATE

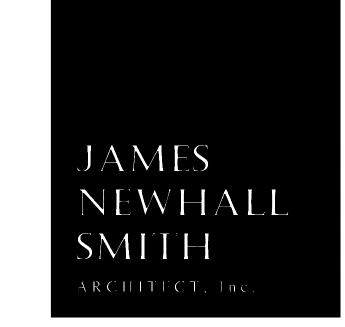
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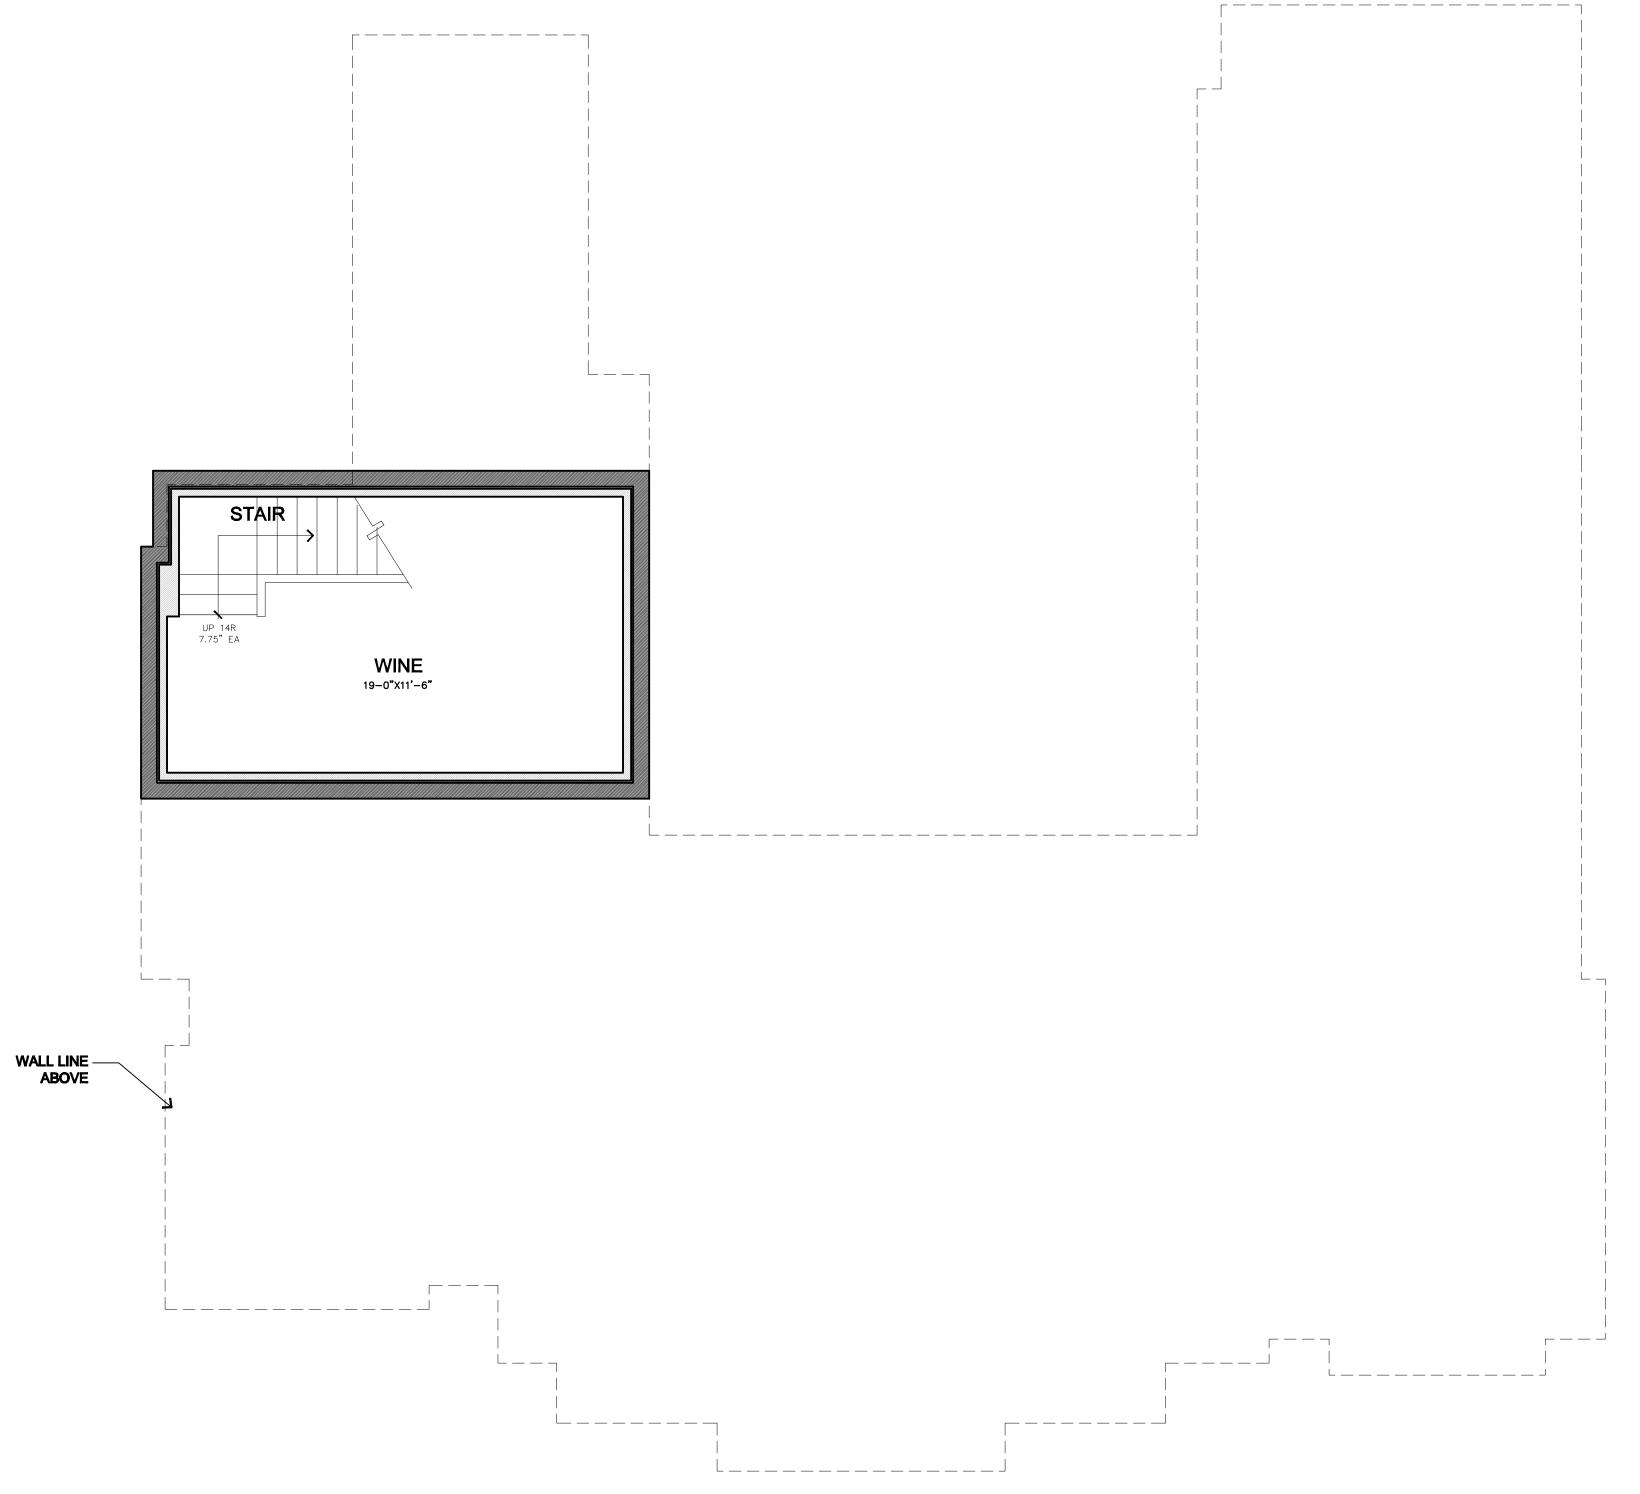
FLOOR PLAN

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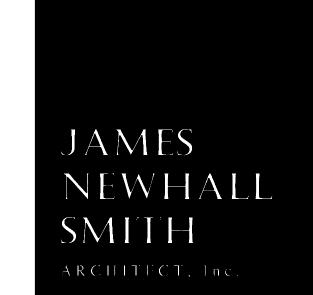
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PLAN NOTES

WALL LEGEND



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LOWER LEVEL FLOOR PLAN

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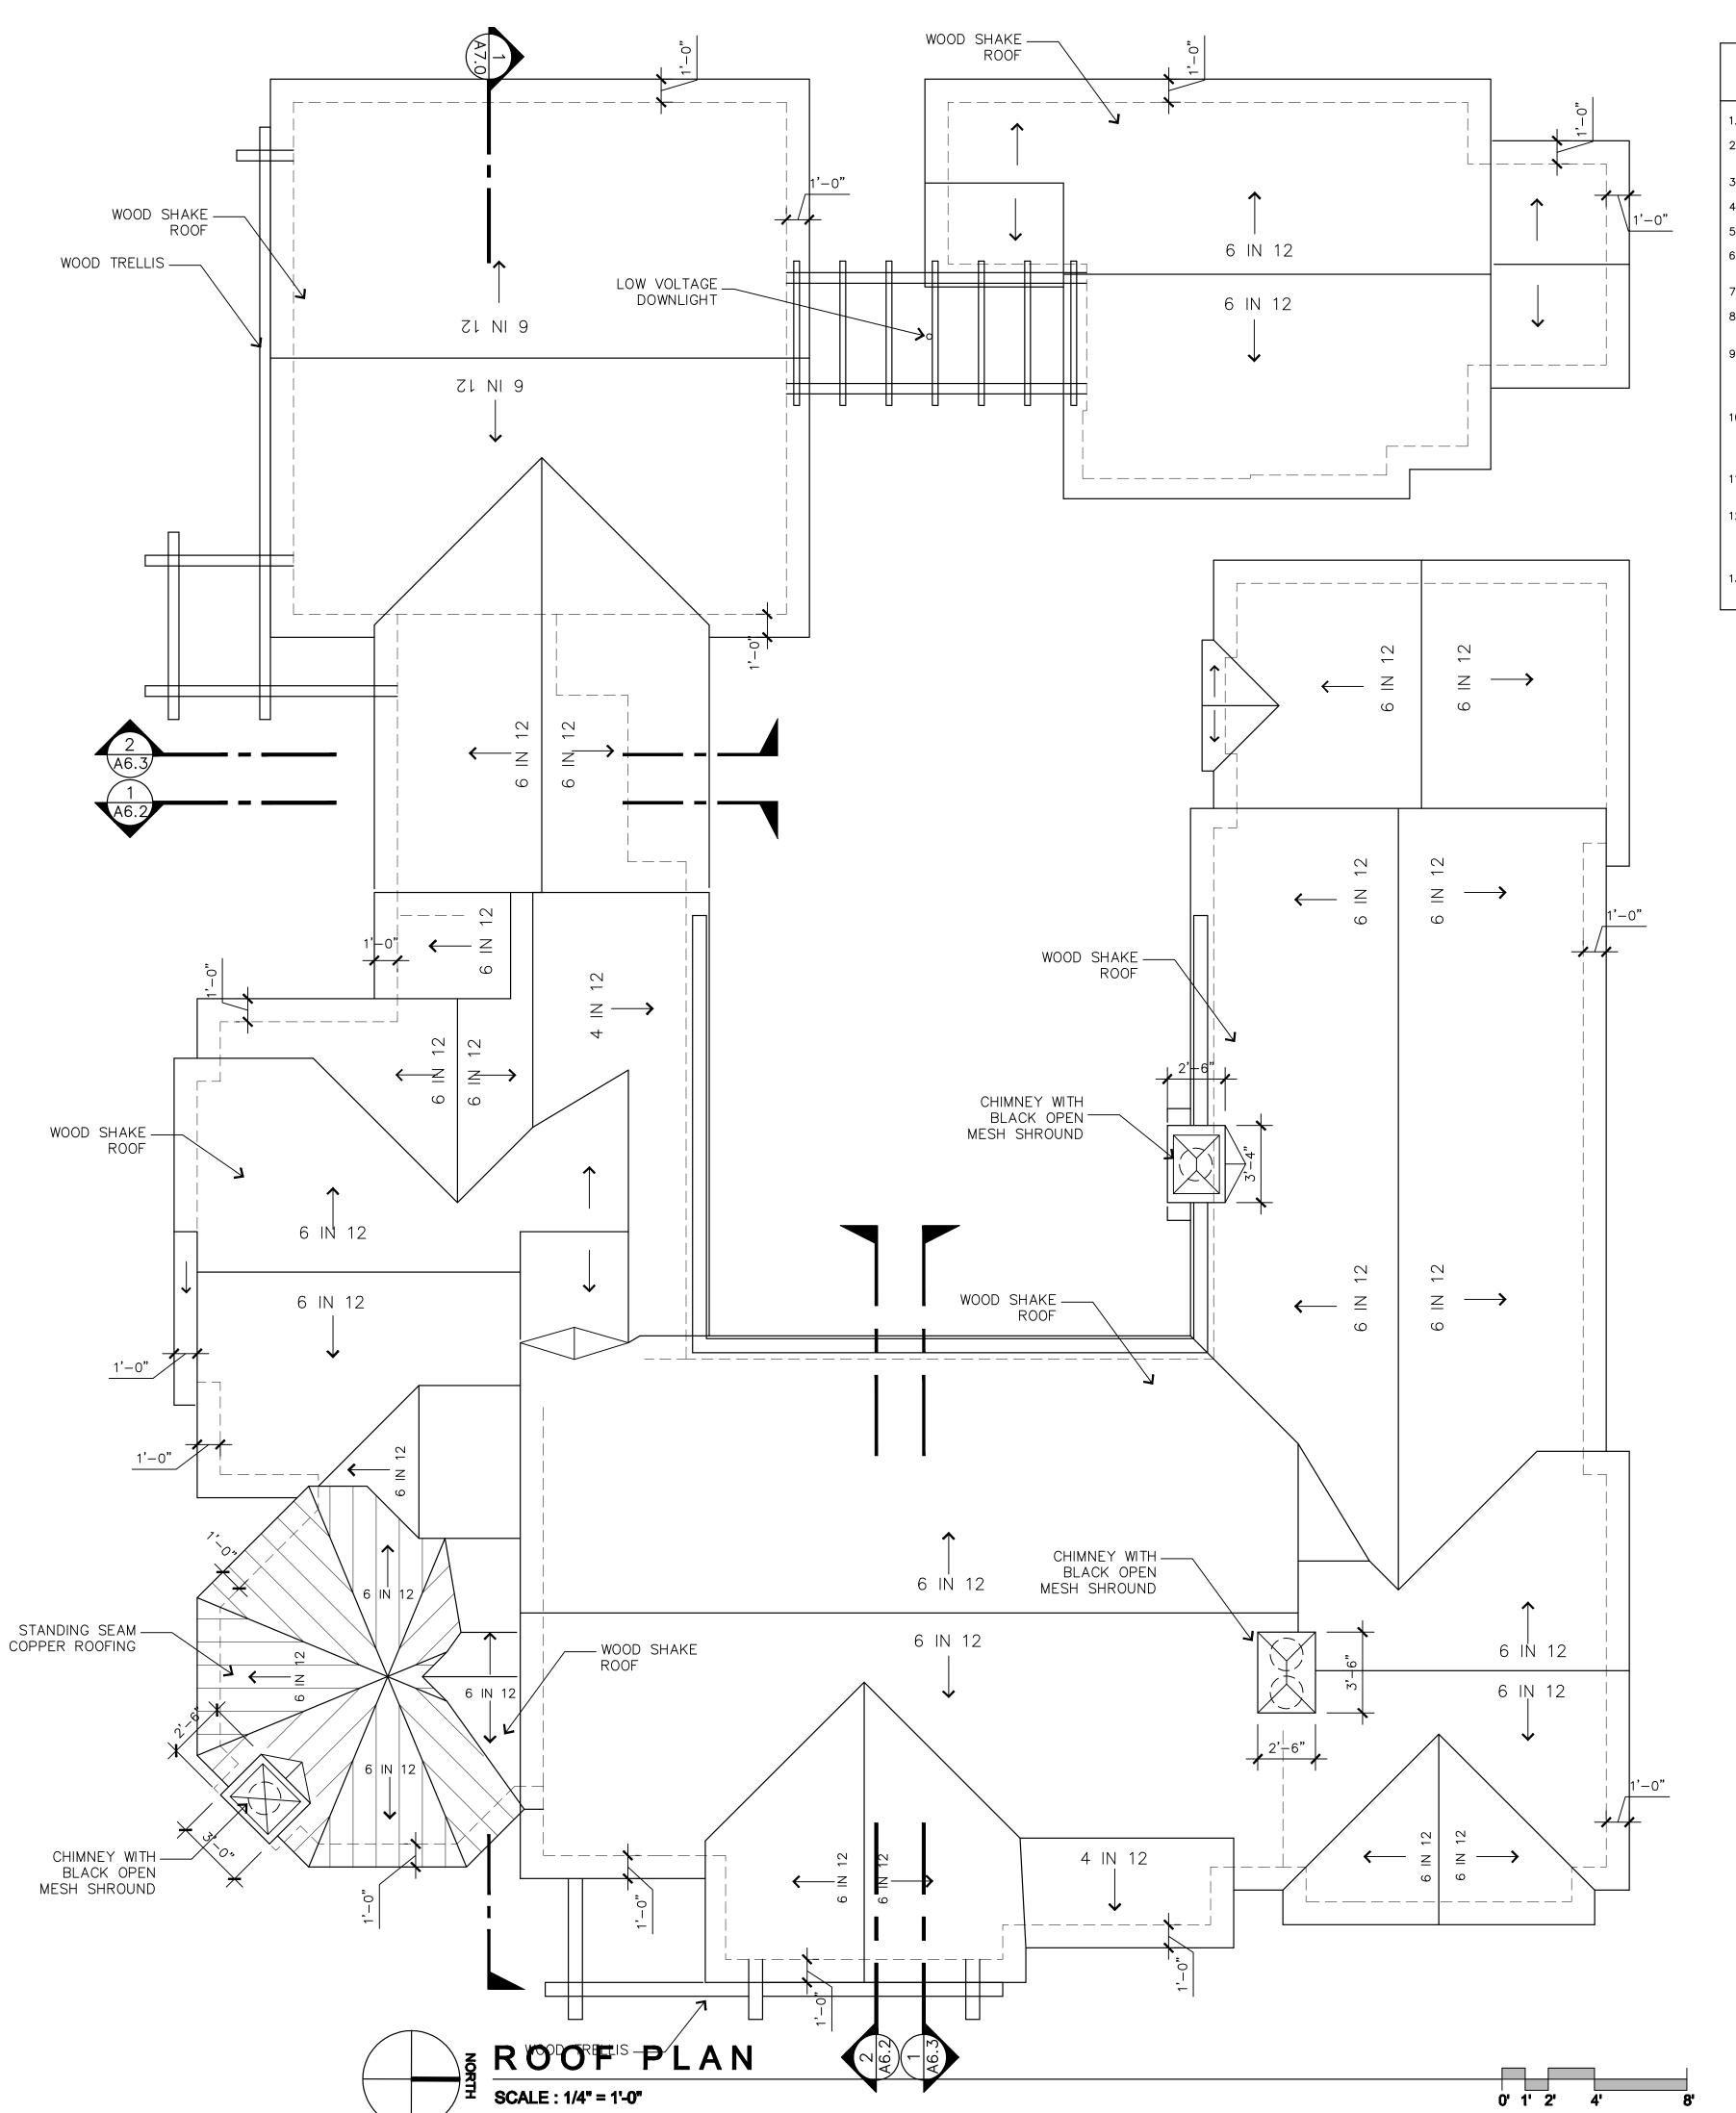
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LOWER LEVEL PLAN

SCALE: 1/4" = 1'-0"





ROOF PLAN NOTES

- 1. ROOF MATERIAL TO BE STANDING SEAM METAL ROOFING
- 2. FIELD VERIFY WITH OWNER AND ARCHITECT COLOR AND/OR BLEND OF ROOFING UNITS PRIOR TO INSTALLATION
- . ROOF SLOPE = 1 IN 12 UNLESS OTHERWISE NOTED
- 4. OVERHANG = 12" UNLESS OTHERWISE NOTED
- 5. COPPER OR ZINC GUTTERS WITH ROUND DOWNSPOUTS
- 6. GANG ALL VENT STACKS TO MINIMIZE QUANTITY OF ROOF JACKS AND LOCATE ROOF JACKS IN LEAST VISIBLE LOCATION
- SPARK ARRESTOR TO BE 3 TIMES THE NET FREE OPENING OF THE CHIMNEY OUTLET
 CHIMNEY SHALL BE 2' ABOVE THE HIGHEST POINT OF THE ROOF WITHIN 10' MEASURED
- HORIZONTALLY

 METAL CHIMNEYS SHALL BE ANCHORED AT EACH FLOOR AND AT THE ROOF WITH (2)
- 1-1/2"x%" S.S. METAL STRAPS LOOPED AROUND THE CHIMNEY AND NAILED WITH NOT LESS THAN (6) 8d NAILS PER STRAP AT EACH JOIST OR RAFTER PER UBC 3102.6 TO PREVENT LATERAL DISPLACEMENT.

 10. EACH BUNDLE OF ROOFING SHALL BEAR LABELS FROM AN ICBO ACCREDITED QUALITY CONTROL AGENCY IDENTIFYING THEIR ROOF COVERING CLASSIFICATION AND INDICATING
- CONTAINED IN HEALTH AND SAFETY CODE SECTION 13132.70 (R902.2 CRC)

 ALL PLUMBING VENTS TO BE A MINIMUM 10 FEET AWAY FROM, OR AT LEAST 3 FEET ABOVE ANY OPERABLE SKYLIGHTS PER CPC 906.2.

THEIR COMPLIANCE WITH ICC-ES-EG107 AND WITH THE WEATHERING REQUIREMENTS

- 2. PER C.B.C. CHAPTER 7A (ROOF EDGE) AND CHAPTER 15 (ROOF FIELD), LARGE GAPS BETWEEN THE ROOF COVERING AND THE ROOF DECK (SHEATHING) MUST BE PLUGGED TO PREVENT EMBER OR FLAME INTRUSION. EXAMPLE: BIRD—STOPS OR MORTAR FOR BARREL THE ROOFS AT FAVES.
- 13. DOWNSPOUTS SHALL BE ROUTED VIA TIGHT-LINE TO ON-SITE DISPERSAL AREAS AND/OR STORM DRAINS AS PER CITY STANDARDS



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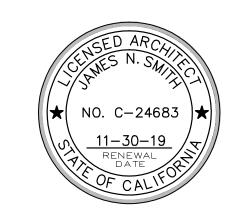
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ROOF PLAN

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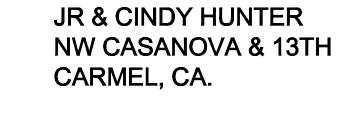


EAST ELEVATION SCALE: N.T.S.



SCALE: N.T.S.





JAMES

SMITH

SUITE C

PROJECT/CLIENT

HUNTER

RESIDENCE

93950

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NEWHALL

716 LIGHTHOUSE AVE.

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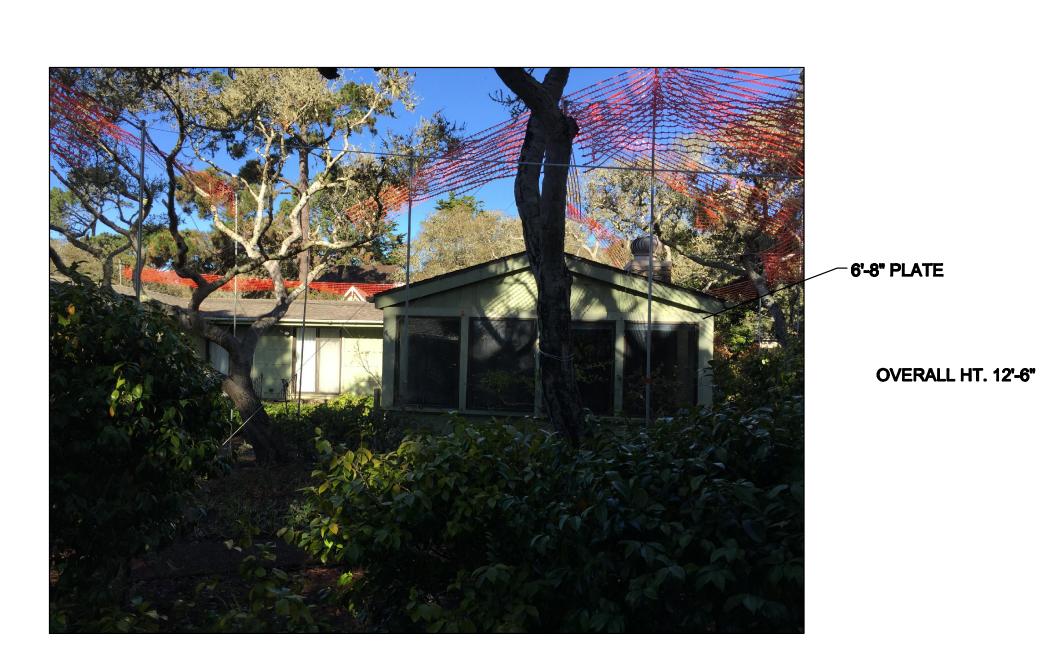
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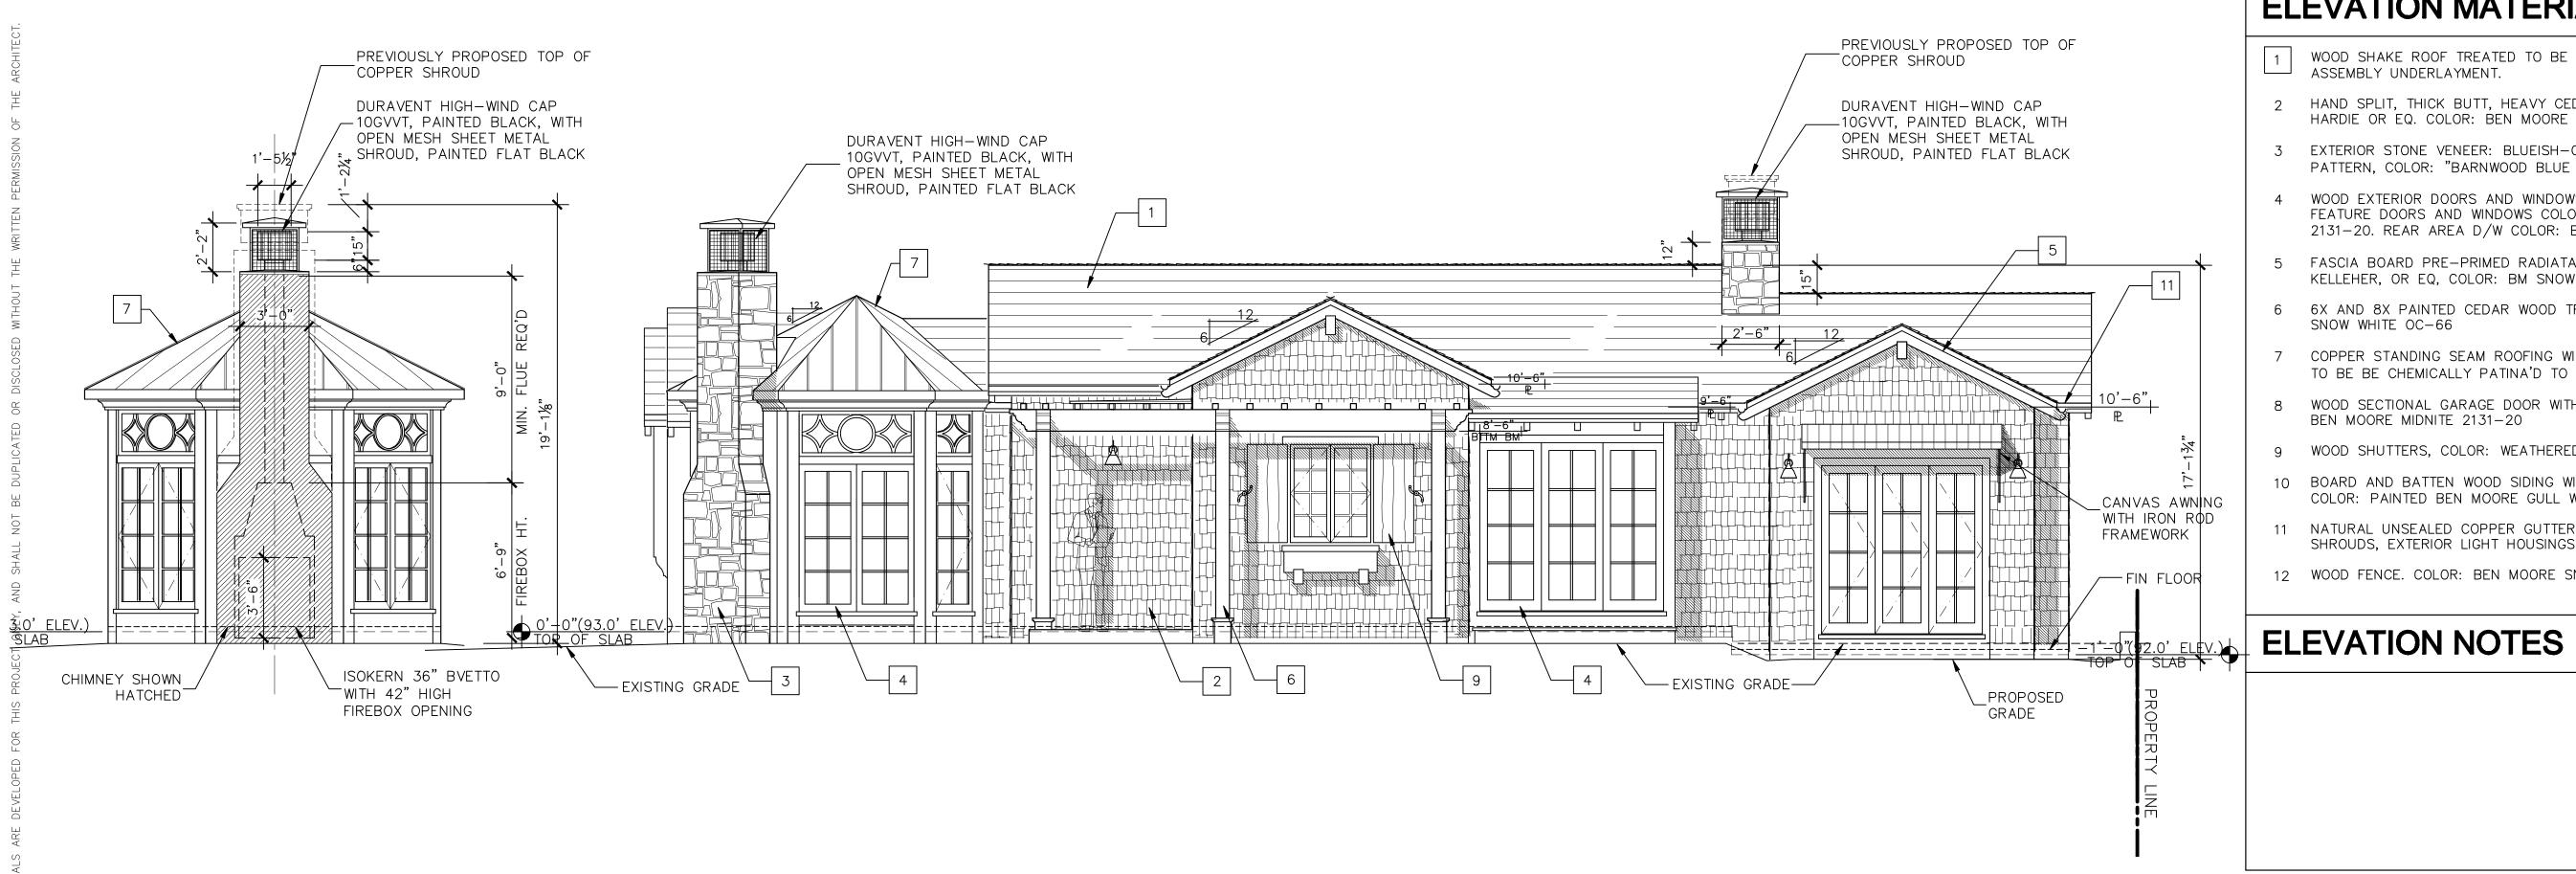
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SOUTH ELEVATION



EAST ELEVATION- CASANOVA AVE

ELEVATION MATERIALS LEGEND

- WOOD SHAKE ROOF TREATED TO BE CLASS 'B' WITH A CLASS 'A' ASSEMBLY UNDERLAYMENT.
- 2 HAND SPLIT, THICK BUTT, HEAVY CEDAR COMBED SHAKES BY JAMES HARDIE OR EQ. COLOR: BEN MOORE SNOW WHITE OC-66
- 3 EXTERIOR STONE VENEER: BLUEISH-GREY, BEUCHEL "CASTLE ROCK" PATTERN, COLOR: "BARNWOOD BLUE CASTLE ROCK"
- 4 WOOD EXTERIOR DOORS AND WINDOWS BY BEND RIVER, OR EQUAL. FEATURE DOORS AND WINDOWS COLOR: BEN MOORE MIDNITE 2131-20. REAR AREA D/W COLOR: BEN MOORE SNOW WHITE OC-66
- 5 FASCIA BOARD PRE-PRIMED RADIATA PINE "ADVANTAGE PLUS" BY KELLEHER, OR EQ, COLOR: BM SNOW WHITE
- 6X AND 8X PAINTED CEDAR WOOD TRELLISES. COLOR: BEN MOORE SNOW WHITE OC-66
- COPPER STANDING SEAM ROOFING WITH SEAMS AT 12" O.C. COPPER TO BE BE CHEMICALLY PATINA'D TO A MOTTLED BROWN
- WOOD SECTIONAL GARAGE DOOR WITH T.G. GLASS PANELS, COLOR: BEN MOORE MIDNITE 2131-20
- 9 WOOD SHUTTERS, COLOR: WEATHERED GREEN
- 10 BOARD AND BATTEN WOOD SIDING WITH 1X4 BATTENS AT 16" O.C. COLOR: PAINTED BEN MOORE GULL WING GREY 2134-50
- 11 NATURAL UNSEALED COPPER GUTTERS, DOWNSPOUTS, CHIMNEY SHROUDS, EXTERIOR LIGHT HOUSINGS AND FLASHING
- 12 WOOD FENCE. COLOR: BEN MOORE SNOW WHITE OC-66

JAMES NEWHALL ARCHITECT, Inc.

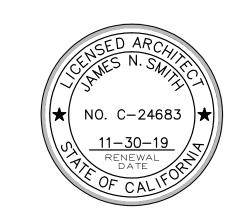
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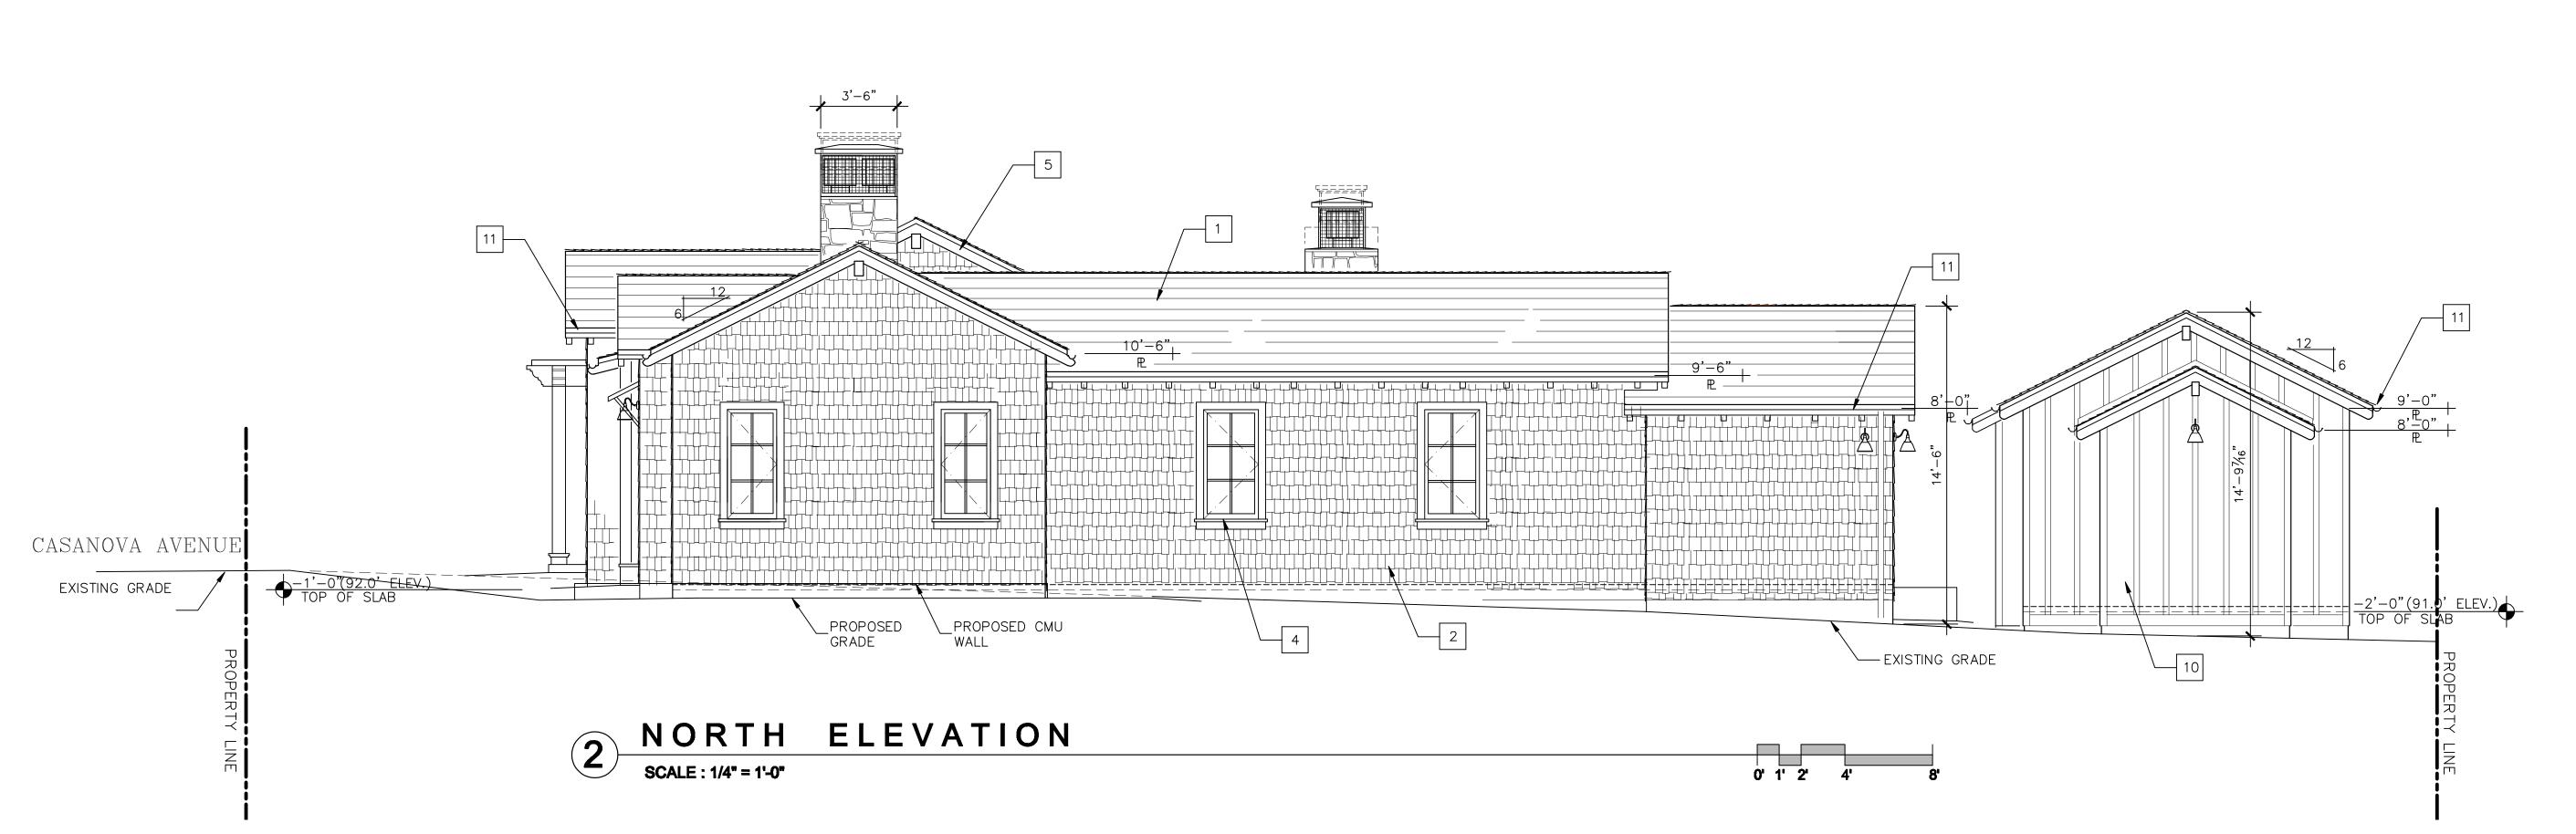
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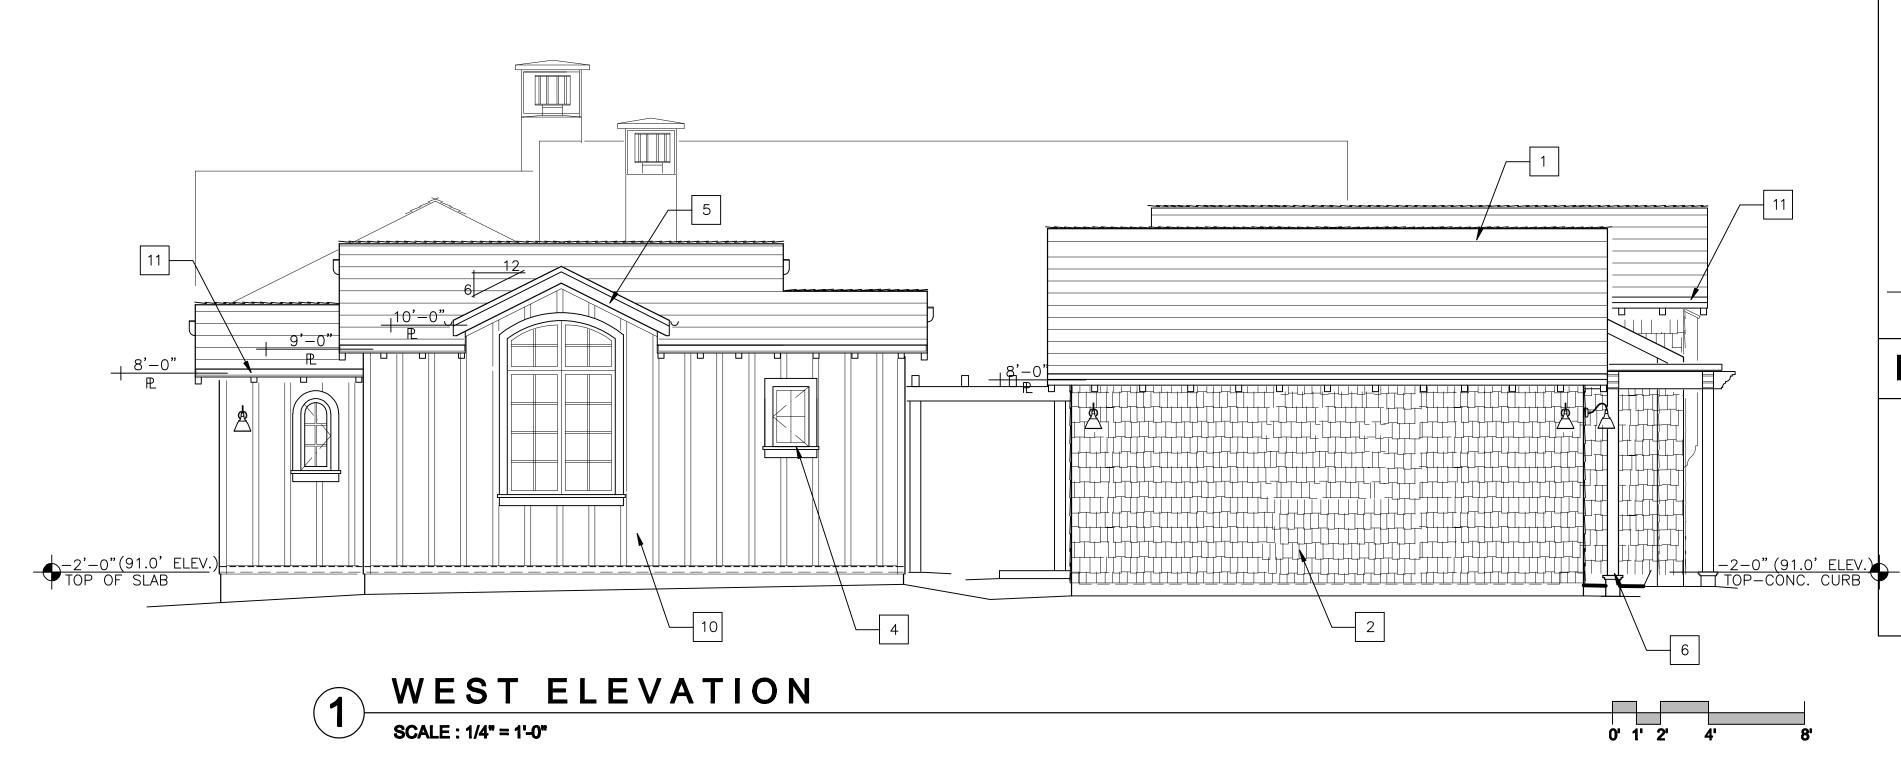
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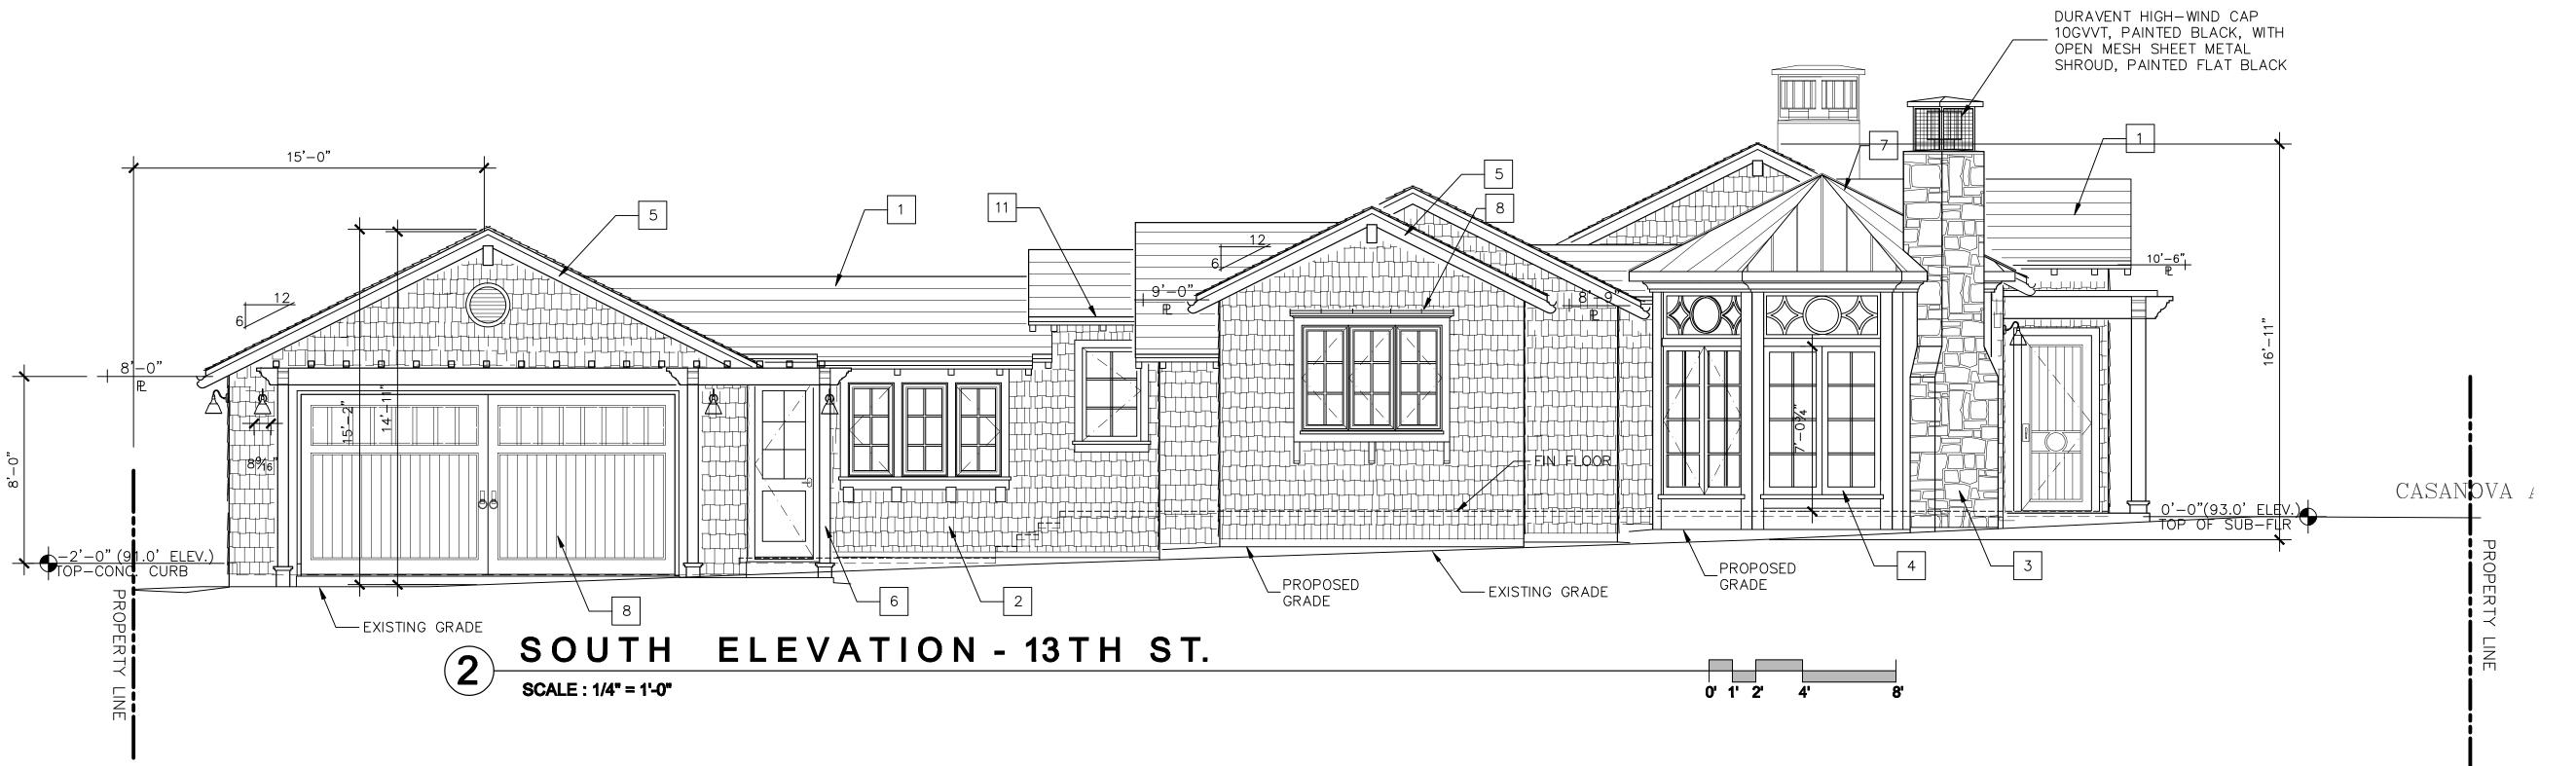
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- 12 WOOD FENCE. COLOR: BEN MOORE SNOW WHITE OC-66

ELEVATION NOTES

JAMES
NEWHALL
SMITH
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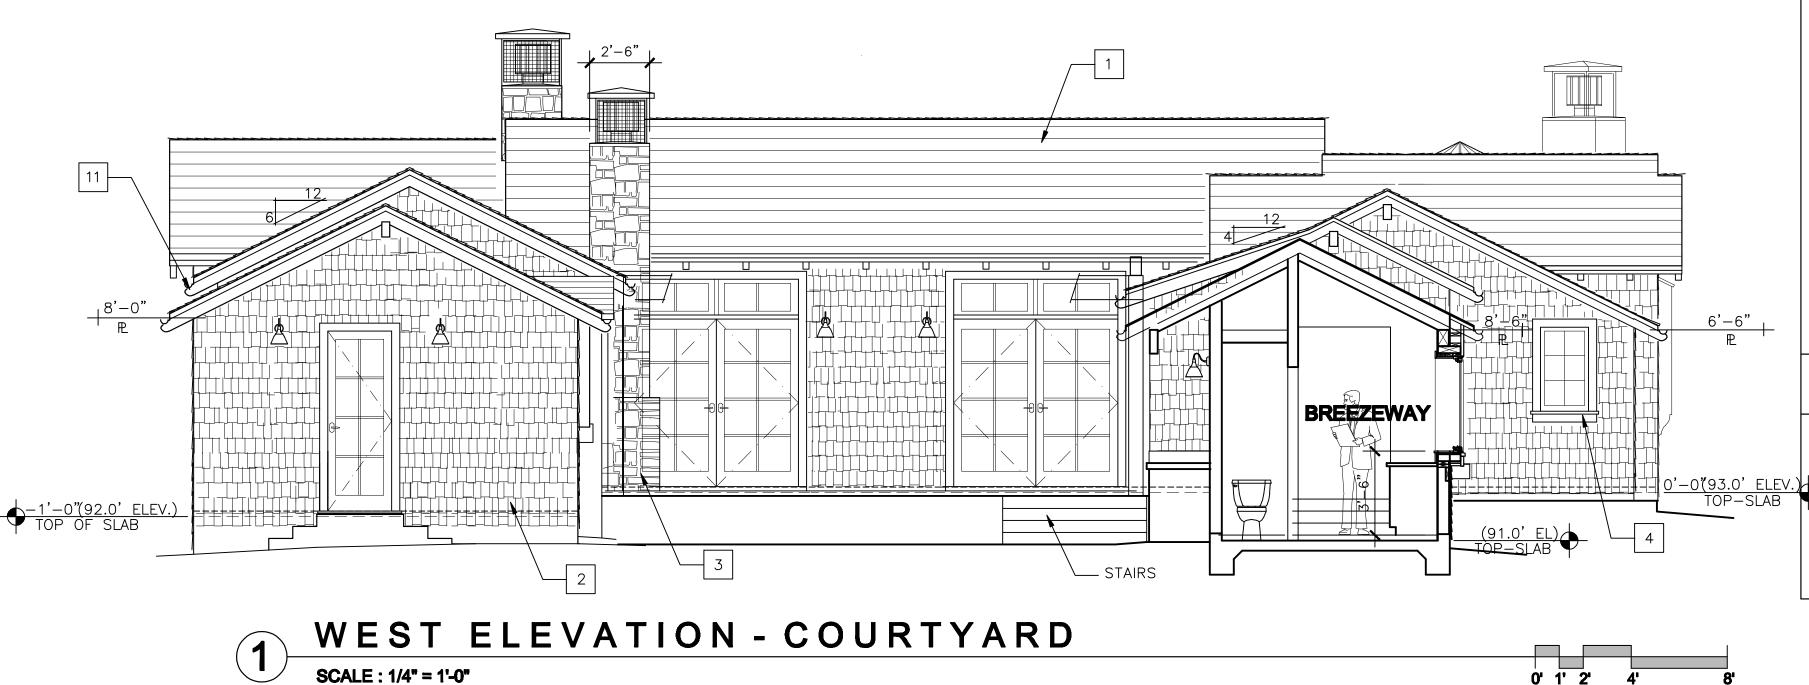
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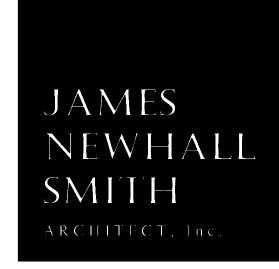
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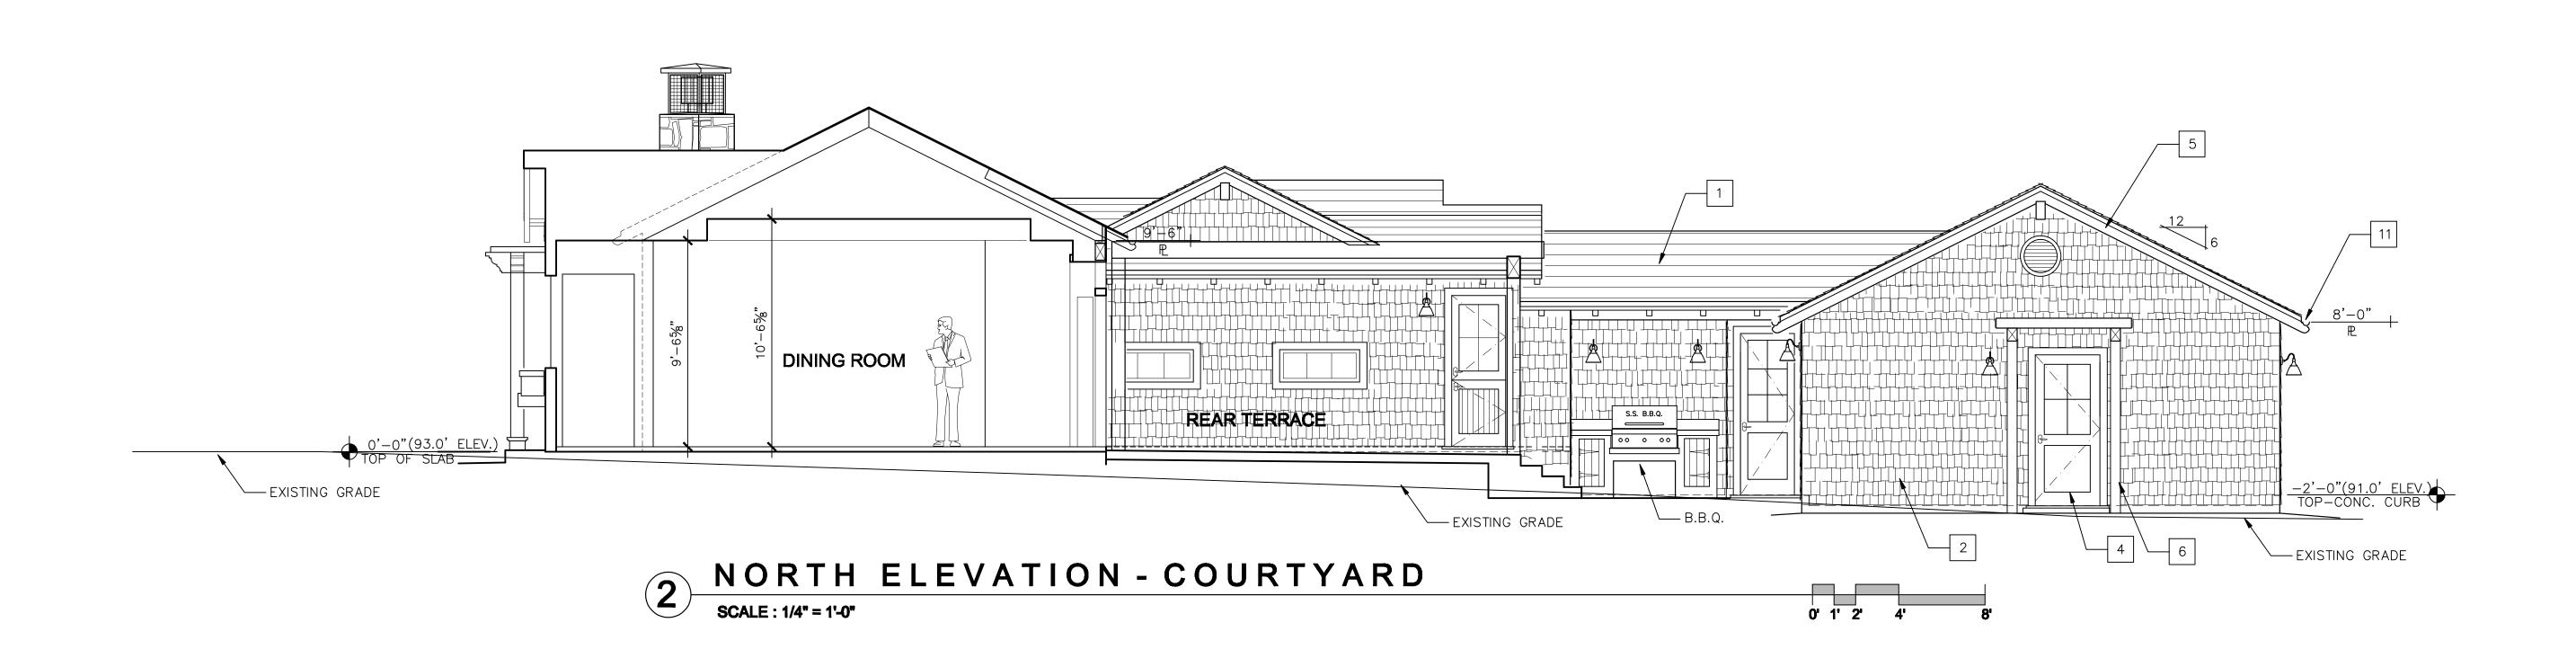
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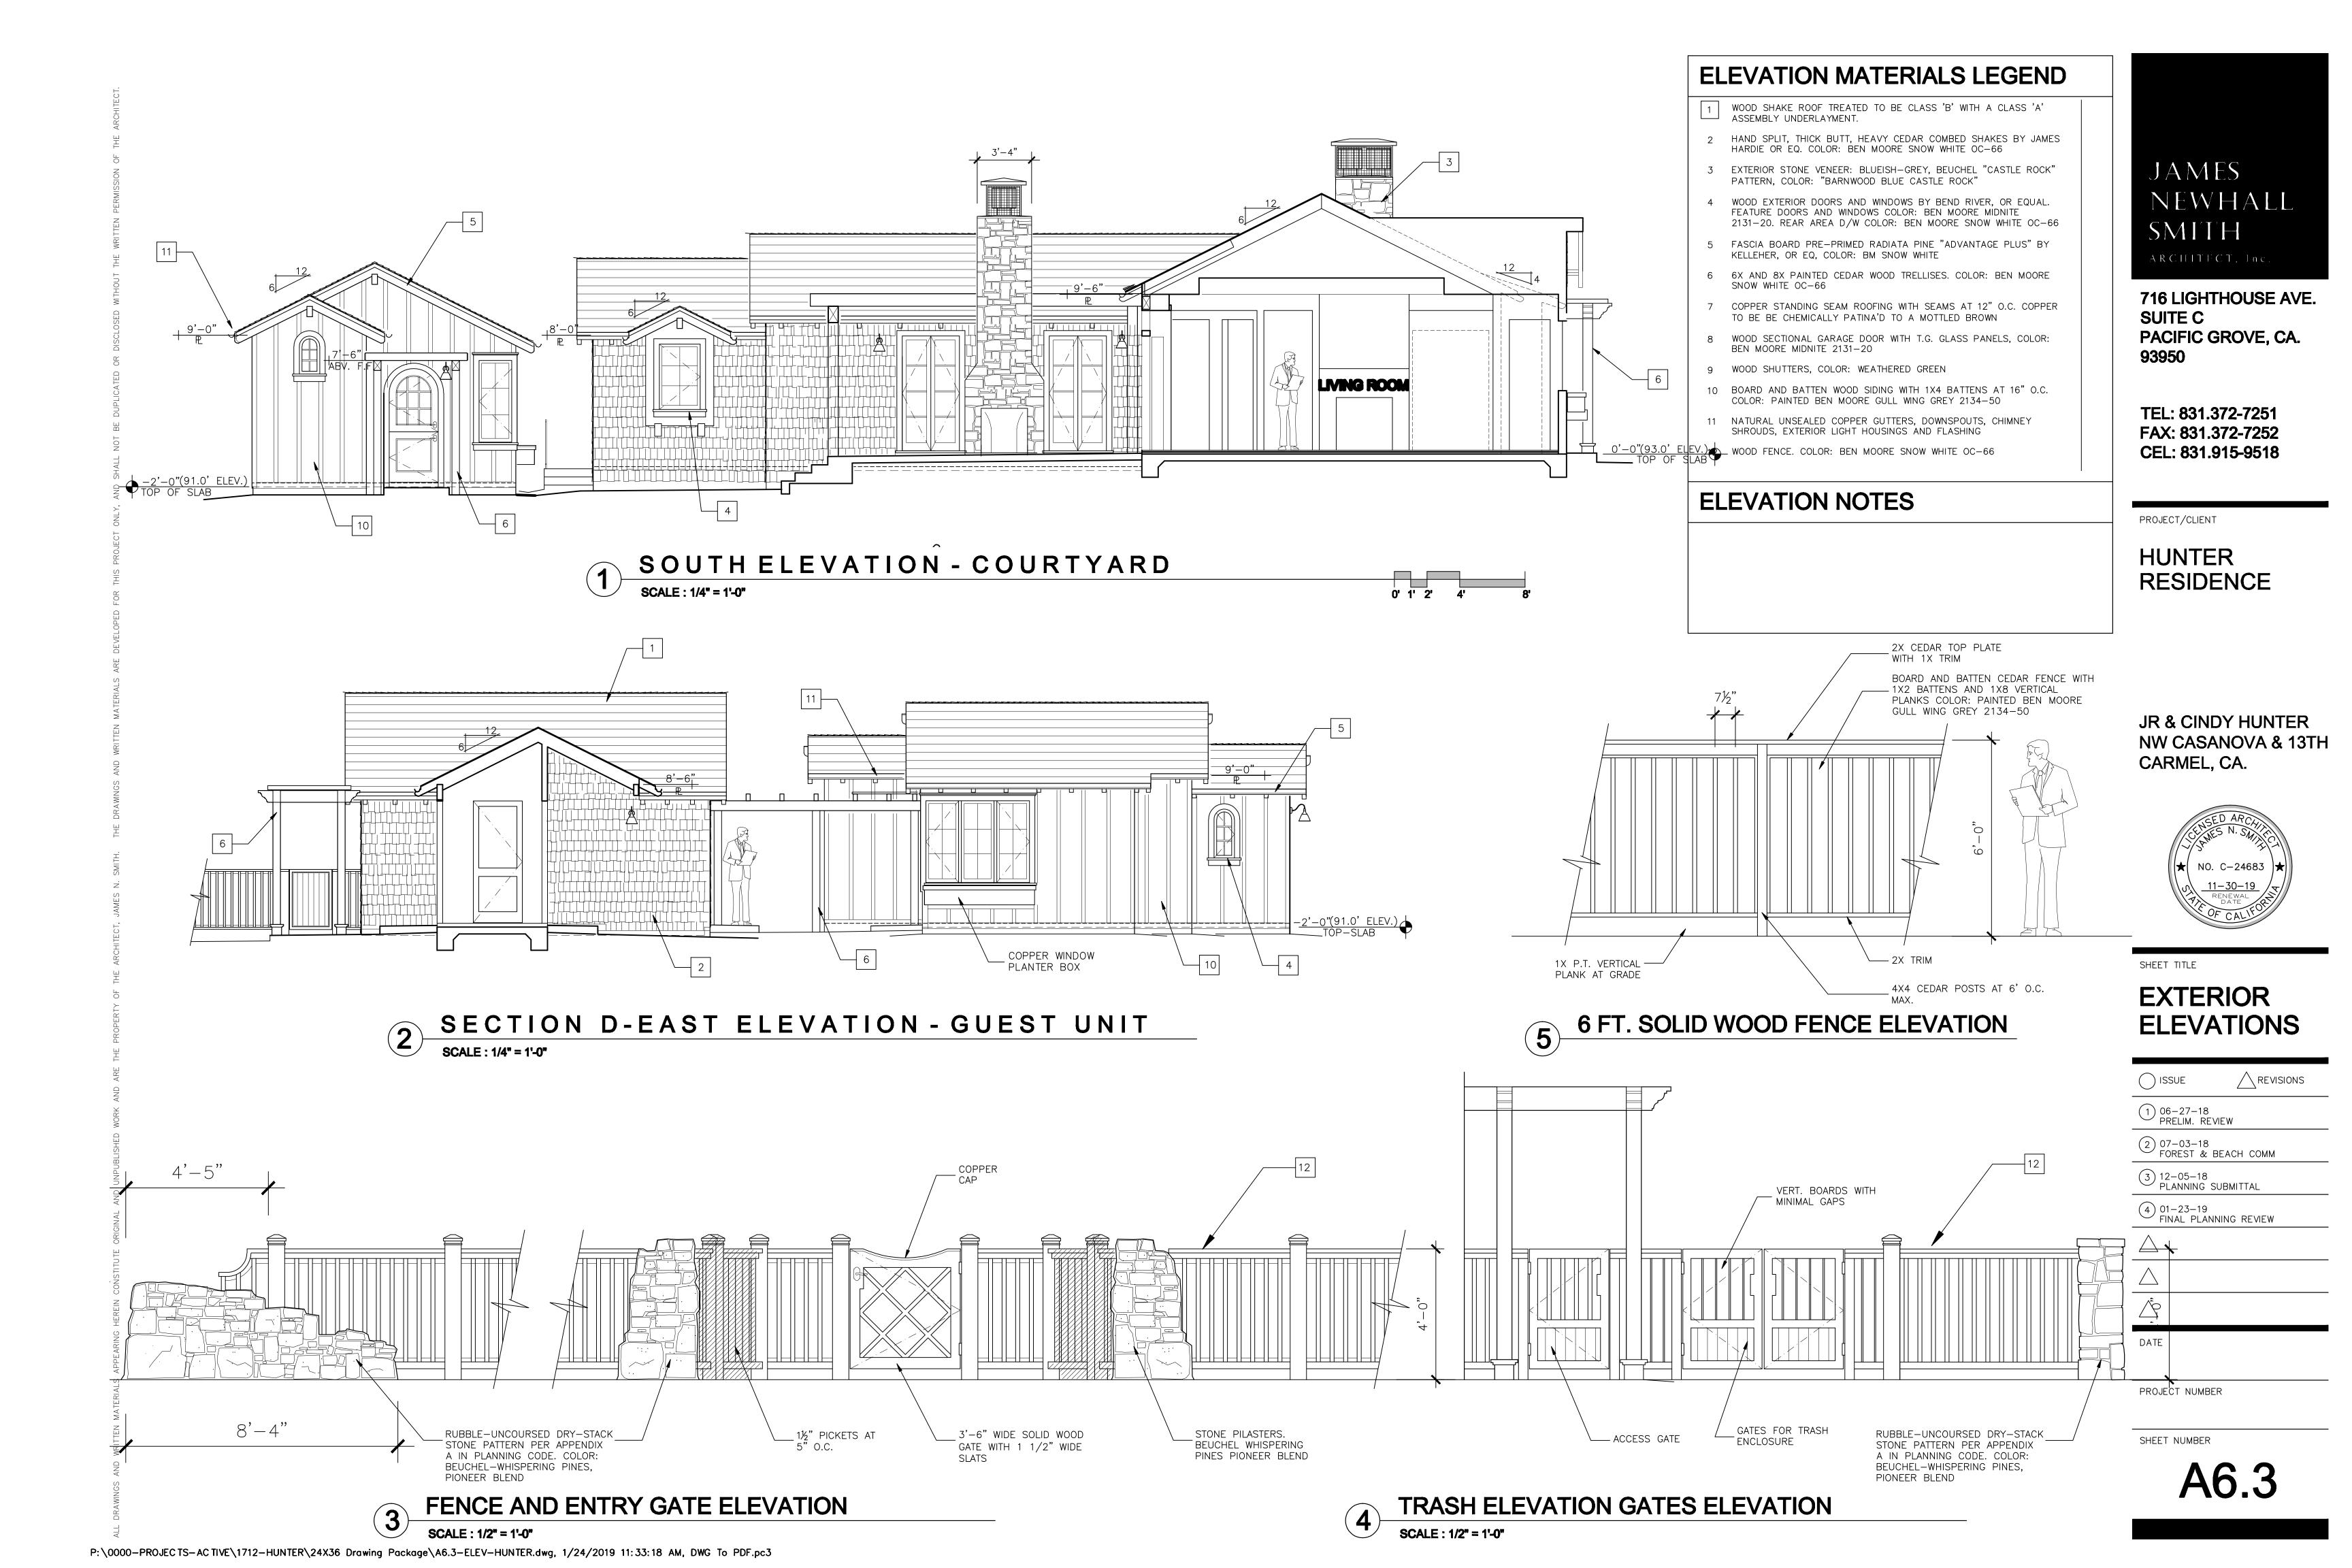
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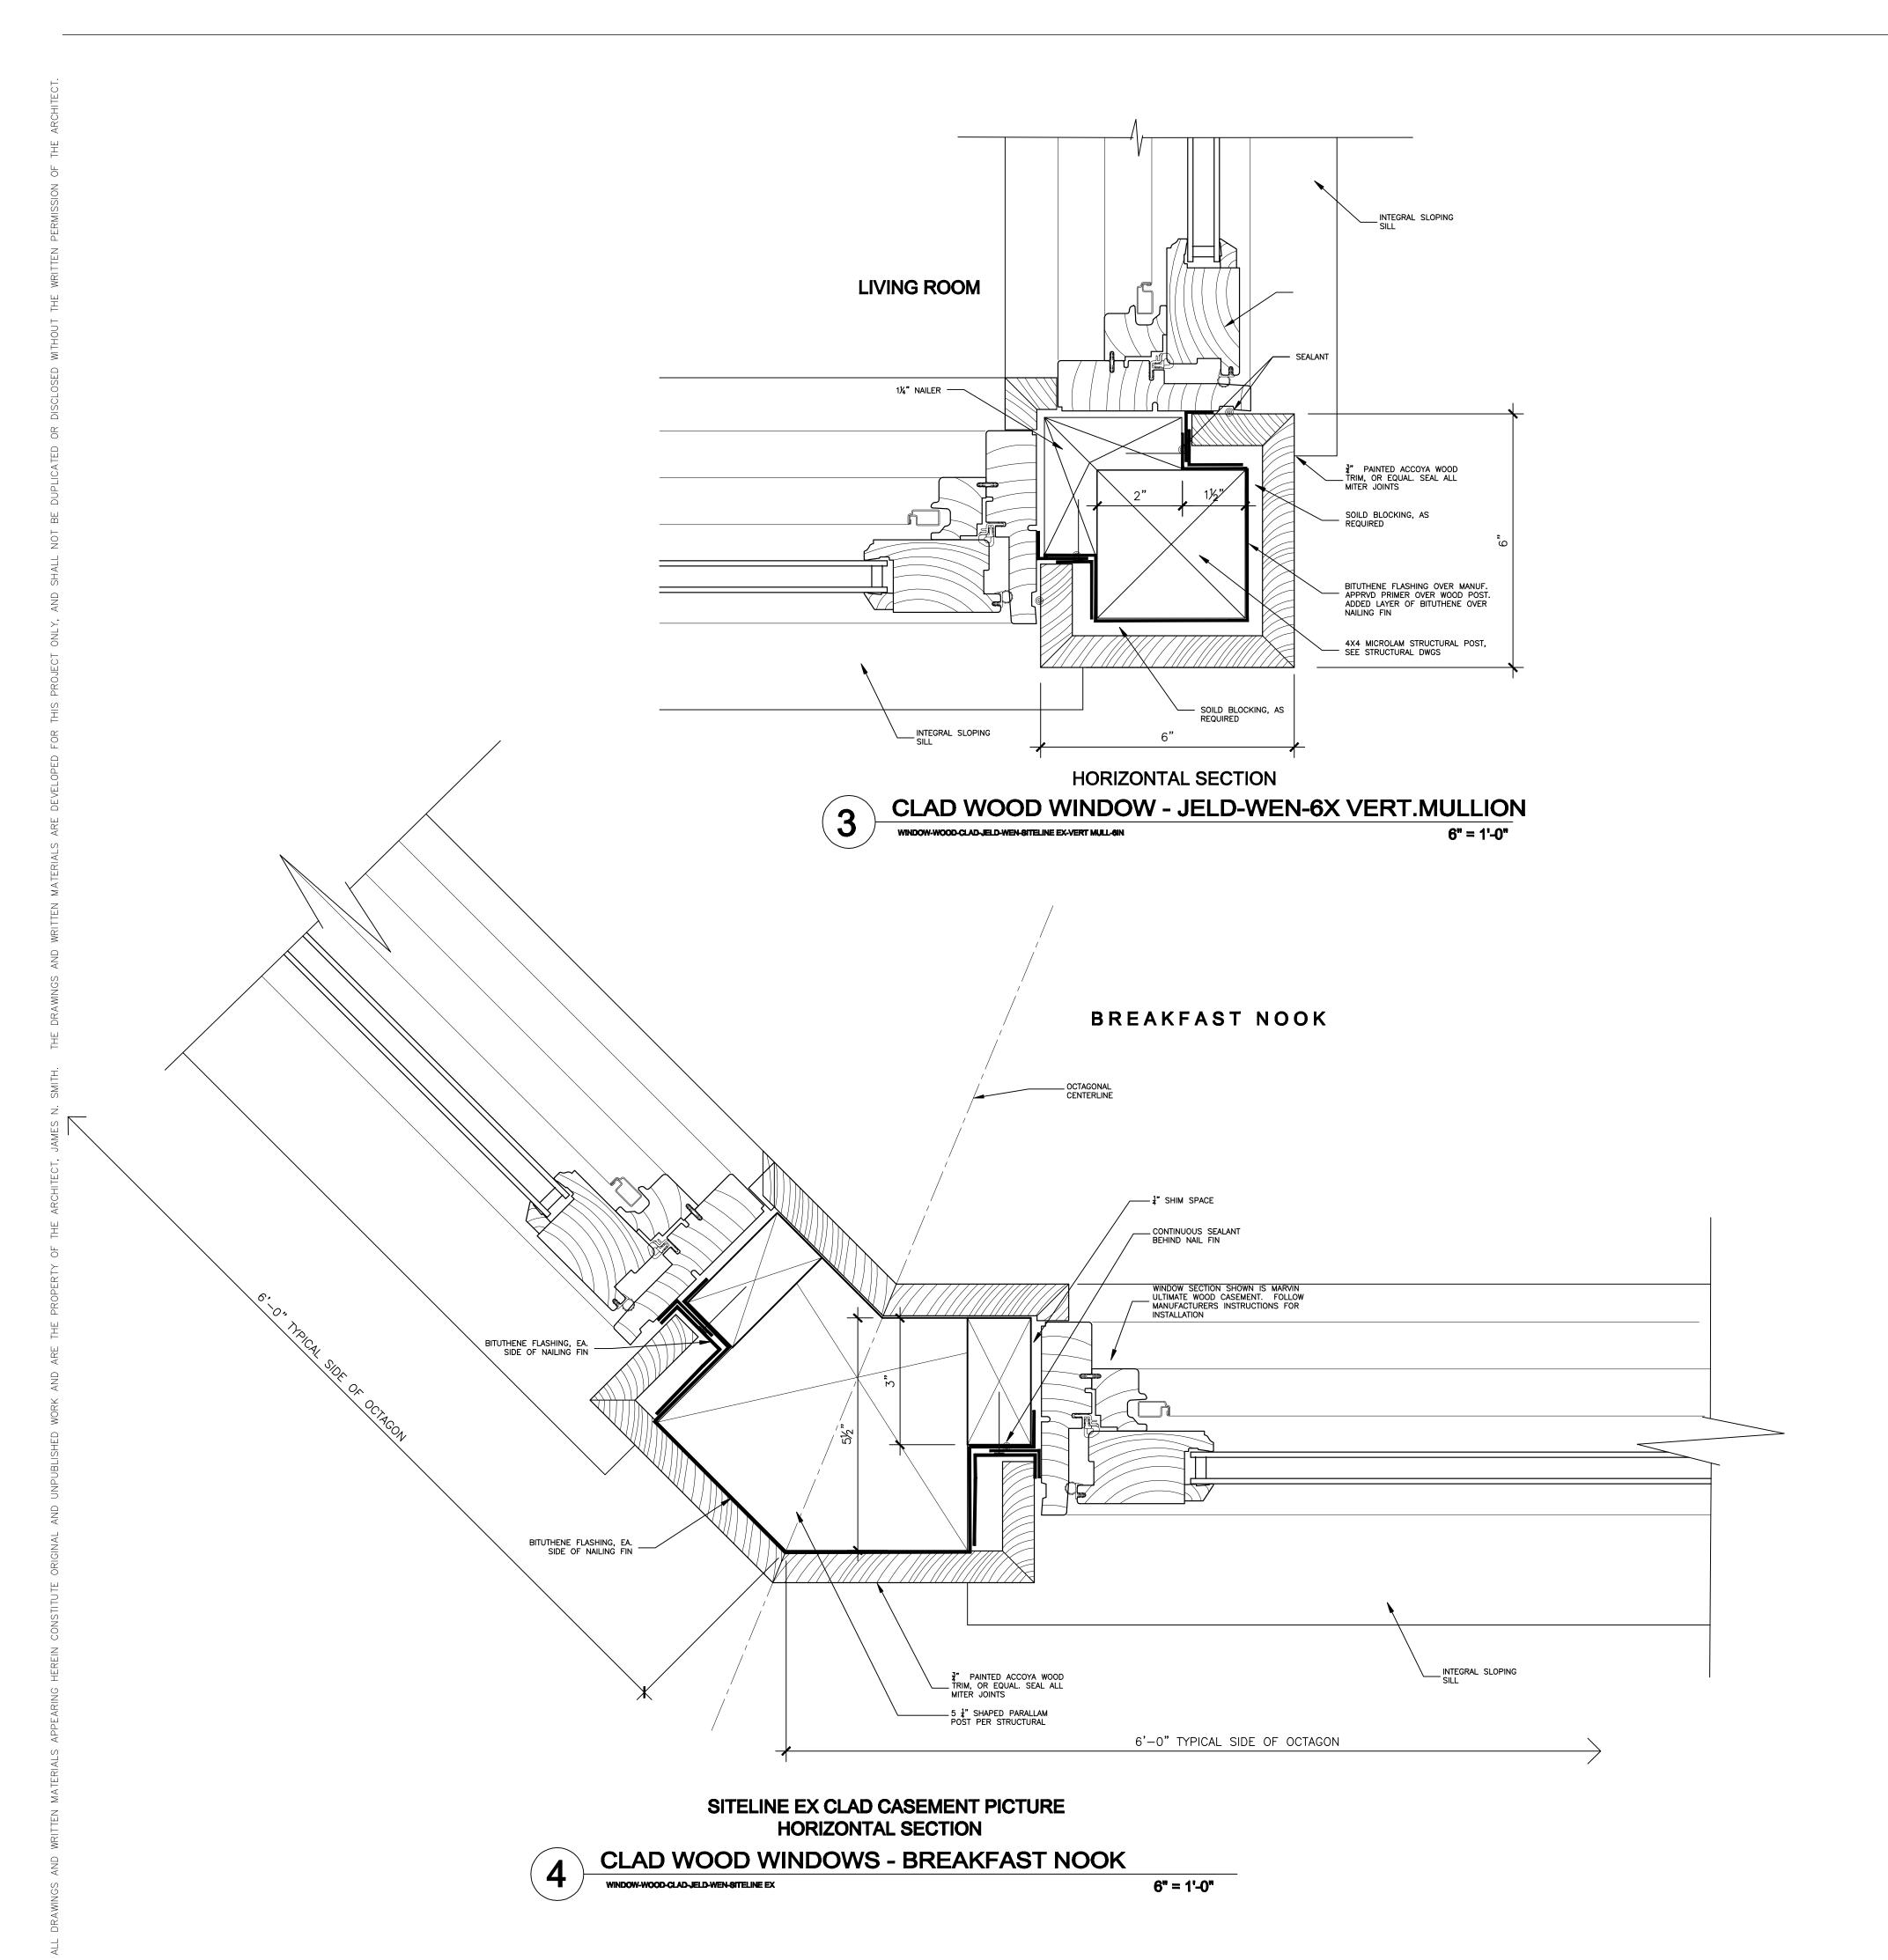
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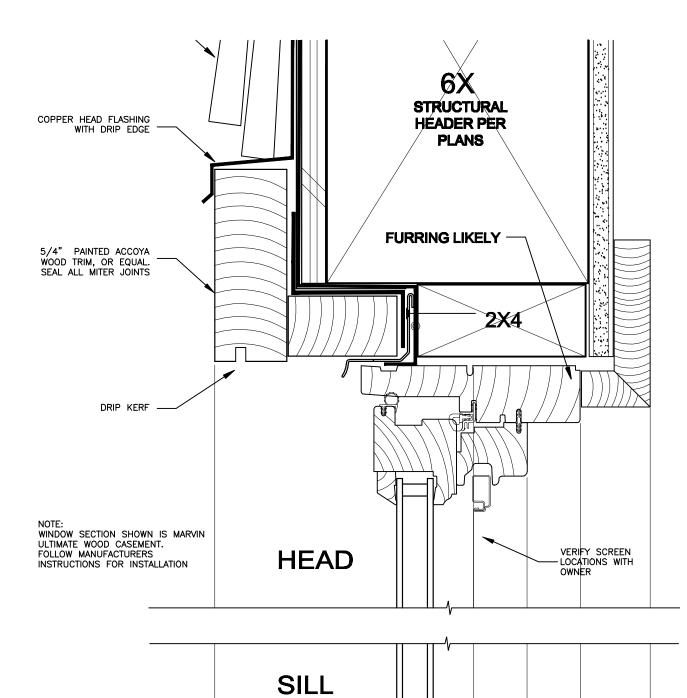


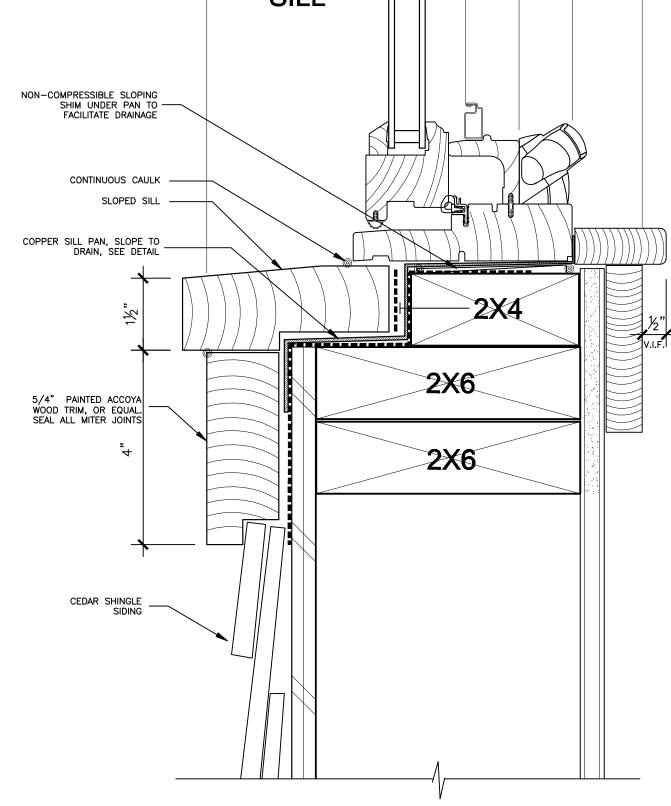


WINDOW INSTALLATION NOTES:

- 1. ALL MANUFACTURER INSTALLATION RECOMMENDATIONS FOR SPECIFIC WINDOW MODEL SHALL TO BE FOLLOWED TO THE GREATEST EXTENT APPLICABLE TO THIS INSTALLATION.
- 2. VERIFY WITH BUILDING INSPECTOR IF "DESIGN PRESSURE REQUIREMENTS" (DPR) IS REQUIRED. IF SO, FOLLOW MANUFACTURER'S INSTALLATION INSTRUCTIONS TO MAINTAIN FACTORY-TESTED RATINGS.
- 3. NAILING FIN TO BE SET INTO GENEROUS BED OF APPROVED SEALANT. APPLY FIN DIRECTLY TO PLY SHEATHING IF DPR REQUIREMENTS APPLY. IF NO NAILING FIN COMES STANDARD, ADD MANUFACTURER ACCESSORY OR OTHER SUITABLE 'WATER DAM' TYPE CORROSION-RESISTANT FLASHING KERFED INTO WINDOW FRAME.
- 4. USE HIGH-QUALITY, EXTERIOR GRADE, NEUTRAL-CURE, CLEAR, PAINTABLE SILICONE SEALANT (COMPATIBLE WITH WINDOW EXTRUSION, WOOD AND EXTERIOR WALL FINISH) UNLESS OTHERWISE SPECIFIED BY MANUFACTURER
- 5. USE CARLISLE COATINGS & WATERPROOFING ALL WEATHER PRIMER (CCW AWP), OR MANUF.
 APPROVED EQUAL, AT ALL CRITICAL WOOD TO BITUTHENE CONTACT AREAS FOR PROPER
 BONDING







2 CASEMNT WOOD WINDOW - SHINGLES
6" = 1'-0"

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SMITH

SUITE C

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HUNTER

RESIDENCE

JR & CINDY HUNTER

★ NO. C-24683

DETAILS

CARMEL, CA.

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NW CASANOVA & 13TH

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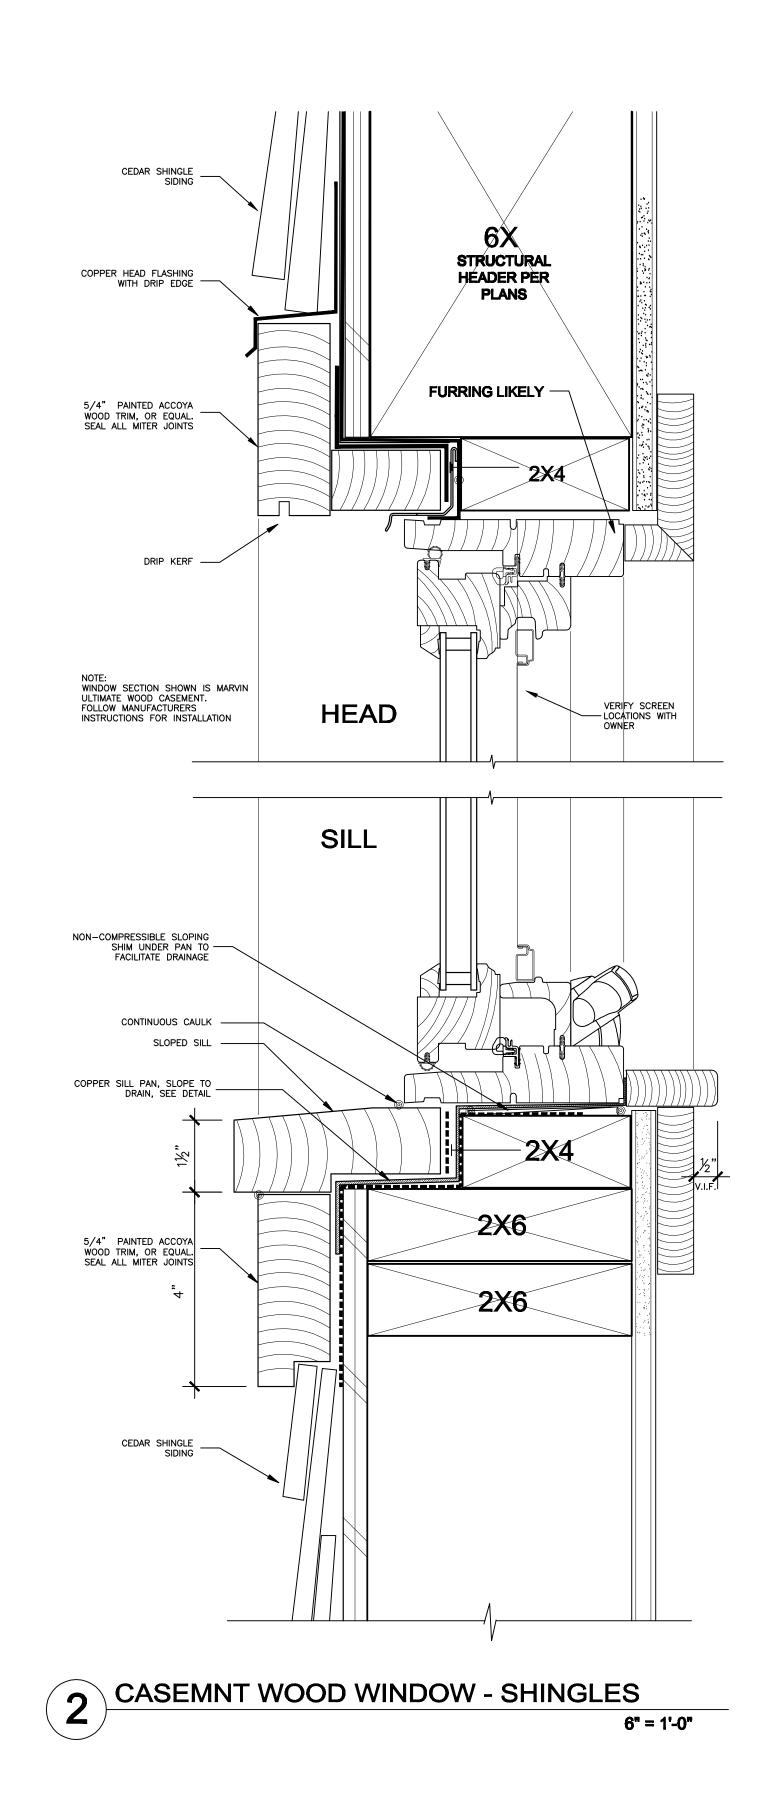
PACIFIC GROVE, CA.

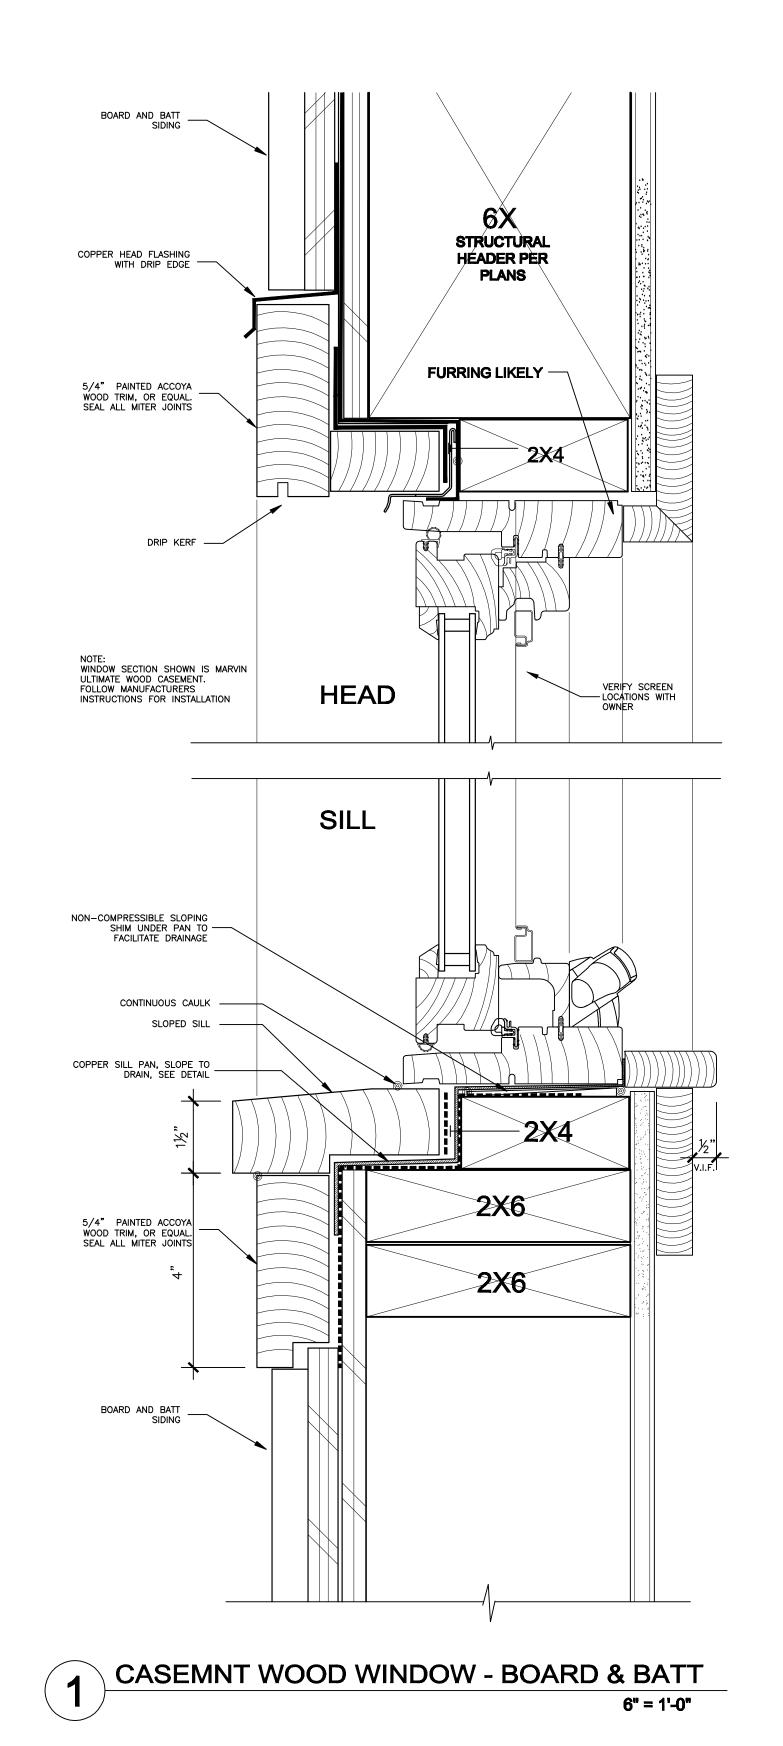
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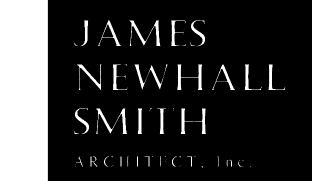
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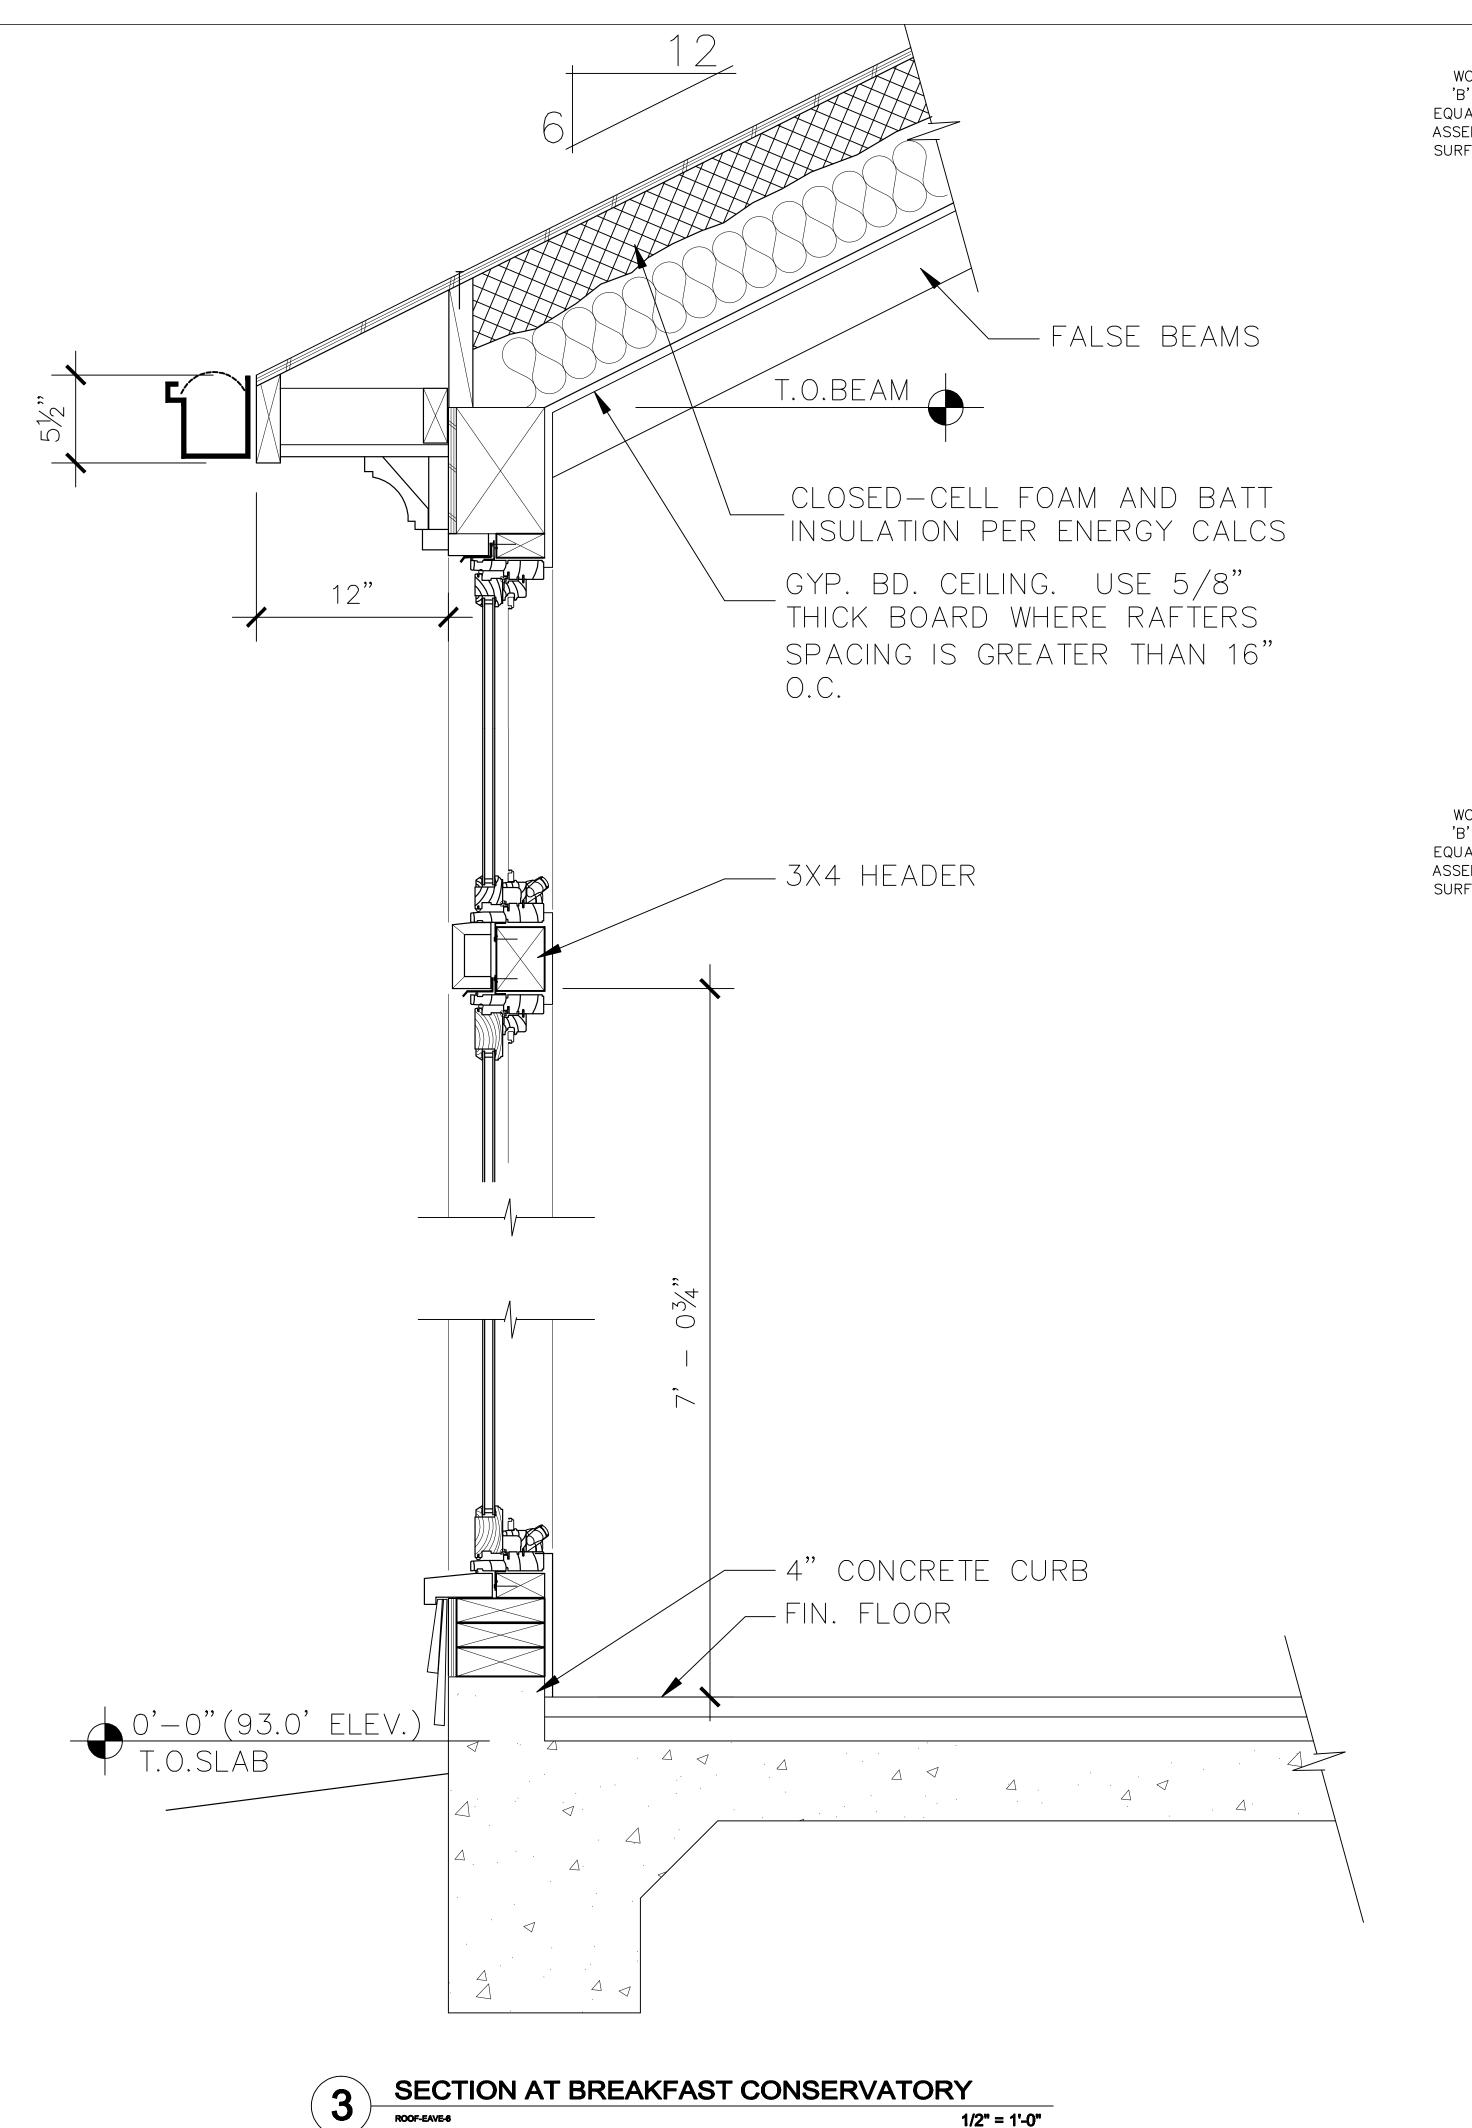
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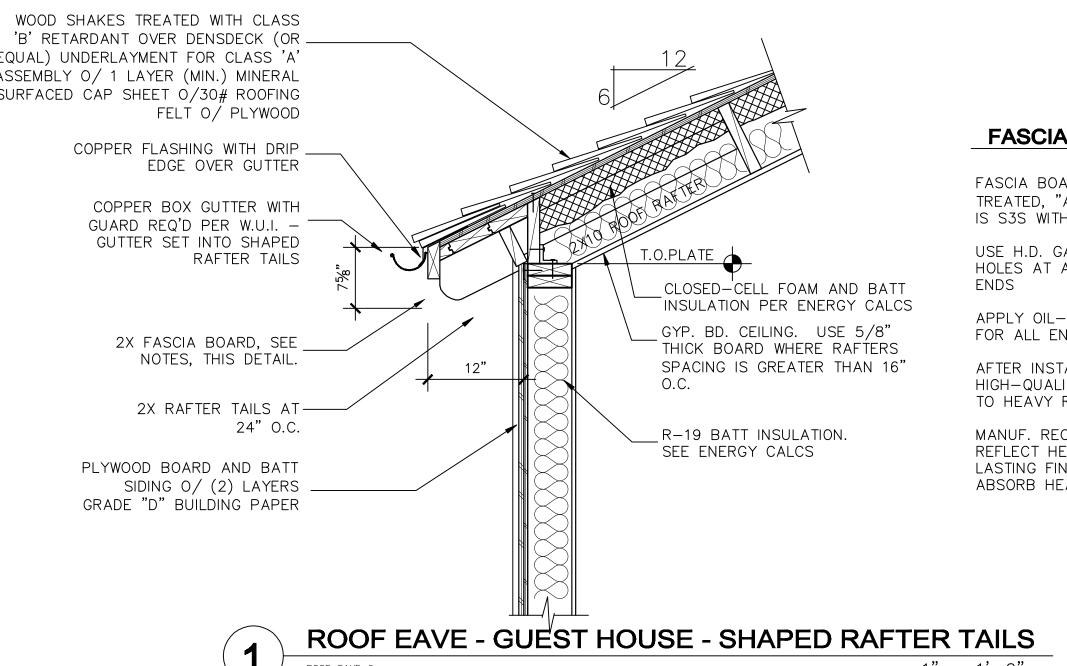
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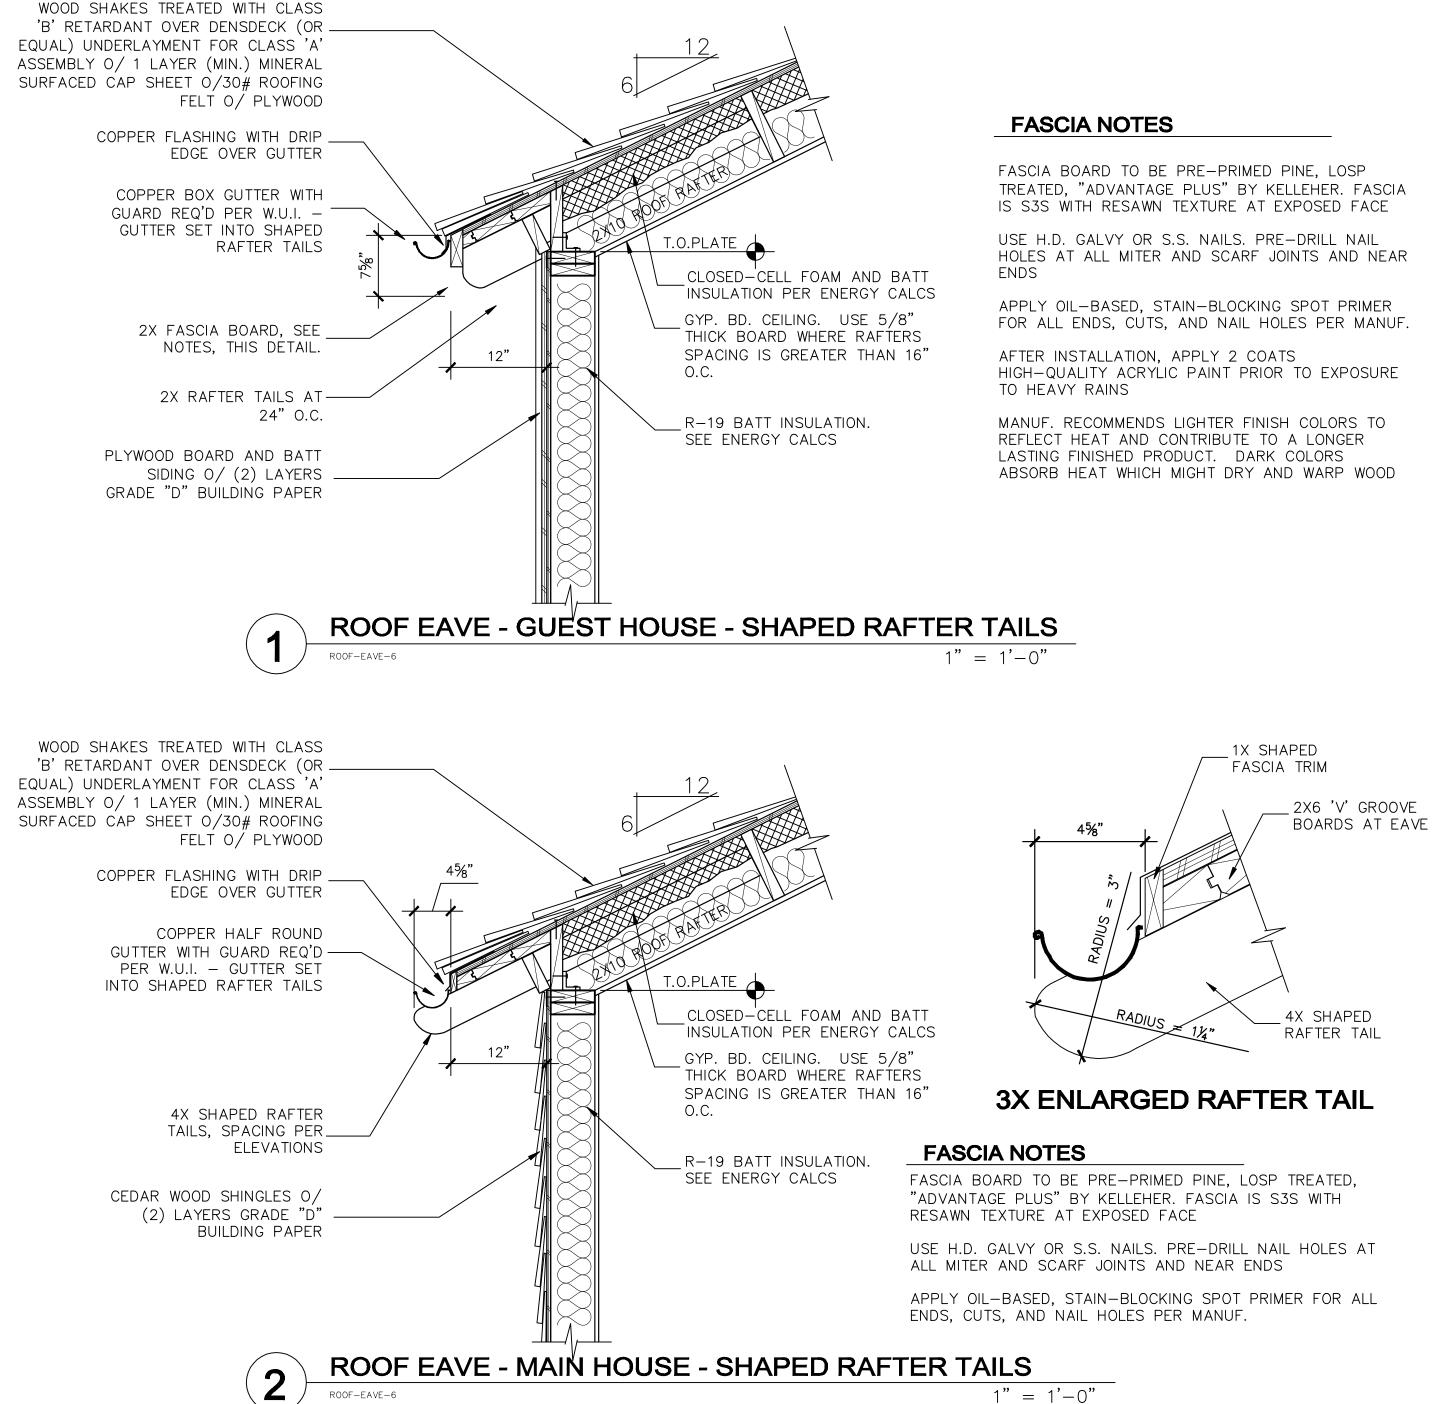


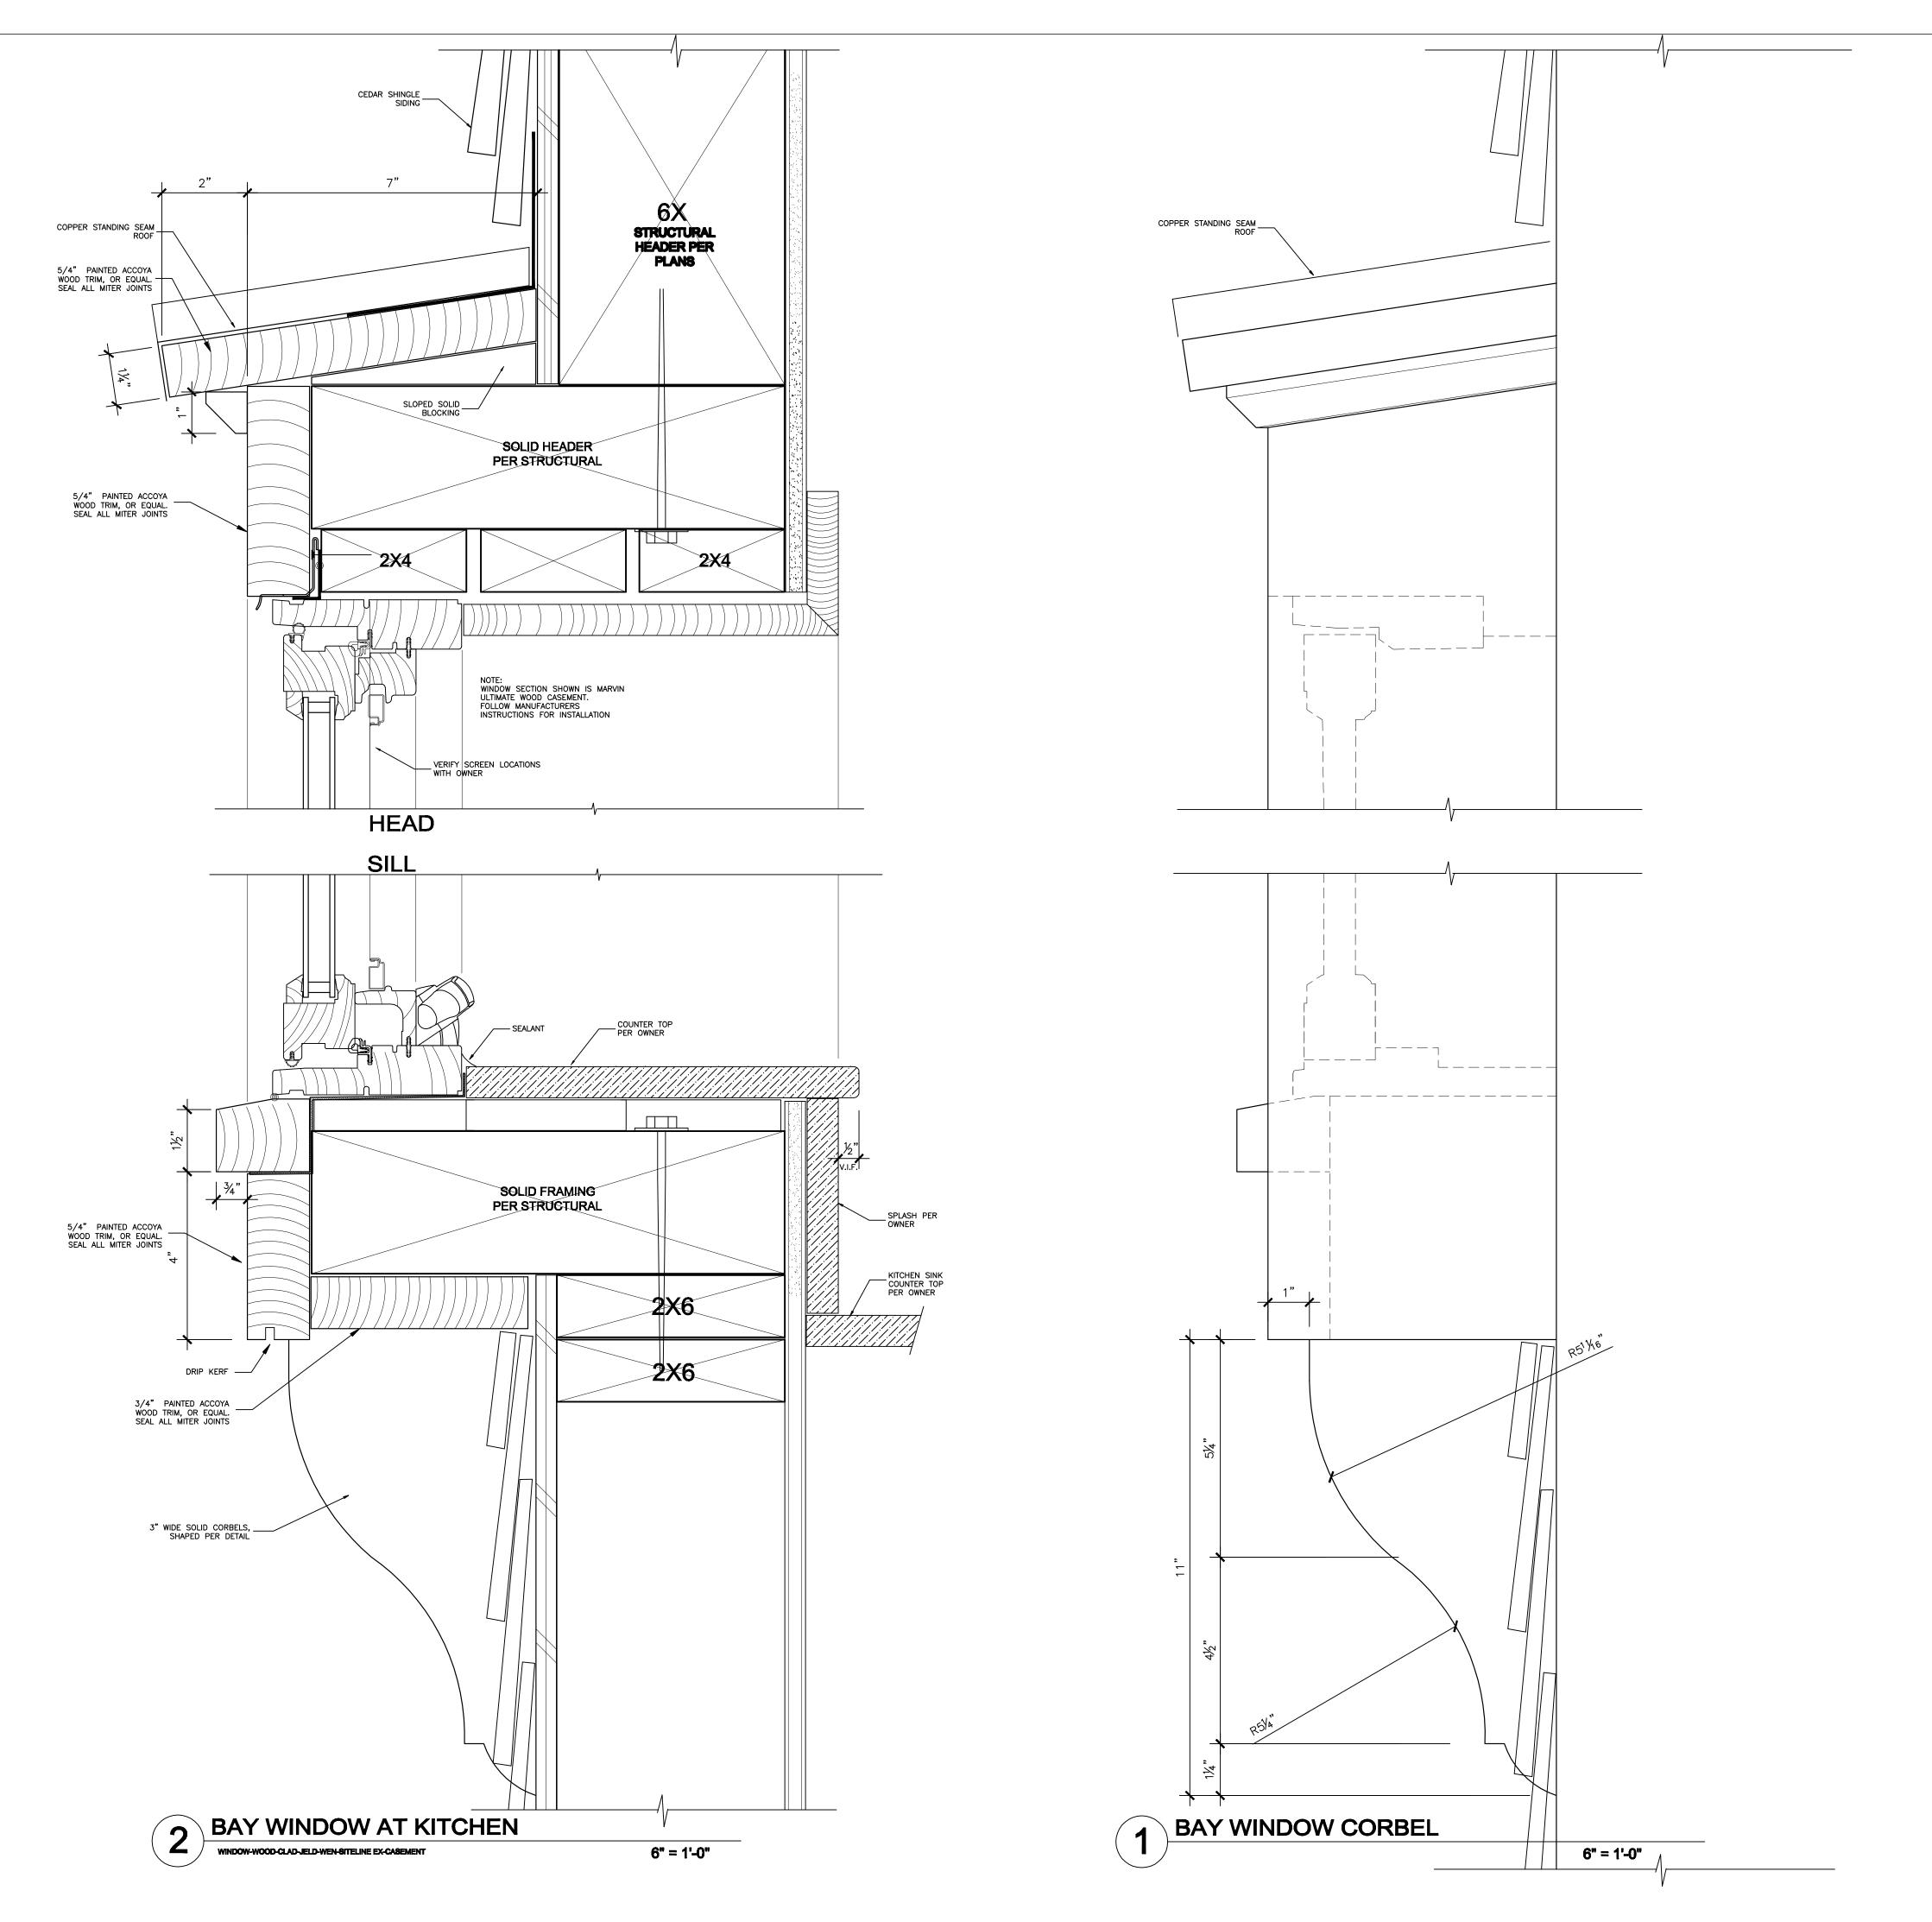
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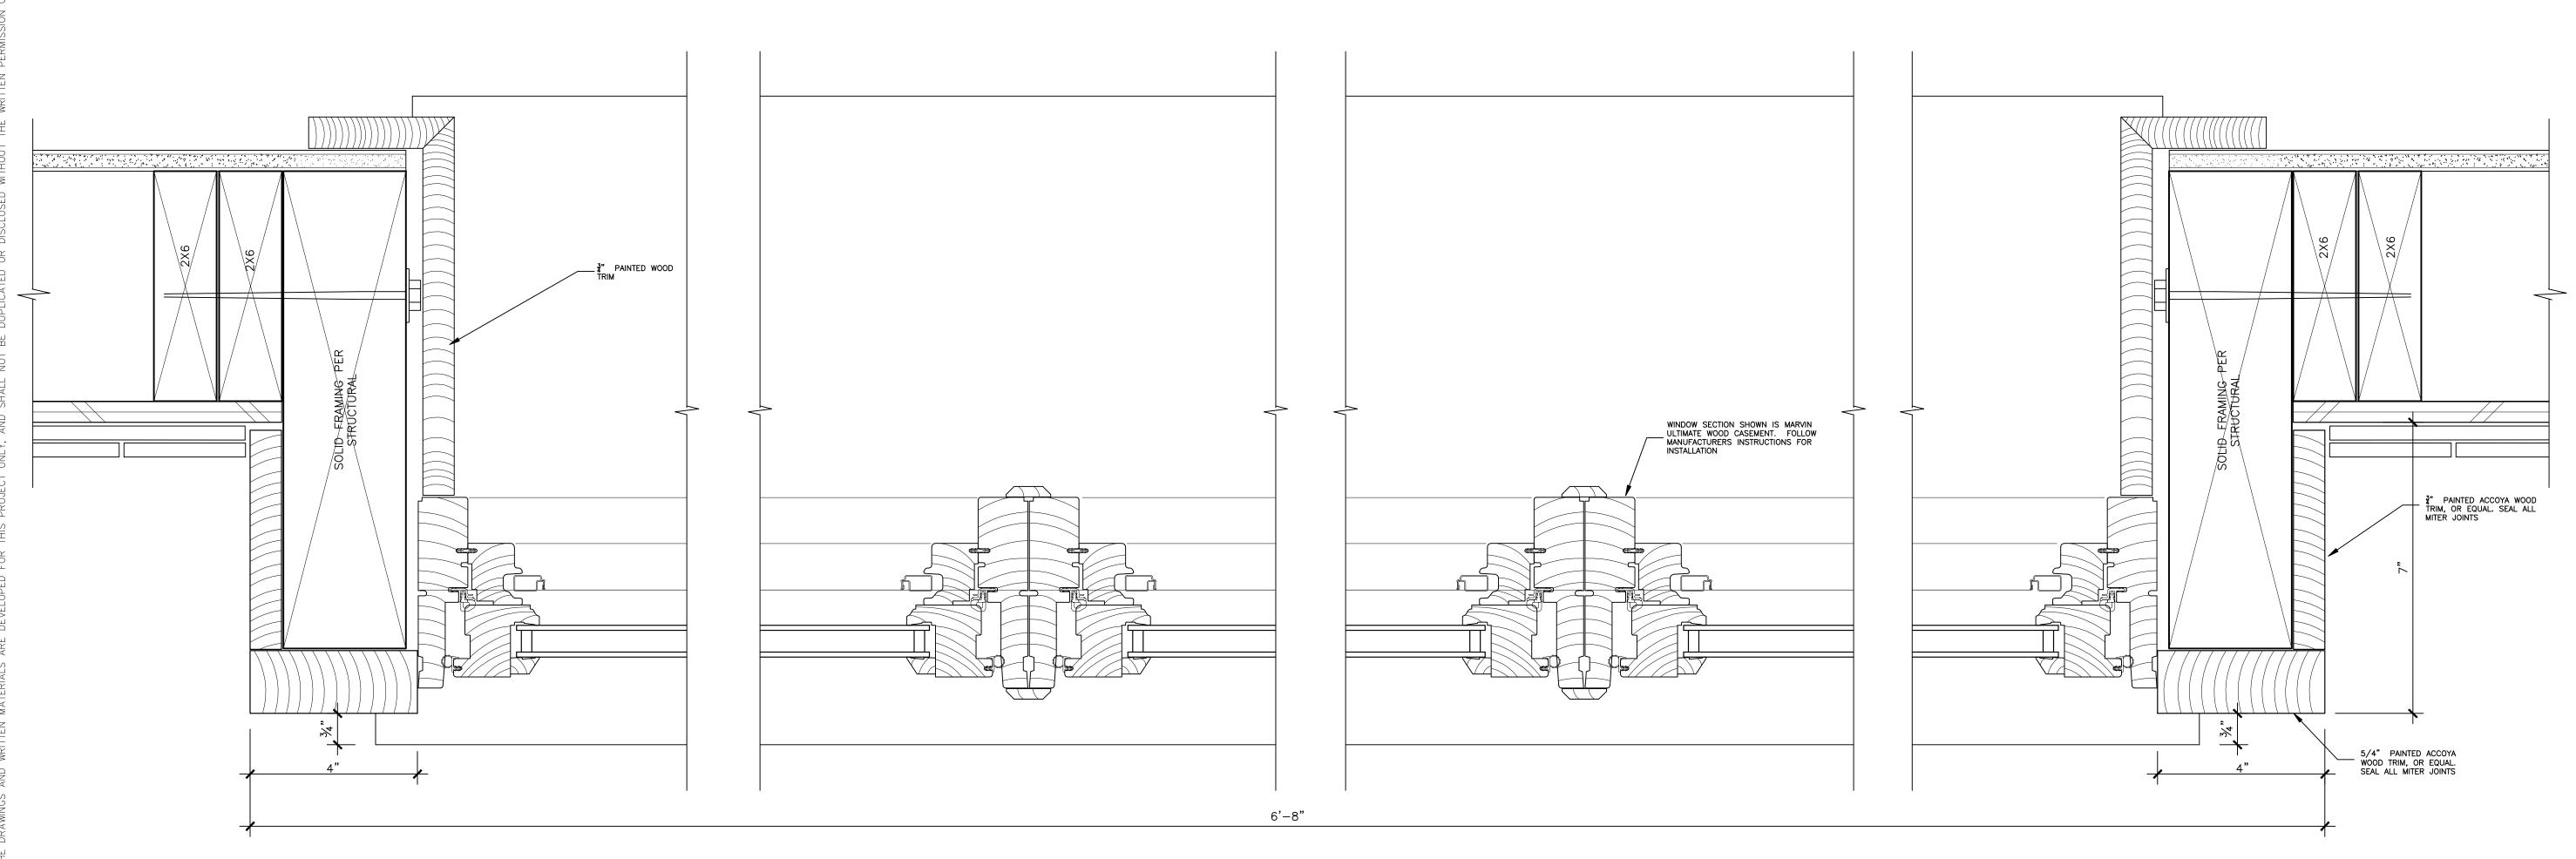


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PLAN - BAY WINDOW AT KITCHEN

WINDOW-WOOD-CLAD-JELD-WEN-SITELINE EX-CASEMENT

6" = 1'-0"

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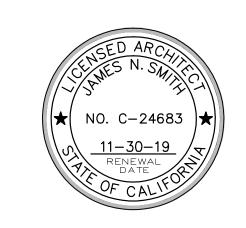
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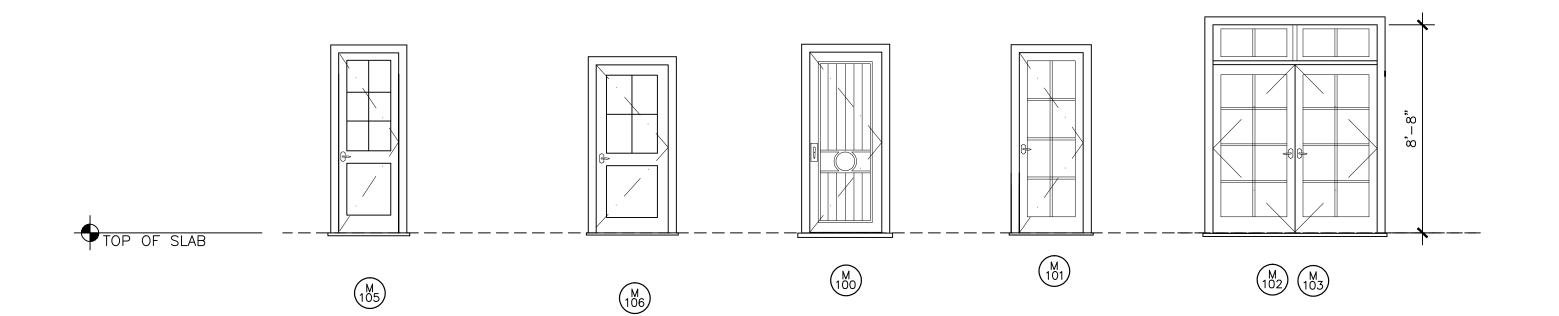
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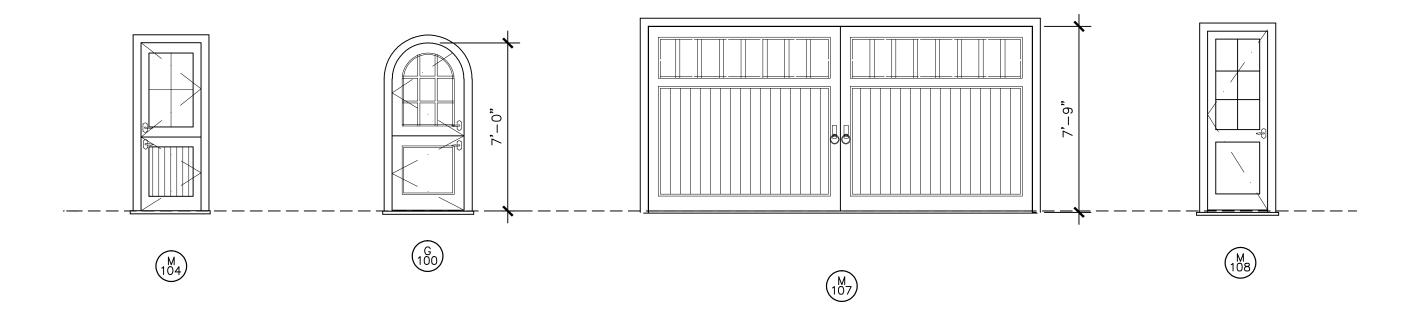
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DOOR ELEVATIONS

SCALE: 1"= 1'0"

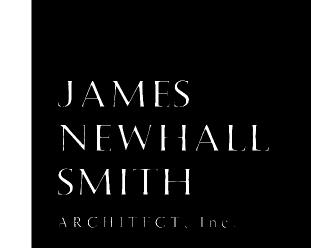
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DOOR SCHEDULE

DOOR	DOOR SIZE		FINISH					
MARK	WIDTH	HEIGHT	THICK.	MATL	CORE	FINISH	ACTION	REMARKS
1	3'-0"	8'-0"	1-3/8"	WD	sc	STAINED	SWING	xx
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DOOR SCHEDULE NOTES

- 1. DOOR SCHEDULE PROVIDED ABOVE IS PRELIMINARY IN NATURE. CONTRACTOR AND DOOR SUPPLIER SHALL REVIEW AND COMPILE A COMPLETE AND ACCURATE SCHEDULE BASED UPON FRAMED FIELD CONDITIONS AND OWNER PREFERENCES. CONTRACTOR TO VERIFY ALL ASPECTS OF DOORS WITH OWNER PRIOR TO ORDERING.
- 2. CONTRACTOR SHALL REVIEW ALL FIELD CONDITIONS TO ENSURE THAT THE PROPOSED DOOR SIZES AND SWINGS WILL FUNCTION PROPERLY. IF THERE ARE ANY DISCREPANCIES OR CONFLICTS THE CONTRACTOR IS TO NOTIFY THE ARCHITECT IMMEDIATELY THROUGH A REQUEST FOR INFORMATION
- 3. DOOR SIZES SHOWN ARE THE PROPOSED DOOR WIDTH AND HEIGHT DIMENSION, NOT THE ROUGH OPENING SIZE. GENERAL CONTRACTOR TO VERIFY MANUFACTURER'S NEAREST STOCK SIZES FOR ARCHITECT/OWNER TO REVIEW AND APPROVE.
- 4. ALL GLAZING IN DOORS SHALL BE TEMPERED GLASS. EXCEPTION IS FOR SMALL DECORATIVE GLASS OR PANE SSANDWICHED BETWEEN TEMPERED LAYERS. INSTALLATION IS PER C.B.C.
- 5. SPECIALTY DOORS SHALL BE COORDINATED WITH GENERAL CONTRACTOR FOR SITE VERIFICATION AND INSTALLATION.
- 6. ALL EXTERIOR DOORS SHALL HAVE A COPPER PAN, MIN. 20 OZ., 1/2" MAX THRESHOLD, & BRONZE, OR OTHER NON-CORROSIVE METAL, HINGES. OUTSWING DOORS SHALL HAVE A 1/2" MAX CHANGE IN ELEVATION TO THE EXTERIOR FINISH SURFACE.
- 7. ALL EXPOSED EDGES OF DOOR(S) INCLUDING TOP TO BE SEALED TO PREVENT MOISTURE PENETRATION AND WARPING. DOORS ARE TO BE STORED VERTICALLY AT JOB SITE AND OUT OF ALL INCLEMENT WEATHER CONDITIONS AND TO BE HUNG AS QUICKLY AS POSSIBLE, ONCE REACHING THE JOB SITE. IT IS THE CONTRACTOR'S RESPONSIBILITY TO MINIMIZE THE AMOUNT OF TIME FOR ON-SITE STORAGE OF DOORS AND WINDOWS PRIOR TO INSTALL.
- 8. ALL FRENCH DOORS ARE TO HAVE DEAD BOLTS AND THREE WAY CONNECTING HARDWARE TO MAXIMIZE CONTINUOUS SEAL AGAINST WIND/WEATHER.
- 9. DOORS REQUIRED TO HAVE 20 MINUTE RATING TO BE MIN. 1 3/8" SOLID WOOD AND SHALL BEAR THE U.L. LABEL NO RAISED PANELS OR OTHER FEATURES MAY REDUCE THIS MINIMUM THICKNESS. SHOULD VENEERS BE APPLIED TO PRE-MANUFACTURED 20 MIN. RATED DOORS, CARE IS TO BE TAKEN NOT TO VIOLATE THE RATING DURING APPLICATION.
- 10. WEATHER-STRIPING OF EXTERIOR DOORS SHALL BE CONTINUOUS ON ALL SIDES OF EACH DOOR AND SHALL BE SIZED, DESIGNED, AND FITTED TO PROVIDE FULL WATER-TIGHTNESS AGAINST WATER AND DRIVING RAIN. CONTRACTOR SHALL WATER TEST A MINIMUM OF ONE DOOR AFTER INSTALLATION ON SIDE OF RESIDENCE WHERE EXPOSURE TO WEATHER IS GREATEST, AND REPORT FINDINGS TO OWNER AND ARCHITECT.
- 11. AT LEAST ONE EGRESS DOOR SHALL BE PROVIDED FOR ALL DWELLING UNITS. THE DOOR SHALL BE SIDE-HINGED, AND SHALL PROVIDE A MINIMUM CLEAR WIDTH OF 32" WHEN MEASURED BETWEEN THE FACE OF THE DOOR AND THE STOP, WHEN OPEN TO 90 DEGREES. THE MINIMUM CLEAR HEIGHT SHALL BE 78" WHEN MEASURED FROM THE TOP OF THE THRESHOLD TO THE BOTTOM OF THE STOP. ALL EGRESS DOORS SHALL BE READILY OPENABLE FROM THE INSIDE OF THE DWELLING WITHOUT THE USE OF A KEY OR SPECIAL KNOWLEDGE OR EFFORT, PER CRC R311.2.
- 12. AT ALL STATE RESPONSIBILITY AREAS (SRA) EXTERIOR DOOR ASSEMBLIES SHALL BE APPROVED NON-COMBUSTIBLE CONSTRUCTION, OR SOLID CORE WOOD HAVING STILES AND RAILS NOT LESS THAN 1-3/8" THICK WITH INTERIOR FIELD PANEL THICKNESS NO LESS THAN 1 1/4" THICK, OR SHALL HAVE A FIRE-RESISTANCE RATING OF NOT LESS THAN 20 MINUTES. (CRC 327 WILDLAND URBAN INTERFACE)



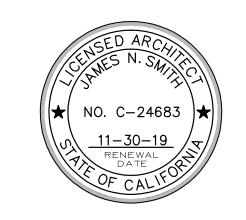
716 LIGHTHOUSE AVE. SUITE C PACIFIC GROVE, CA. 93950

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PROJECT/CLIENT

HUNTER RESIDENCE

JR & CINDY HUNTER NW CASANOVA & 13TH CARMEL, CA.



SHEET TITLE

DOOR **SCHEDULE**

ISSUE	REVISIONS
1) 06-27-18 PRELIM. REVIE	W
2 07-03-18 FOREST & BE	ACH COMM

3 12-05-18
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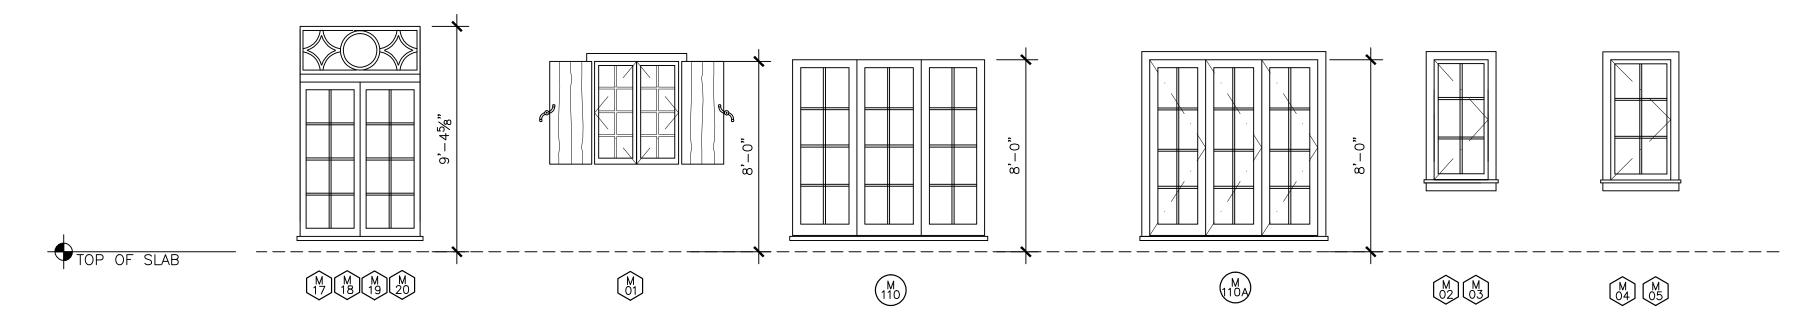
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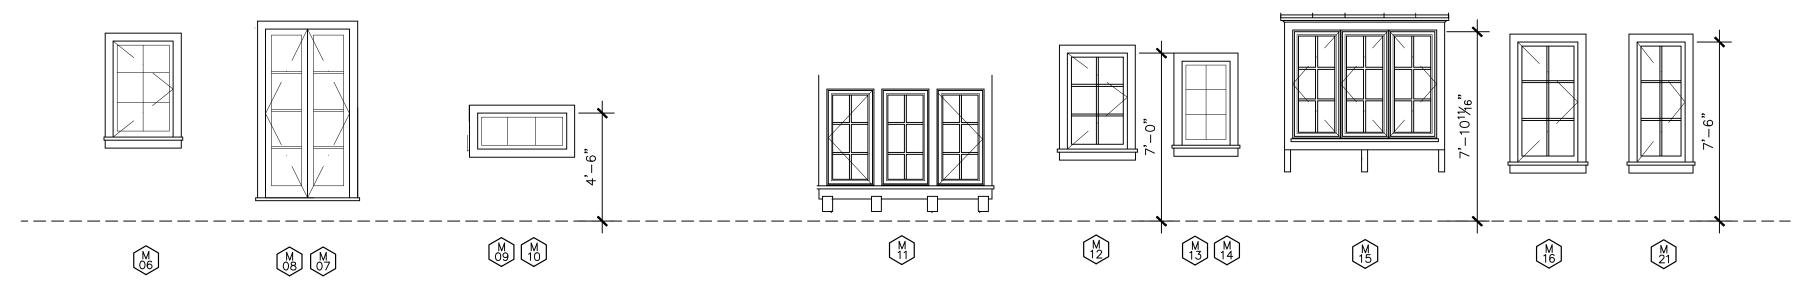
DATE

PROJECT NUMBER

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WINDOW ELEVATIONS

SCALE: 1"= 1"-0"

WINDOW SCHEDULE

MARK	UNIT SIZE WIDTH X HEIGHT	HEAD HEIGHT	TYPE OF OPERABILITY	FRAME MATERIAL	REMARKS
1	"X"	8'-O"	DBL. CASEMENT	WOOD	SEE NOTES BELOW, AS APPLIES, TYP.
2	^	0-0	DBL. CAGLIVILITI	VVOOD	GEL NOTES BELOW, AS AFFELES, TIF.
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WINDOW SCHEDULE NOTES

GENERAL

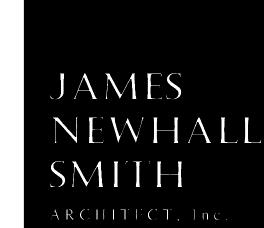
- 1. WINDOW SCHEDULE PROVIDED ABOVE IS PRELIMINARY IN NATURE. CONTRACTOR AND WINDOW SUPPLIER SHALL COMPILE A COMPLETE AND ACCURATE SCHEDULE BASED UPON FRAMED FIELD CONDITIONS OF PROJECT AND OWNER CHANGES/PREFERENCES.
- 2. WINDOW DIMENSIONS ARE PROPOSED UNIT SIZES. GENERAL CONTRACTOR IS TO VERIFY ALL PROPOSED WINDOW SIZES WITH SITE CONDITIONS AND FOR MANUFACTURER'S NEAREST STOCK SIZES, WHEN APPLICABLE. ALL WINDOW SIZES, SHAPES, COLORS, HARDWARE, SCREENS, GLAZING, ETC. MUST BE APPROVED BY OWNER PRIOR TO ORDERING. CONTRACTOR SHALL PROVIDE ARCHITECT COMPLETE STRUCTURAL WINDOW SHOP DRAWINGS FOR REVIEW.
- 3. SPECIALTY WINDOWS MUST BE COORDINATED WITH THE GENERAL CONTRACTOR.
- 4. ALL WINDOWS ARE TO BE DOUBLE GLAZED UNLESS OTHERWISE NOTED.
- 5. OWNERS TO SPECIFY WHICH, IF ANY, WINDOWS ARE TO BE LOW "E" OR OTHERWISE HAVE FILM OR TINT WITHIN GLAZING.
- 6. ALL WINDOWS SHALL HAVE A SOLDIERED COPPER PAN, MINIMUM 20 OZ., WITH MOISTSTOP OR EQUIVALENT WATERPROOFING SYSTEM. GALVANIZED IRON IS ACCEPTABLE IN NON-COASTAL ENVIRONMENTS. SEE DETAIL.
- 7. WEATHER-STRIPING OF ALL WINDOWS SHALL BE CONTINUOUS ON ALL SIDES OF EACH WINDOW AND SHALL BE SIZED, DESIGNED, AND FITTED TO PROVIDE FULL WATER-TIGHTNESS AGAINST WATER AND DRIVING RAIN. CONTRACTOR SHALL WATER TEST A MINIMUM OF ONE WINDOW AFTER INSTALLATION ON SIDE OF RESIDENCE WHERE EXPOSURE TO WEATHER IS GREATEST, AND REPORT FINDINGS TO OWNER AND ARCHITECT.
- 8. WINDOWS WHICH EXCEED STANDARD SIZES SHALL BE VERIFIED BY WINDOW SUPPLIER FOR ENGINEERING AND WIND LOAD AT GIVEN PROJECT LOCATION AND PLACEMENT OF WINDOW(S) ON RESIDENCE (EXPOSURE)

SAFETY

- 1. PER CBC 1029.1 EGRESS WINDOWS SHALL HAVE A NET CLEAR OPENABLE AREA OF 5.7 S.F. THE NET CLEAR OPENABLE HEIGHT DIMENSION SHALL BE 24", AND THE NET CLEAR OPENABLE WIDTH DIMENSION SHALL BE 20". THE FINISHED SILL HEIGHT SHALL NOT BE GREATER THAN 44" ABOVE THE FINISHED FLOOR. THESE REQUIREMENTS SHALL PREEMPT THE ABOVE WINDOW SCHEDULE DIMENSIONS WHERE REQUIRED BY THE U.B.C.. MINIMUM (1) EGRESS WINDOW PER SLEEPING ROOM, AND OTHER HABITABLE ROOMS.
- 2. ALL CASEMENT WINDOWS USED IN BEDROOMS AS EMERGENCY EGRESS MUST BE "BREAK AWAY" TYPE TO ENSURE COMPLETE OPENABLE AREA FOR ACCESS.
- 3. ALL GLAZING SUBJECT TO HUMAN IMPACT SHALL BE TEMPERED GLASS OR WIRE SAFETY GLASS (CBC 2406)
- 4. GLAZING IN AN INDIVIDUAL, FIXED OR OPERABLE PANEL ADJACENT TO A DOOR WHERE THE NEAREST VERTICAL EDGE OF THE GLAZING IS WITHIN A 24" ARC OF EITHER VERTICAL EDGE OF THE DOOR IN A CLOSED POSITION AND WHERE THE BOTTOM EXPOSED EDGE OF THE GLAZING IS LESS THAN 60" ABOVE THE FLOOR OR WALKING SURFACE SHALL BE SAFETY GLASS (CRC 308.4.2)
- 5. ALL OPERABLE WINDOWS ABOVE ADJACENT GRADE BY 6' OR MORE AND LOCATED WITHIN 36" OF THE FINISHED FLOOR, OR OTHERWISE VULNERABLE TO A PERSON FALLING OUT, SHALL HAVE SUITABLE RESTRAINT BAR(S) INSTALLED. THE BUILDING OWNER CAN ELECT NOT TO INSTALL RESTRAINTS AT THEIR SOLE DISCRETION. INSECT SCREENS DO NOT OFFER PROTECTION AGAINST PERSONS FALLING OUT OF A WINDOW.
- 6. WINDOWS THAT MEET ALL CONDITIONS SHALL BE TEMPERED PER CRC R308.4.3: WHERE EXPOSED AREA OF INDIVIUAL PANE IS GREATER THAN 9 SQUARE FEET, EXPOSED BOTTOM EDGE IS LESS THAN 18" ABOVE THE FLOOR, EXPOSED TOP EDGE IS GREATER THAN 36" ABOVE THE FLOOR, AND ONE OR MORE WALKING SURFACES ARE WITHIN 36", MEASURED HORIZONTALLY AND IN A STRAIGHT LINE, OF THE GLAZING, SHALL BE TEMPERED GLAZING.(R308.4.3)
- 7. GLAZING IN WET AREAS WHERE THE BOTTOM EXPOSED EDGE OF THE GLAZING IS LESS THAN 60" MEASURED VERTICALLY ABOVE ANY STANDING OR WALKING SURFACE SHALL BE TEMPERED.

W.U.I.

1. FOR PROJECTS LOCATED WITHIN WILDLAND URBAN INTERFACE (W.U.I.) ZONES, ADDITIONAL REQUIREMENTS SHALL APPLY SUCH AS THE TEMPERING OF THE OUTER-MOST PANE OF GLASS PER CRC R327.8



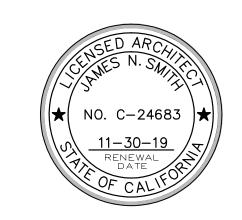
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PROJECT/CLIENT

HUNTER RESIDENCE

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SHEET TITLE

() ISSUE

WINDOW SCHEDULE

1) 06-27-18 PRELIM. REVIEW
2 07-03-18 FOREST & BEACH COMM
3 12-05-18 PLANNING SUBMITTAL
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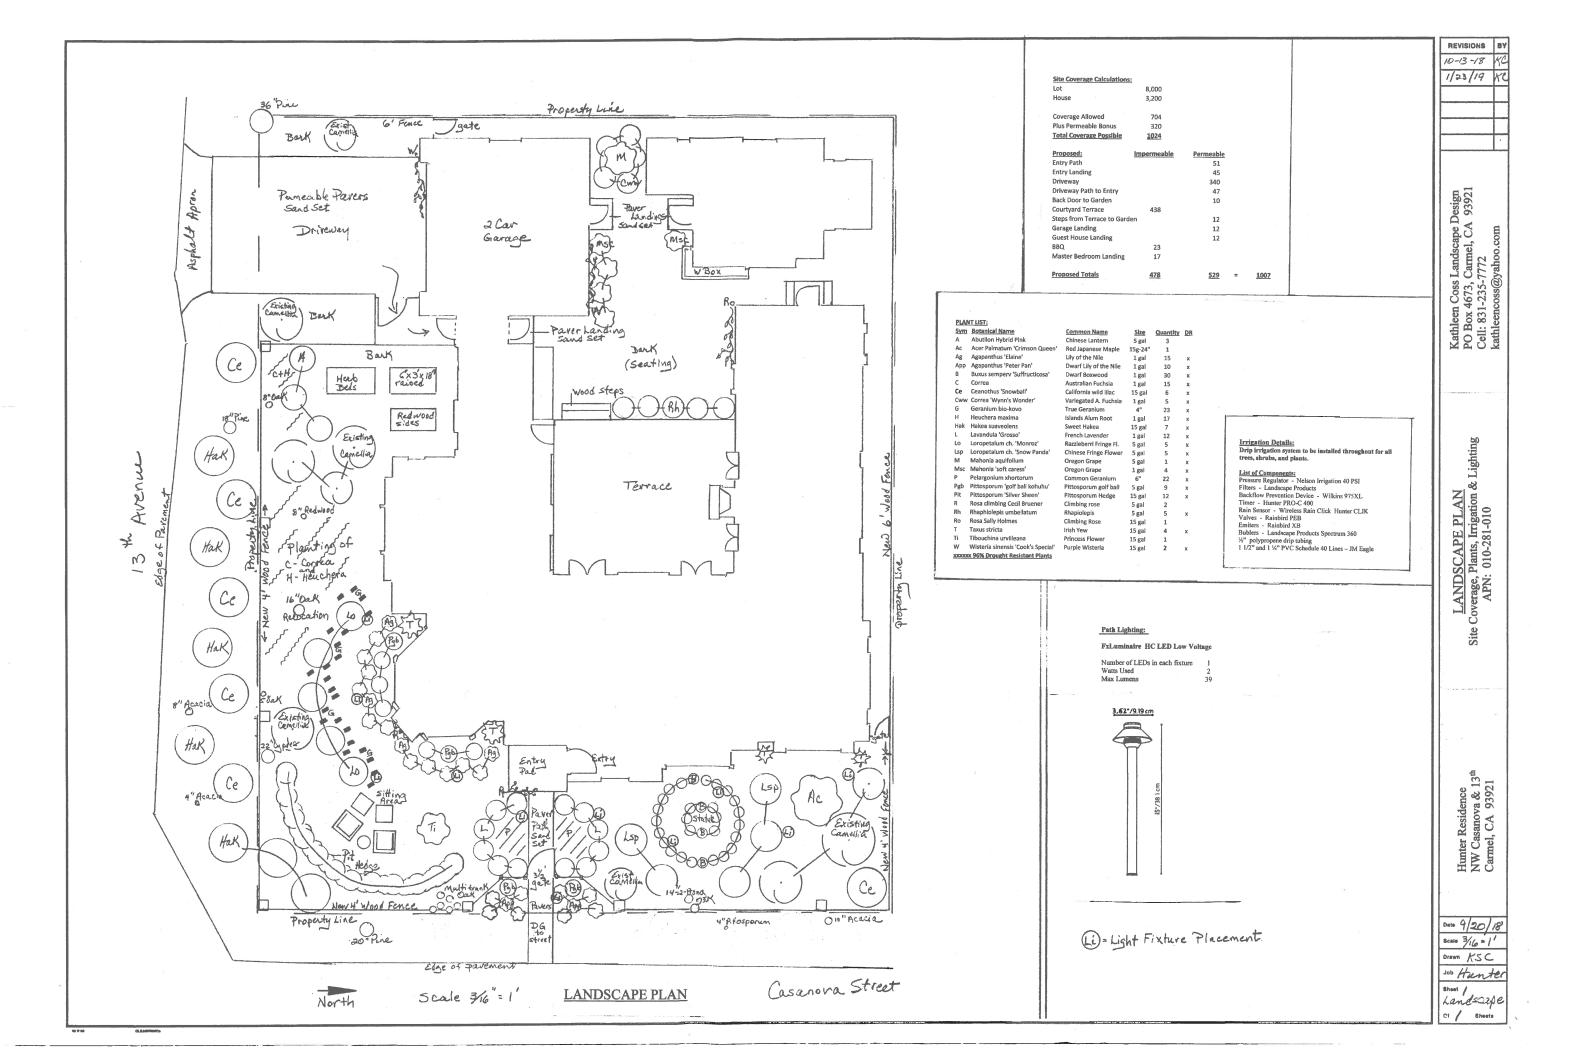
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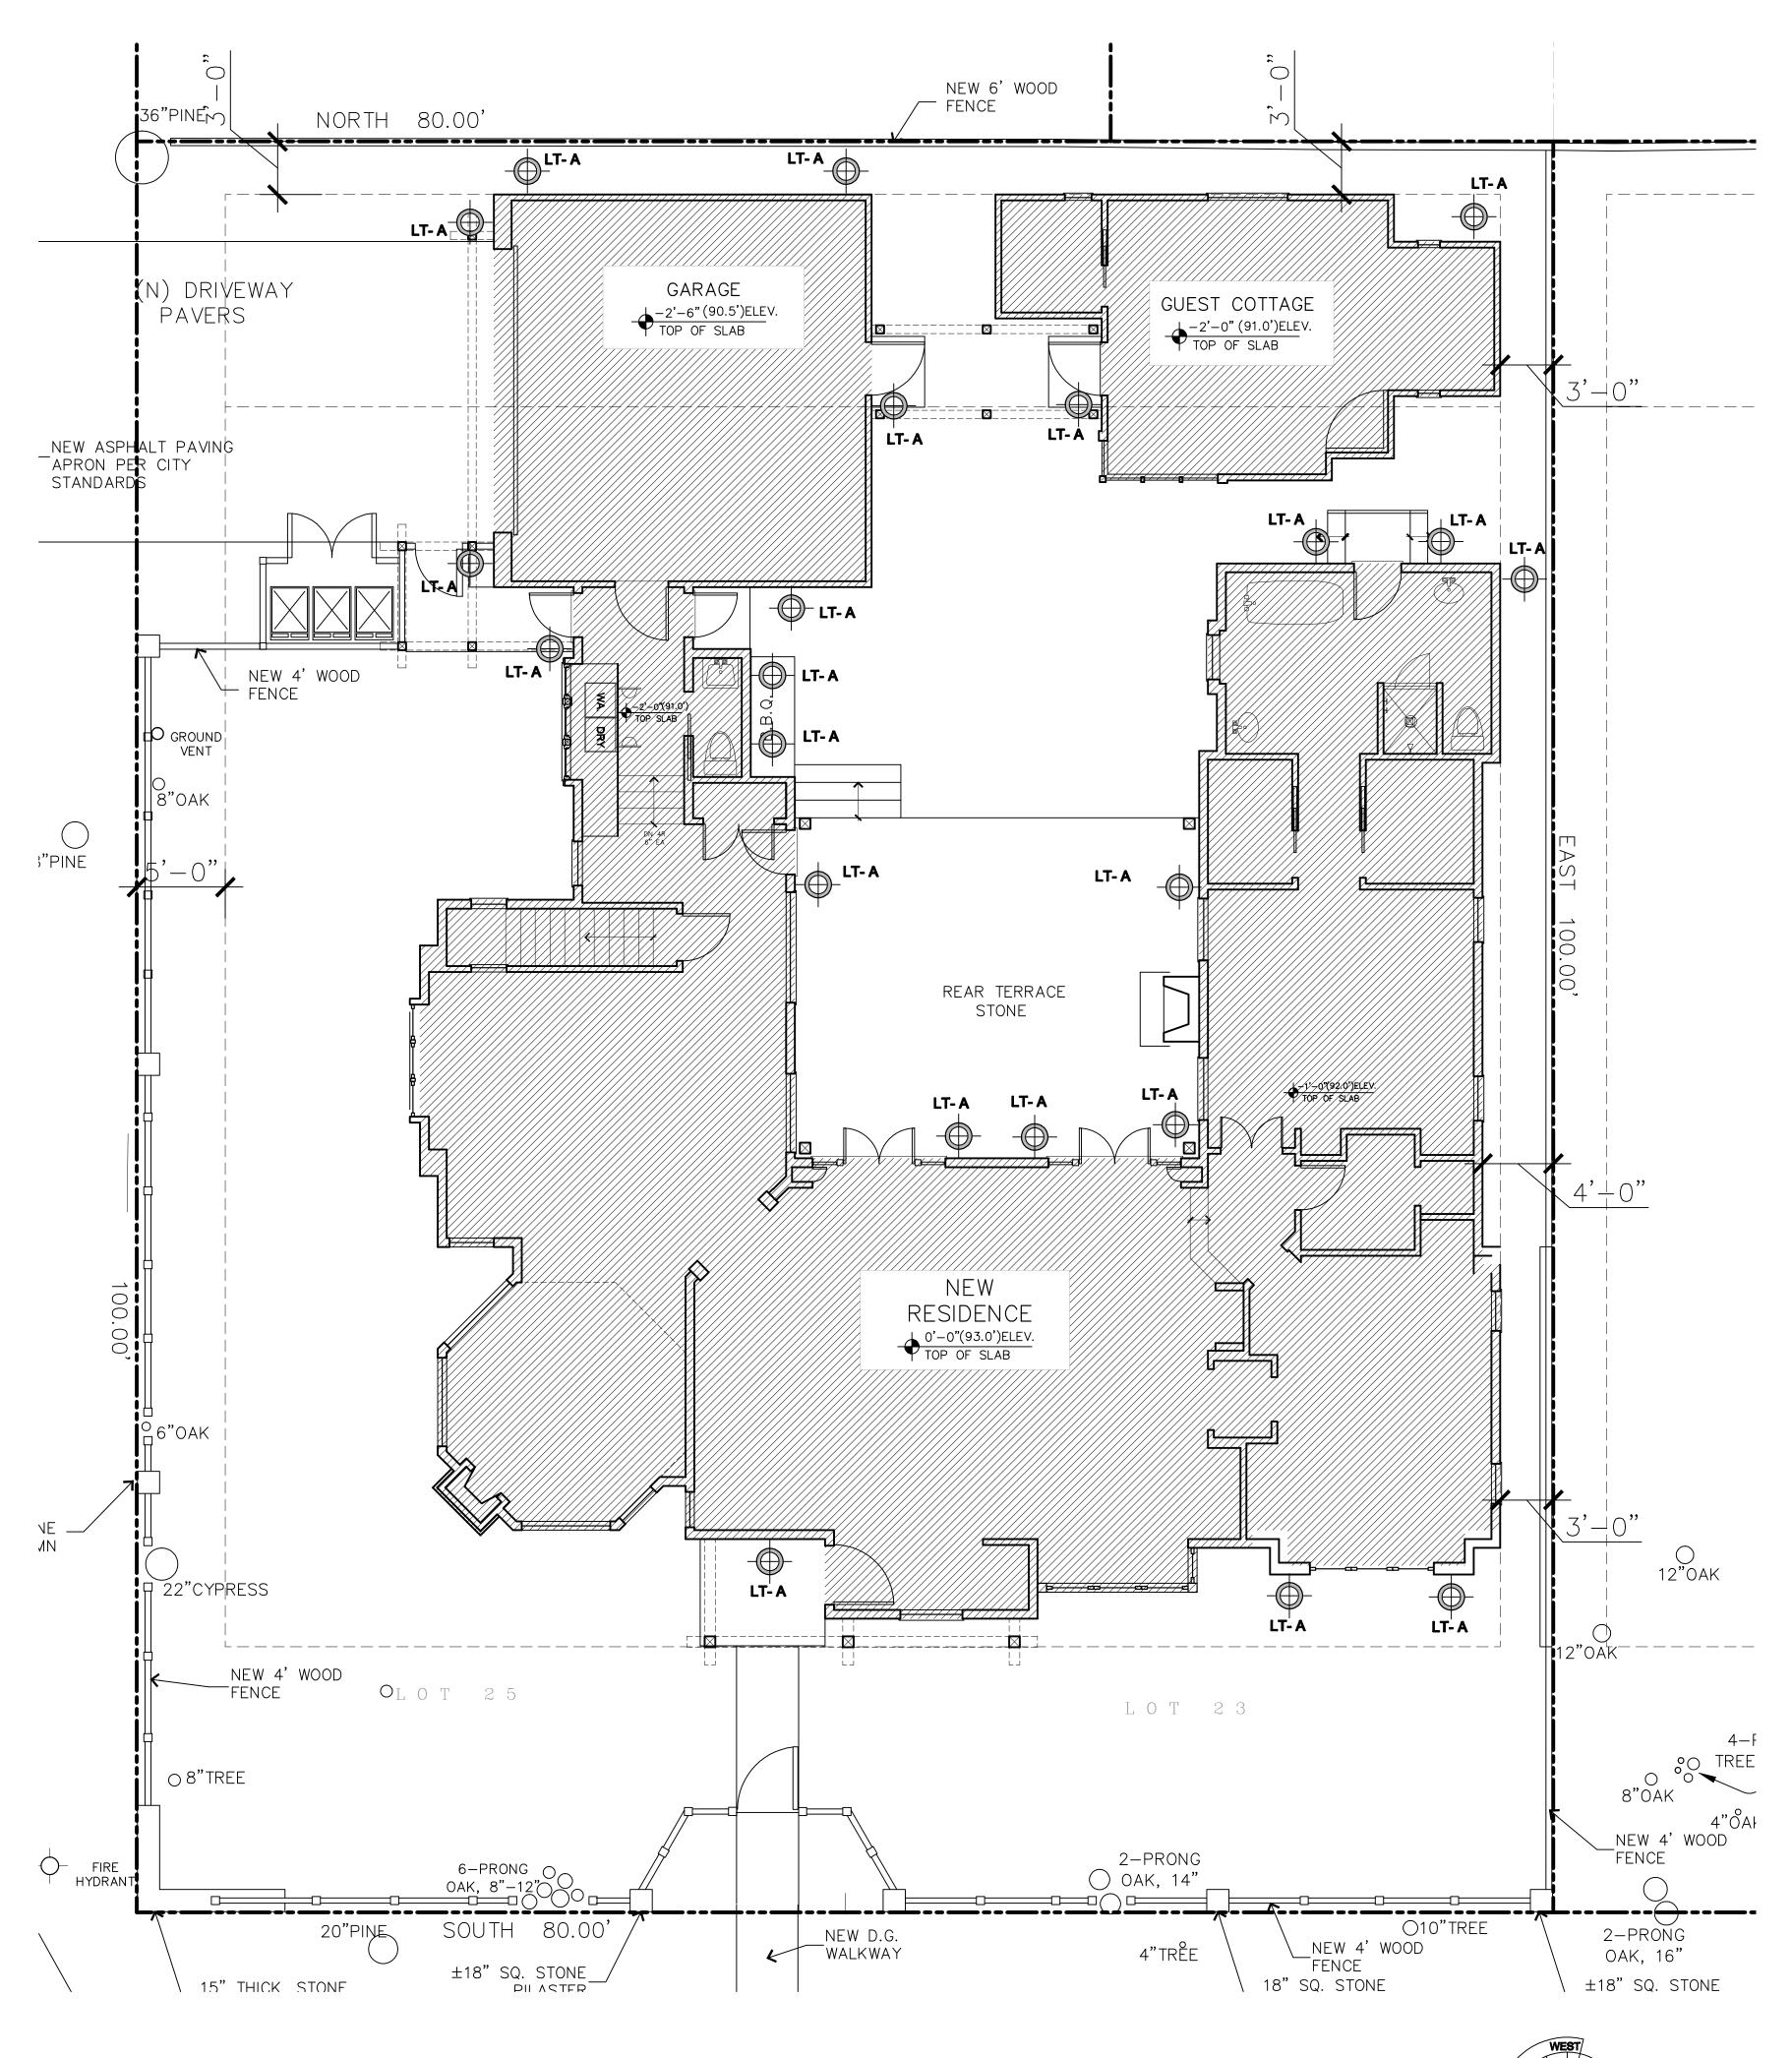
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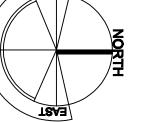
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SITE LIGHTING PLAN

SCALE: 3/16"=1'-0"



LIGHTING NOTES

Uses Medium Base Bulb UL/CUL and Wet Rated

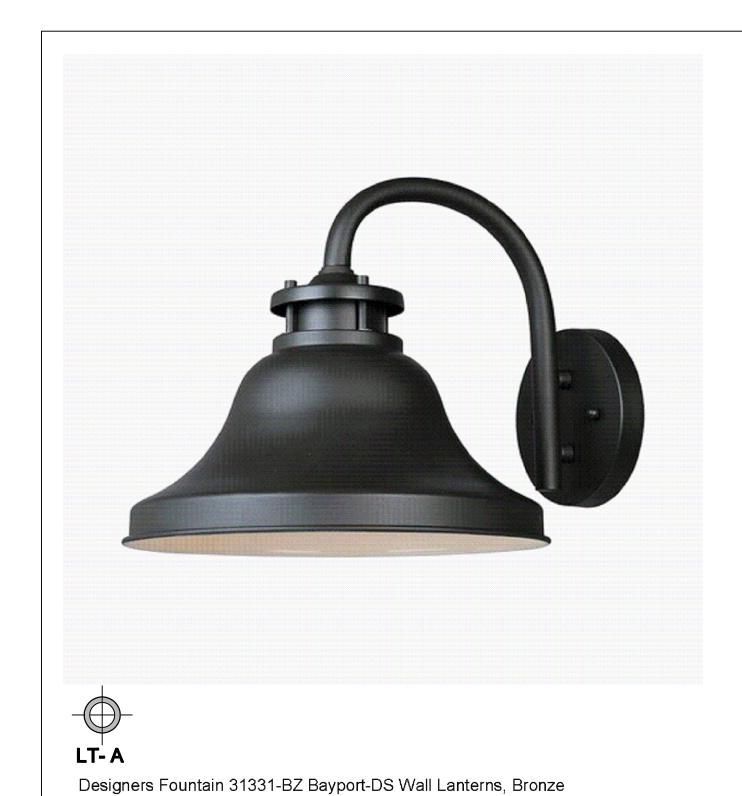
Dark sky directional lighting

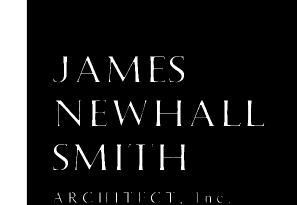
Steel construction and intended for wet locations

Bronze finish

(1) 25 watt bulb

- 1. EXTERIOR LIGHTING SHALL BE LIMITED TO 25 WATTS OF LESS (INCANDESCENT EQUIVALENT, IE, 375 LUMENS) PER FIXTURE AND SHALL BE MOUTED NO HIGHER THAN 10 FEET ABOVE THE GROUND.
- LANDSCAPE LIGHTING SHALL BE MOUNTED NO HIGHER THAN 18" ABOVE THE GROUND, NOR MORE THAN 15 WATTS (INC. EQUIV. OF 225 LUMENS) PER FIXTURE AND SPACED NO CLOSER THAN 10 FEET APART.
- 3. LANDSCAPE LIGHTING SHALL NOT BE USED FOR TREE, WALL, FENCE OR ACCENT LIGHTING OF ANY TYPE. LANDSCAPE LIGHTING IS TO SAFELY ILLUMINATE WALKWAYS AND ENTRANCES TO THE SUBJECT PROPERTY.
- 4. ALL FIXTURES SHALL BE SHEILED AND DOWNWARD FACING.
- 5. SEE LANDSCAPE PLAN FOR LANDSCAPE LIGTHING SPECIFICATIONS AND LOCATIONS





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SHEET TITLE

SITE LIGHTING PLAN

ISSUE REVISIONS

1 06-27-18
PRELIM. REVIEW

2 07-03-18
FOREST & BEACH COMM

3 12-05-18
PLANNING SUBMITTAL

4 01-23-19
FINAL PLANNING REVIEW

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