VERTICAL & HORIZONTAL WOOD SIDING: WESTERN RED CEDAR



STONE VENEER: GRAY/BROWN MIX



LIGHT TAN STUCCO -STEEL TROWEL FINISH



BROWN STUCCO -STEEL TROWEL FINISH



ALUMIN.CLAD WINDOWS & DOORS: BRONZE/BROWN FINISH



TAN/GRAY GRAVEL BALLAST TO BE USED ON TOP OF TAN COLORED METACRYLICS ROOF

PROPOSED HARDSCAPING & SITE MATERIALS





WOOD DECKING & STEPS - 'GARAPA' WOOD



DRIVEWAY - STAGGERED CONC. PAVERS W/ PLANTING BETWEEN





FRONT YARD SPACED WOOD FENCING SIDE YARD FENCE - SPACED HORIZONTAL WOOD BOARDS, FENCE WILL SLOPE TO MATCH SITE SLOPE


EXISTING SITE PHOTOS



FRONT OF HOUSE AS SEEN FROM CAMINO REAL



VIEW DOWN DRIVEWAY LOOKING WEST

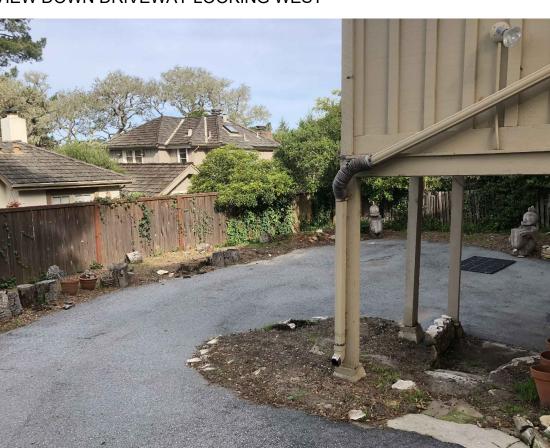

VIEW OF REAR YARD LOOKING NORTHWEST



VIEW OF REAR YARD LOOKING SOUTH

SHEET INDEX

G1.0 PROJECT INFORMATION G1.1 GRADING & CONSTRUCTION MANAGEMENT PLAN

G1.2 BEST MANAGEMENT PRACTICES

G1.3 SURVEY

L1

L2

PROJECT

SITE

A1.0 EXISTING SITE PLAN A1.1 PROPOSED SITE PLAN

A1.2 LOT COVERAGE CALCULATIONS A2.0 PROPOSED MAIN LEVEL FLOOR PLAN

LANDSCAPE LIGHTING & IRRIGATION

BUILDING CODE INFO

A2.1 PROPOSED UPPER LEVEL FLOOR & ROOF PLAN A3.0 BUILDING ELEVATIONS

A3.1 **BUILDING ELEVATIONS** A3.2 STREET VIEW ELEVATIONS

A4.0 **BUILDING SECTION**

PLANTING PLAN


THIS PROJECT SHALL COMPLY WITH THE FOLLOWING:

2016 CALIFORNIA RESIDENTIAL CODE 2016 CALIFORNIA MECHANICAL CODE 2016 CALIFORNIA PLUMBING CODE 2016 CALIFORNIA ELECTRICAL CODE


2016 CALIFORNIA ENERGY CODE 2016 CALIFORNIA FIRE CODE

2016 CALIFORNIA GREEN BUILDING STANDARDS CODE

PARCEL MAP

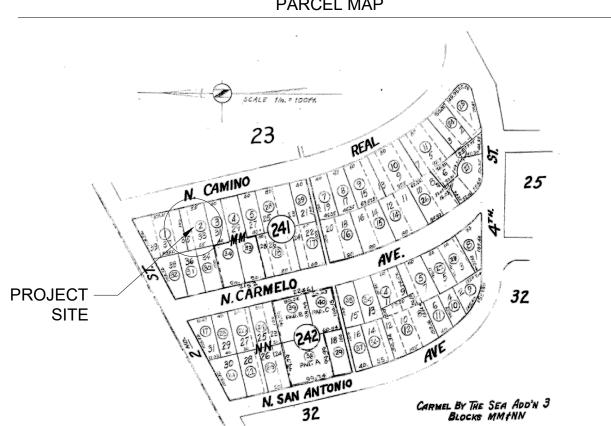

VICINITY MAP

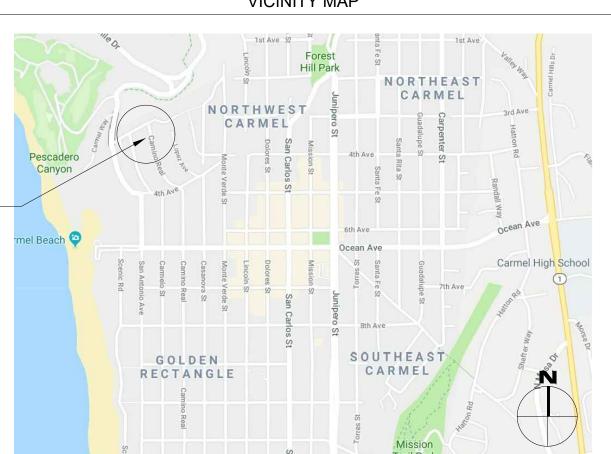

SCOPE OF WORK

DEMOLITION OF AN (E) 1,467 SF TWO STORY SINGLE FAMILY HOME AND CONSTRUCTION OF A NEW 2,066.4 SF TWO STORY SINGLE FAMILY HOME AND A 240 SF (1) CAR GARAGE.

AN (E) ASPHALT DRIVEWAY WILL BE REMOVED AND A NEW CONCRETE PAVER & SEDGE GRASS DRIVEWAY WILL BE BUILT. THE ASPHALT APRON CONNECTING THE DRIVEWAY TO CAMINO REAL WILL ALSO BE RE-BUILT.

REMOVAL OF ALL (E) HARDSCAPE, BUILD NEW FRONT YARD FENCE AND SIDE YARD FENCES, THE (E) SIDEYARD FENCES WILL REMAIN AND NEW FENCES WILL BE BUILT ALONGSIDE. NEW WOOD DECKS & WALKWAYS. NEW DROUGHT TOLERANT LANDSCAPING IS ALSO BEING PROPOSED.

DEFERRED SUBMITTALS

FIRE SPRINKLERS

PROJECT TEAM

OWNER KASEY & CARRIE LI

1900 UNIVERSITY AVE. SUITE # 105 EAST PALO ALTO, CA 94303

RESIDENCE

CAMINO REAL, 2 S.W. OF 2ND AVENUE

CARMEL-BY-THE-SEA

CALIFORNIA 93923

N A A

PHONE: (650) 906-2214

ARCHITECT SAMUEL PITNICK ARCHITECTS, INC.

> LICENSE # C-34362 PO BOX 22412, CARMEL, CA 93922

PHONE: (831) 241-1895 SAMUELPITNICK@GMAIL.COM

LANDSCAPE ROBERT SHULER DESIGN

CARMEL-BY-THE-SEA, CA 93923 PHONE: (831) 624-4079

SURVEYOR RASMUSSEN LAND SURVEYING INC.

2150 GARDEN RD #A3 MONTEREY, CA 93940 PHONE: (831) 375-7240

ARCHAEOLOGIST SUSAN MORLEY M.A.

3059 BOSTICK AVE., MARINA, CA 93955 PHONE: (831) 645-9162

PROJECT INFORMATION

PROPERTY ADDRESS CAMINO REAL, 2 S.W. OF 2ND AVE.

CARMEL-BY-THE-SEA, CA 93923

BLOCK: MM LOT: 02

010-241-002

ZONING R-1 (SINGLE FAMILY RESIDENTIAL)

TYPE OF CONSTRUCTION TYPE V-B

OCCUPANCY GROUP R-3 / SINGLE FAMILY RESIDENCE

U / GARAGE

YEAR BUILT 1935

BUILDING INFORMATION & LOT COVERAGE

LOT SIZE 5,502 SF

ALLOWABLE BASE FLOOR AREA 2,310.6 SF

(E) FLOOR AREA:

TOTAL

(P) LOT COVERAGE:

WATER SOURCE

(P) FLOOR AREA: (P) MAIN LEVEL 1,915 SF (P) UPPER LEVEL 151.4 SF (P) GARAGE 240 SF

ALLOWABLE LOT COVERAGE 508.3 SF

ALLOWABLE COVERAGE W/ BONUS 728.3 SF

700.5 SF (51% PERMEABLE)

1,467 SF

2,306.4 SF

(SEE SHEET A1.2 FOR MORE INFO)

24'-0" ALLOWABLE HEIGHT LIMIT MAXIMUM (P) HEIGHT

19'-0"

MISCELLANEOUS

CAL AM

WASTE DISPOSAL SYSTEM SEWER - C.A.W.D.

TREES TO BE REMOVED (1) 12" HOLLY TREE

GRADING ESTIMATES

(P) GRADING CUT 52.0 CU.YDS. (P) GRADING FILL 49.7 CU.YDS.

1 SPACE (COVERED) (E) PARKING (P) PARKING 1 SPACE (COVERED)

GENERAL NOTES

- 1. CONTRACTOR TO FIELD VERIFY SURVEY AND EXISTING CONDITIONS PRIOR TO CONSTRUCTION AND SHALL NOTIFY THE ARCHITECT IN WRITING OF ANY DISCREPANCIES.
- 2. CONTRACTOR SHALL PROTECT EXISTING TREES AND ROOT SYSTEM. ALL EXCAVATION AROUND EXISTING TREES SHALL BE MADE BY HAND.
- 3. CULTURAL, ARCHAEOLOGICAL, HISTORICAL, OR PALEONTOLOGICAL RESOURCES NOTIFICATION: "STOP WORK WITHIN 50 METERS (165 FEET) OF UNCOVERED RESOURCE AND CONTACT MONTEREY COUNTY RMA-PLANNING AND A QUALIFIED ARCHAEOLOGIST IMMEDIATELY IF CULTURAL, ARCHAEOLOGICAL, HISTORICAL, OR PALEONTOLOGICAL RESOURCES ARE UNCOVERED".

G1.0

01/07/2019

ARCHITECTURAL

PROJECT

INFORMATION

Scale: SEE DWG.

Drawn By: SBP

Job: -

REVISIONS DATE

CONSTRUCTION MANAGEMENT NOTES

- TREE PROTECTION SHALL BE IN PLACE PRIOR TO ANY PERMITS
- ALSO SEE BEST MANAGEMENT PRACTICES NOTES ON SHEET G1.2

GRADING LEGEND:

CUT MATERIAL FILL MATERIAL

SCALE: 1/8" = 1'-0"


GRADING ESTIMATES: (P) CUT = 52.0 CU.YDS.(P) FILL = 49.7 CU.YDS. (P) NET CUT = 2.3 CU.YDS.


CONSTRUCTION MANAGEMENT LEGEND:

CONSTRUCTION MATERIAL STORAGE STRAW WATTLE

PAINT & SOLVENT CLEAN-OUT AREA


CONCRETE CONTAINMENT WASHOUT — — SILT FENCING

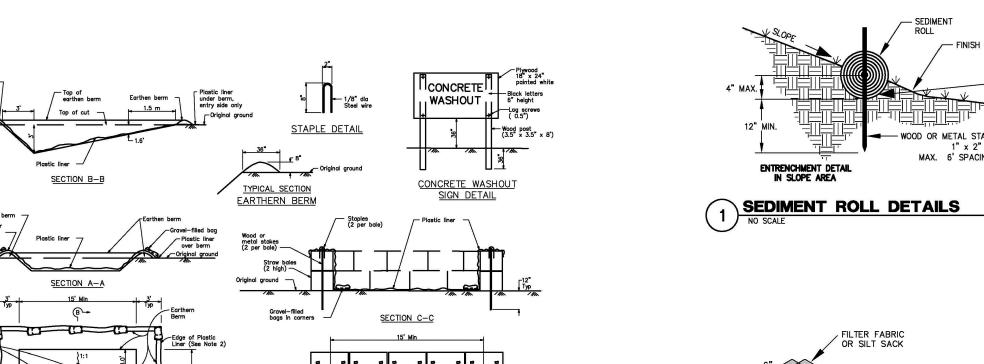


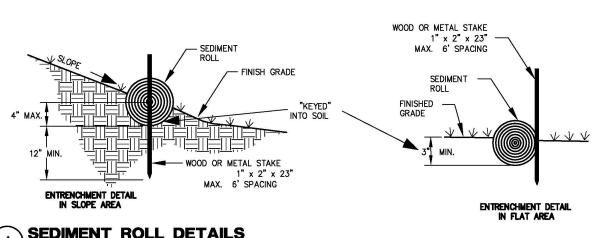

(TO BE USED ON SLOPES AND ALONG PROPERTY LINES) 1. PRIOR TO ROLL INSTALLATION, CONTOUR A CONCAVE KEY TRENCH THREE (3" MIN.) TO FOUR (4") INCHES MAX. DEEP ALONG THE PROPOSED INSTALLATION ROUTE. 2. SOIL EXCAVATED IN TRENCHING SHOULD BE PLACED ON THE UPHILL OR FLOW SIDE OF THE ROLL TO PREVENT WATER FROM UNDER CUTTING THE ROLL. 3. PLACE SEDIMENT ROLL INTO KEY TRENCH AND STAKE ON BOTH SIDES OF THE ROLL TO WITHIN SIX FEET (6') OF EACH END AND THEN EVERY SIX FEET (6') WITH 1" \times 2" \times 23" WOOD OR METAL STAKES. 4. STAKES ARE TYPICALLY DRIVEN IN ON ALTERNATING SIDES OF THE ROLL. WHEN MORE THAN ONE SEDIMENT ROLL IS PLACED IN A ROW, THE ROLLS SHOULD BE OVERLAPPED TWELVE INCHES (12") MIN. TO PROVIDE A TIGHT JOINT, NOT ABUTTED TO ONE ANOTHER.

- STAGGERED STAKES

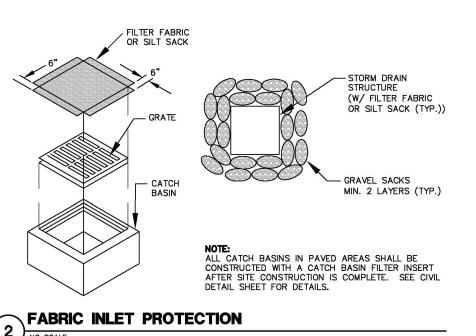

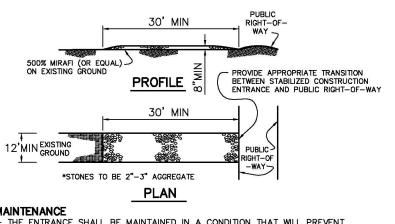

MAINTENANCE THE ENTRANCE SHALL BE MAINTAINED IN A CONDITION THAT WILL PREVENT TRACKING OR FLOWING SEDIMENT ONTO PUBLIC RIGHTS-OF-WAY. THIS MAY REQUIRE PERIODIC TOP DRESSING WITH ADDITIONAL STONE AS CONDITIONS DEMAND, AND REPAIR AND/OR CLEAN OUT ANY MEASURES USED TO TRAP SEDIMENT. - ALL SEDIMENT SPILLED, DROPPED, WASHED, OR TRACKED ONTO PUBLIC RIGHTS-OF-WAY SHALL BE REMOVED IMMEDIATELY.

- WHEN NECESSARY, WHEELS SHALL BE CLEANED TO REMOVE SEDIMENT PRIOR TO ENTRANCE ONTO PUBLIC RIGHTS-OF-WAY. THIS SHALL BE DONE AT AN AREA STABILIZED WITH CRUSHED STONE, WHICH DRAINS INTO AN APPROVED SEDIMENT TRAD OR SEDIMENT BASEN. TRAP OR SEDIMENT BASIN. CONSTRUCTION ENTRANCE

EROSION CONTROL NOTES

1. ALL SURFACES EXPOSED OR EXPECTED TO BE EXPOSED DURING GRADING ACTIVITIES SHALL BE PREPARED AND MAINTAINED THROUGH THE LENGTH OF THE ENTIRE PROJECT TO

2. ACTUAL GRADING SHALL BEGIN WITHIN 30 DAYS OF VEGETATION REMOVAL OR THE AREA SHALL BE PLANTED TO CONTROL EROSION. VEGETATION REMOVAL BETWEEN OCTOBER 15TH AND APRIL 15TH SHALL NOT PRECEDE SUBSEQUENT GRADING OR CONSTRUCTION ACTIVITIES

3. THE FOLLOWING PROVISIONS SHALL APPLY BETWEEN OCTOBER 15 AND APRIL 15.

A. DISTURBED SURFACES NOT INVOLVED IN THE IMMEDIATE OPERATIONS MUST BE PROTECTED BY APPLYING STRAW MULCH AT 2000 LBS. PER ACRE AND ANCHORED BY TRACK-WALKING TO PREVENT MOVEMENT DURING WATER FLOW. B. RUNOFF FROM THE SITE SHALL BE DETAINED OR FILTERED BY BERMS, VEGETATED FILTER STRIPS AND/OR CATCH BASINS TO PREVENT THE ESCAPE OF SEDIMENT FROM THE

THESE DRAINAGE CONTROLS MUST BE MAINTAINED BY THE CONTRACTOR AS NECESSARY TO ACHIEVE THEIR PURPOSE THROUGHOUT THE LIFE OF THE PROJECT. SEE THIS SHEET FOR EROSION CONTROL PLAN AND EROSION CONTROL DETAILS. C. EROSION CONTROL MEASURES SHALL BE IN PLACE AT THE END OF EACH DAY'S THE BUILDING INSPECTOR SHALL STOP OPERATIONS DURING PERIODS OF

INCLEMENT WEATHER IF HE DETERMINES THAT EROSION PROBLEMS ARE NOT BEING CONTROLLED ADEQUATELY. E. CUT AND FILL SLOPES SHALL BE PLANTED WITH AN SEED MIX APPROVED BY THE LANDSCAPE ARCHITECT. AMOUNT OF SEED AND FERTILIZER SHALL BE APPROVED BY THE LANDSCAPE ARCHITECT AND THE SANTA LUCIA PRESERVE.

4. AT ALL TIMES DURING CONSTRUCTION AND UNTIL FINAL COMPLETION, THE CONTRACTOR, WHEN HE OR HIS SUBCONTRACTORS ARE OPERATING EQUIPMENT ON THE SITE, SHALL PREVENT THE FORMATION OF AN AIRBORNE DUST NUISANCE BY WATERING AND/OR TREATING THE SITE OF THE WORK IN SUCH A MANNER THAT WILL CONFINE DUST PARTICLES TO THE IMMEDIATE SURFACE OF THE WORK. THE CONTRACTOR WILL BE RESPONSIBLE FOR ANY DAMAGE DONE BY DUST FROM HIS OR HER SUBCONTRACTOR.

THIS PLAN IS INTENDED TO BE USED FOR INTERIM EROSION AND SEDIMENT CONTROL ONLY AND IS NOT TO BE USED FOR FINAL ELEVATIONS OR PERMANENT IMPROVEMENTS. 6. CONTRACTOR SHALL BE RESPONSIBLE FOR MONITORING EROSION AND SEDIMENT CONTROL PRIOR, DURING, AND AFTER STORM EVENTS.

7. REASONABLE CARE SHALL BE TAKEN WHEN HAULING ANY EARTH, SAND, GRAVEL, STONE, DEBRIS, PAPER OR ANY OTHER SUBSTANCE OVER ANY PUBLIC STREET, ALLEY OR OTHER PUBLIC PLACE. SHOULD ANY BLOW, SPILL, OR TRACK OVER AND UPON SAID PUBLIC OR ADJACENT PRIVATE PROPERTY, AN IMMEDIATE REMEDY SHALL OCCUR. 8. SANITARY FACILITIES SHALL BE MAINTAINED ON THE SITE.

9. DURING THE RAINY SEASON, ALL PAVED AREAS SHALL BE KEPT CLEAR OF EARTH MATERIAL AND DEBRIS. THE SITE SHALL BE MAINTAINED SO AS TO MINIMIZE SEDIMENT LADEN RUNOFF TO ANY STORM DRAINAGE SYSTEMS, INCLUDING EXISTING DRAINAGE SWALES AND WATER COURSES.

10. CONSTRUCTION OPERATIONS SHALL BE CARRIED OUT IN SUCH A MANNER THAT EROSION AND WATER POLLUTION WILL BE MINIMIZED. STATE AND LOCAL LAWS CONCERNING

11. CONTRACTORS SHALL PROVIDE DUST CONTROL AS REQUIRED BY THE APPROPRIATE FEDERAL, STATE, AND LOCAL AGENCY REQUIREMENTS.

12. WITH THE APPROVAL OF THE ENGINEER, EROSION AND SEDIMENT CONTROLS MAYBE REMOVED AFTER AREAS ABOVE THEM HAVE BEEN STABILIZED. EROSION CONTROL MAINTENANCE NOTES

1. MAINTENANCE IS TO BE PERFORMED AS FOLLOWS. A. REPAIR DAMAGES CAUSED BY SOIL EROSION OR CONSTRUCTION AT THE END OF EACH WORKING DAY. B. SWALES SHALL BE INSPECTED PERIODICALLY AND MAINTAINED AS NEEDED. C. SEDIMENT TRAPS, BERMS, AND SWALES ARE TO BE INSPECTED AFTER EACH STORM

AND REPAIRS MADE AS NEEDED. D. SEDIMENT SHALL BE REMOVED AND SEDIMENT TRAPS RESTORED TO ORIGINAL DIMENSIONS WHEN SEDIMENT HAS ACCUMULATED TO A DEPTH OF ONE FOOT. E. SEDIMENT REMOVED FROM TRAP SHALL BE DEPOSITED IN A SUITABLE AREA AND IN SUCH A MANNER THAT IT WILL NOT ERODE. F. RILLS AND GULLIES MUST BE REPAIRED.

2. STRAW BALE INLET PROTECTION SHALL BE CLEANED OUT WHENEVER SEDIMENT DEPTH IS ONE HALF THE HEIGHT OF ONE FOOT.

EROSION AND SEDIMENT CONTROL MEASURES 1. THE FACILITIES SHOWN ON THIS PLAN ARE DESIGNED TO CONTROL EROSION AND SEDIMENT DURING THE RAINY SEASON, OCTOBER 15 TO APRIL 15. FACILITIES ARE TO BE OPERABLE PRIOR TO OCTOBER 1 OF ANY YEAR. GRADING OPERATIONS DURING THE RAINY SEASON, WHICH LEAVE DENUDED SLOPES SHALL BE PROTECTED WITH EROSION CONTROL MEASURES IMMEDIATELY FOLLOWING GRADING ON THE SLOPES.

CONDITIONS AS SHOWN ON THE EROSION CONTROL PLAN. PRIOR TO SEPTEMBER 15, THE COMPLETION OF SITE IMPROVEMENT SHALL BE EVALUATED AND REVISIONS MADE TO THIS PLAN AS NECESSARY WITH THE APPROVAL OF THE ENGINEER.

3. CONSTRUCTION ENTRANCES SHALL BE INSTALLED PRIOR TO COMMENCEMENT OF GRADING. ALL CONSTRUCTION TRAFFIC ENTERING ONTO THE PAVED ROADS MUST CROSS THE STABILIZED CONSTRUCTION ENTRANCEWAYS.

4. CONTRACTOR SHALL MAINTAIN STABILIZED ENTRANCE AT EACH VEHICLE ACCESS POINT TO EXISTING PAVED STREETS. ANY MUD OR DEBRIS TRACKED ONTO PUBLIC STREETS SHALL BE REMOVED DAILY AND AS REQUIRED BY THE COUNTY.

5. APPLY STRAW WITH TACKIFIER TO ALL DISTURBED AREAS, AFTER SEEDING. ANCHOR STRAW IN SLOPES BY TRACK ROLLING, AS SHOWN ON THIS SHEET.

6. IF HYDROSEEDING IS NOT USED OR IS NOT EFFECTIVE BY OCTOBER 10, THEN OTHER IMMEDIATE METHODS SHALL BE IMPLEMENTED, SUCH AS EROSION CONTROL BLANKETS, OR A

7. INLET PROTECTION SHALL BE INSTALLED AT OPEN INLETS TO PREVENT SEDIMENT FROM ENTERING THE STORM DRAIN SYSTEM. INLETS USED IN CONJUNCTION WITH EROSION CONTROL

THREE-STEP APPLICATION OF 1) SEED, MULCH, FERTILIZER; 2) BLOWN STRAW; 3) TACKFIER

ARE TO BE BLOCKED TO PREVENT ENTRY OF SEDIMENT. 8. THIS EROSION AND SEDIMENT CONTROL PLAN MAY NOT COVER ALL THE SITUATIONS THAT MAY ARISE DURING CONSTRUCTION DUE TO UNANTICIPATED FIELD CONDITIONS. VARIATIONS AND ADDITIONS MAY BE MADE TO THIS PLAN IN THE FIELD. NOTIFY THE COUNTY REPRESENTATIVE

OF ANY FIELD CHANGES. EMPLOYEE TRAINING

1. STORM WATER POLLUTION PREVENTION TRAINING SHALL BE PROVIDED AT THE BEGINNING OF CONSTRUCTION AND REGULARLY DURING CONSTRUCTION FOR ALL EMPLOYEES WORKING ON THE JOB SITE. TRAINING SHALL BE PROVIDED BY THE CONTRACTOR'S WATER POLLUTION CONTROL MANAGER. TOPICS SHALL INCLUDE, BUT


- SPILL PREVENTION AND RESPONSE; LOCATIONS AND FUNCTIONS OF SEDIMENT/EROSION CONTROL DEVICES;
- GOOD HOUSEKEEPING FINES AND PENALTIES;
- MATERIAL MANAGEMENT PRACTICES.

OBSERVATION AND MAINTENANCE 1. VISUALLY OBSERVE AND MAINTAIN BMPs AS FOLLOWS:

- A. INSPECT BMPs:
- WITHIN 48 HOURS PRIOR TO EACH STORM EVENT, AND
- WITHIN 48 HOURS AFTER EACH STORM EVENT.
- B. REPAIR DAMAGED BMPs WITHIN 48 HOURS OF OBSERVATION. C. SEDIMENT SHALL BE REMOVED FROM SEDIMENT CONTROL BMPs BEFORE SEDIMENT HAS ACCUMULATED TO A DEPTH OF ONE THIRD THE HEIGHT OF THE SEDIMENT BARRIER OR SUMP, IF NOT OTHERWISE SPECIFIED IN THE
- SPECIAL PROVISIONS OR BY THE BMP SUPPLIER OR MANUFACTURER. D. TRASH AND DEBRIS SHALL BE REMOVED FROM BMPs DURING SCHEDULED
- E. REMOVED SEDIMENT SHALL BE PLACED AT AN APPROVED LOCATION AND IN SUCH A MANNER THAT IT WILL NOT ERODE, OR SHALL BE DISPOSED OF
- F. REPAIR RILLS AND GULLIES BY RE-GRADING AND THEN TRACKWALKING PERPINDICULAR TO THE SLOPE. PROVIDE TEMPORARY SOIL COVER IF NECESSARY.

NON-STORM WATER DISCHARGES

- 1. NON-STORM WATER DISCHARGES INCLUDE A WIDE VARIETY OF SOURCES, INCLUDING IMPROPER DUMPING, SPILLS, OR LEAKAGE FROM STORAGE TANKS OR TRANSFER AREAS. NON-STORM WATER DISCHARGES MAY CONTRIBUTE SIGNIFICANT POLLUTANT LOADS TO RECEIVING WATERS, AND AS SUCH ARE
- 2. MEASURES TO CONTROL SPILLS, LEAKAGE, AND DUMPING, AND TO PREVENT ILLICIT CONNECTIONS DURING CONSTRUCTION, MUST BE TAKEN.
- 3. HOWEVER, CERTAIN NON-STORM WATER DISCHARGES MAY BE AUTHORIZED FOR THE COMPLETION OF CONSTRUCTION. AUTHORIZED NON-STORM WATER DISCHARGES MAY INCLUDE THOSE FROM DECHLORINATED POTABLE WATER COURSES CHOICE.
- FIRE HYDRANT FLUSHING,
- IRRIGATION OF VEGETATIVE EROSION CONTROL MEASURES,
- PIPE FLUSHING AND TESTING,
- WATER TO CONTROL DUST,
- UNCONTAMINATED GROUND WATER FROM DEWATERING, • OTHER DISCHARGES NOT SUBJECT TO A SEPARATE GENERAL NPDES PERMIT ADOPTED BY A REGIONAL WATER BOARD.
- THE DISCHARGE OF NON-STORM WATER IS AUTHORIZED UNDER THE FOLLOWING
- THE DISCHARGE DOES NOT CAUSE OR CONTRIBUTE TO A VIOLATION OF ANY WATER QUALITY STANDARD
- THE DISCHARGE DOES NOT VIOLATE ANY OTHER PROVISION OF THE
- GENERAL PERMIT THE DISCHARGE IS NOT PROHIBITED BY THE APPLICABLE BASIN PLAN
- THE DISCHARGER HAS INCLUDED AND IMPLEMENTED SPECIFIC BMPS REQUIRED BY THE GENERAL PERMIT TO PREVENT OR REDUCE THE CONTACT OF THE NONSTORM WATER DISCHARGE WITH CONSTRUCTION
- THE DISCHARGE DOES NOT CONTAIN TOXIC CONSTITUENTS IN TOXIC AMOUNTS OR (OTHER) SIGNIFICANT QUANTITIES OF POLLUTANTS
- THE DISCHARGE IS MONITORED AND MEETS THE APPLICABLE NALS AND
- THE DISCHARGER REPORTS THE SAMPLING INFORMATION IN THE ANNUAL
- IF ANY OF THE ABOVE CONDITIONS ARE NOT SATISFIED, THE DISCHARGE IS NOT AUTHORIZED.

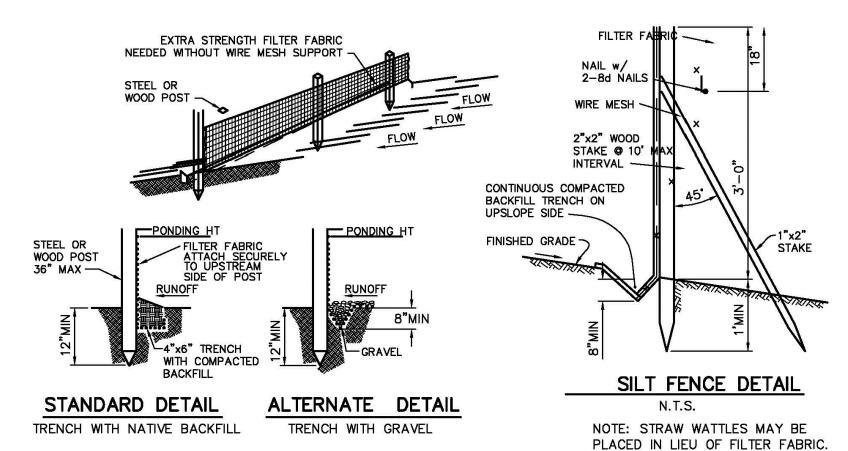

- SILT FENCE AND FILTER BARRIERS SHALL BE INSPECTED DURING AND IMMEDIATELY AFTER EACH RAINFALL, AND AT LEAST DAILY DURING PROLONGED RAINFALL. ANY REQUIRED REPAIRS SHALL BE MADE IMMEDIATELY. - SHOULD THE FABRIC ON A SILT FENCE OR FILTER BARRIER DECOMPOSE OR BECOME INEFFECTIVE DURING THE TIME THE FENCE OR BARRIER IS STILL NECESSARY, THE FABRIC SHALL BE REPLACED PROMPTLY.

- SEDIMENT DEPOSITS SHALL BE REMOVED WHEN DEPOSITS REACH APPROXIMATELY ONE- THIRD THE HEIGHT OF THE BARRIER. - ANY SEDIMENT DEPOSITS REMAINING IN PLACE AFTER THE SILT FENCE OR FILTER BARRIER IS NO LONGER REQUIRED SHALL BE DRESSED TO CONFORM WITH THE EXISTING GRADE, PREPARED, AND SEEDED. - SILT BUILDUPS MUST BE REMOVED WHEN BULGES DEVELOP IN THE FENCE REGARDLESS OF DEPTH OF DEPOSITION.

SILT FENCE DETAIL

NOT FOR CONSTRUCTION

RESIDENCE CAMINO REAL, 2 S.W. OI

2ND AVENUE CARMEL-BY-THE-SEA CALIFORNIA 93923

REVISIONS DATE **ARCHITECTURAL**


GRADING & CONSTRUCTION **MANAGEMENT**

Scale: SEE DWG. Drawn By: SBP


G1


Job: -

01/07/2019

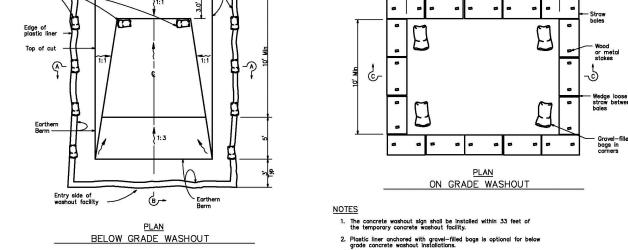

CONCRETE WASHOUT AREA

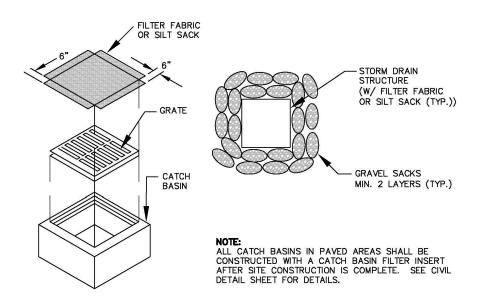

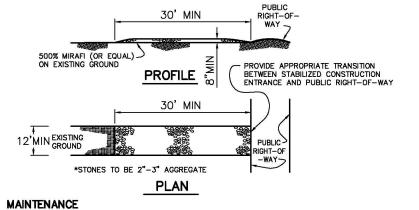


3. FOR OIL-BASED PAINTS, PAINT OUT BRUSHES TO THE EXTENT POSSIBLE AND CLEAN WITH THINNER OR SOLVENT IN PROPER CONTAINER. FILTER AND REUSE THINNERS AND SOLVENTS. DISPOSE OF RESIDUE AND UNUSABLE THINNER / SOLVENTS AS HAZARDOUS WASTE.

PAINT REMOVAL:

- 4. CHEMICAL PAINT STRIPPING RESIDUE AND CHIPS AND DUST FROM MARINE PAINTS OR PAINTS CONTAINING LEAD OR TRIBUTYLTIN MUST BE DISPOSED OF AS HAZARDOUS WASTE.
- 5. PAINT CHIPS AND DUST FROM NON-HAZARDOUS DRY STRIPPING AND SAND BLASTING MAY BE SWEPT UP OR COLLECTED IN PLASTIC DROP CLOTHS AND DISPOSED OF AS TRASH.

LANDSCAPE MATERIALS

- 1. CONTAIN STOCKPILED LANDSCAPING MATERIALS BY STORING THEM UNDER TARPS WHEN THEY ARE NOT ACTIVELY BEING USED.
- STACK ERODIBLE LANDSCAPE MATERIAL ON PALLETS. COVER OR STORE THESE MATERIAL WHEN THEY ARE NOT ACTIVELY BEING USED OR APPLIED.
- 3. DISCONTINUE APPLICATION OF ANY ERODIBLE LANDSCAPE MATERIAL WITHIN 2 DAYS BEFORE A FORECAST RAIN EVENT OR DURING WET WEATHER.

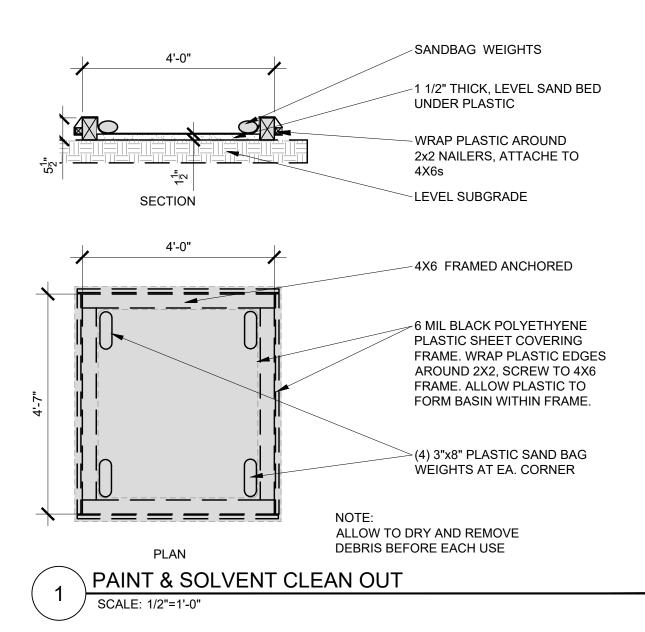

EARTHWORK AND CONTAMINATED SOILS

EROSION CONTROL:

- SCHEDULE GRADING AND EXCAVATION WORK FOR DRY WEATHER ONLY.
- STABILIZE ALL DENUDED AREAS, INSTALL AND MAINTAIN TEMPORARY EROSION CONTROLS (SUCH AS EROSION CONTROL FABRIC OR BONDED FIBER MATRIX) UNTIL VEGETATION IS ESTABLISHED.
- 3. SEED OR PLANT VEGETATION FOR EROSION CONTROL ON SLOPES OR WHERE CONSTRUCTION IS NOT IMMEDIATELY PLANNED.

SEDIMENT CONTROL:

- 4. PROTECT STORM DRAIN INLETS, GUTTERS, DITCHES, AND DRAINAGE COURSES WITH APPROPRIATE BMP'S, SUCH AS GRAVEL BAGS, FIBER ROLLS, BERMS, ETC.
- 5. PREVENT SEDIMENT FROM MIGRATING OFFSITE BY INSTALLING AND MAINTAINING SEDIMENT CONTROLS, SUCH AS FIBER ROLLS, SILT FENCES, OR SEDIMENT BASINS.
- KEEP EXCAVATED SOIL ON SITE WHERE IT WILL NOT COLLECT INTO THE STREET.
- 7. TRANSFER EXCAVATED MATERIALS TO DUMP TRUCKS ON THE SITE, NOT IN THE STREET.

CONTAMINATED SOILS:

- 8. IF ANY OF THE FOLLOWING CONDITIONS ARE OBSERVED, TEST FOR CONTAMINATION AND CONTACT THE REGIONAL WATER QUALITY CONTROL BOARD:
 - -UNUSUAL SOIL CONDITIONS, DISCOLORATION, OR ODOR -ABANDONED WELLS

-BURRIED BARRELS, DEBRIS OR TRASH

PAVING AND ASPHALT WORK

- 1. AVOID PAVING AND SEAL COATING IN WET WEATHER, OR WHEN RAIN IS FORECAST BEFORE FRESH PAVEMENT WILL HAVE TIME TO CURE
- 2. COVER STORM DRAIN INLETS AND MANHOLES WHEN APPLYING SEAL COAT, TACK COAT, SLURRY SEAL, FOG SEAL, ETC.
- 3. COLLECT AND RECYCLE OR APPROPRIATELY DISPOSE OF EXCESS ABRASIVE GRAVEL OR SAND. DO NOT SWEEP OR WASH IT INTO THE GUTTERS.
- 4. DO NOT USE WATER TO WASH DOWN FRESH ASPHALT CONCRETE PAVEMENT.

SAW-CUTTING & ASPHALT / CONCRETE REMOVAL:

- 5. COMPLETELY COVER OR BARRICADE STORM DRAIN INLETS WHEN SAW CUTTING. USE FILTER FABRIC, CATCH BASIN INLET FILTERS, OR GRAVEL BAGS TO KEEP SLURRY OUT OF THE STORM DRAIN SYSTEM.
- 6. SHOVEL, ABSORB, OR VACUUM SAW-CUT SLURRY AND SIPOSE OF ALL WASTE AS SOON AS FINISHED IN ONE LOCATION OR AT THE END OF EACH WORK DAY (WHICHEVER IS SOONER).
- 7. IF SAW-CUT SLURRY ENTERS A CATCH BASIN, CLEAN UP IMMEDIATELY.

CONCRETE, GROUT AND MORTAR APPLICATION

- 1. STORE CONCRETE, GROUT AND MORTAR UNDER COVER, ON PALLETS AND AWAY FROM DRAINAGE AREAS. THESE MATERIALS MUST NEVER REACH A STORM DRAIN.
- WASH OUT CONCRETE EQUIPMENT / TRUCKS OFFSITE OR IN A CONTAINED AREA, SO THERE IS NO DISCHARGE INTO THE UNDERLYING SOIL OR ONTO SURROUNDING AREAS. LET CONCRETE HARDEN AND DISPOSE OF AS GARBAGE.
 COLLECT THE WASH WATER FROM WASHING EXPOSED
- AGGREGATE CONCRETE AND REMOVE IT FOR APPROPRIATE DISPOSAL OFFSITE.

DE-WATERING

- 1. EFFECTIVELY MANAGE ALL RUN-ON, ALL RUNOFF WITHIN THE SITE, AND ALL RUNOFF THAT DISCHARGES FROM THE SITE. DIVERT RUN-ON WATER FROM OFFSITE AWAY FROM ALL DISTURBED AREAS OR OTHERWISE ENSURE COMPLIANCE.
- 2. PRIOR TO DEWATERING, NOTIFY AND OBTAIN APPROVAL FROM THE CITY'S ENVIRONMENTAL COMPLIANCE MANAGER BEFORE DISCHARGING WATER TO A STREET, GUTTER OR STORM DRAIN.
- 3. IN AREAS OF KNOWN CONTAMINATION, TESTING IS REQUIRED PRIOR TO THE REUSE OR DISCHARGE OF GROUNDWATER. CONSULT WITH THE ENGINEER TO DETERMINE WHETHER TESTING IS REQUIRED AND HOW TO INTERPRET RESULTS. CONTAMINATED GROUNDWATER MUST BE TREATED OR HAULED OFF-SITE FOR PROPER DISPOSAL.

MATERIALS & WASTE MANAGEMENT

NON-HAZARDOUS MATERIALS:

- BERM AND COVER STOCKPILES OF SAND, DIRT OR OTHER CONSTRUCTION MATERIAL WITH TARPS WHEN RAIN IS FORECAST OR IF NOT ACTIVELY BEING USED WITHIN 14 DAYS.
- USE (BUT DON'T OVERUSE) RECLAIMED WATER FOR DUST CONTROL.

HAZARDOUS MATERIALS:

- LABEL ALL HAZARDOUS MATERIALS AND HAZARDOUS WASTES (SUCH AS PESTICIDES, PAINTS, THINNERS, SOLVENTS, FUEL, OIL AND ANTIFREEZE) IN ACCORDANCE WITH CITY, COUNTY, STATE AND FEDERAL REGULATIONS.
- 4. STORE HAZARDOUS MATERIALS AND WASTES IN WATER TIGHT CONTAINERS, STORE IN APPROPRIATE SECONDARY CONTAINMENT, AND COVER THEM AT THE END OF EVERY WORK DAY OR DURING WET WEATHER OR WHEN RAIN IS FORECAST.
- 5. FOLLOW MANUFACTURER'S APPLICATION INSTRUCTIONS FOR HAZARDOUS MATERIALS AND BE CAREFUL NOT TO USE MORE THAN NECESSARY. DO NOT APPLY CHEMICALS OUTDOORS WHEN RAIN IS FORECAST WITHIN 24 HOURS.
- 6. ARRANGE FOR APPROPRIATE DISPOSAL OF ALL HAZARDOUS WASTES.

WASTE MANAGEMENT:

- COVER WASTE DISPOSAL CONTAINERS SECURELY WITH TARPS AT THE END OF EVERY WORK DAY AND DURING WET WEATHER.
- 8. CHECK WASTE DISPOSAL CONTAINERS FREQUENTLY FOR LEAKS AND TO MAKE SURE THEY ARE NOT OVERFILLED. NEVER HOSE DOWN A DUMPSTER ON THE CONSTRUCTION SITE.
- 9. CLEAN OR REPLACE PORTABLE TOILETS AND INSPECT THEM FREQUENTLY FOR LEAKS AND SPILLS.
- 10. DISPOSE OF ALL WASTES AND DEBRIS PROPERLY. RECYCLE MATERIALS AND WASTES THAT CAN BE RECYCLED (SUCH AS ASPHALT, CONCRETE, AGGREGATE BASE MATERIALS, WOOD, GYP BOARD, PIPE, ETC)
- DISPOSE OF ALL LIQUID RESIDUES FROM PAINTS, THINNERS, SOLVENTS, GLUES, AND CLEANING FLUIDS AS HAZARDOUS WASTE.

CONSTRUCTION ENTRANCES AND PERIMETER:

- 12. ESTABLISH AND MAINTAIN EFFECTIVE PERIMETER CONTROLS AND STABILIZE ALL CONSTRUCTION ENTRANCES AND EXITS TO SUFFICIENTLY CONTROL EROSION AND SEDIMENT DISCHARGES RFOM SITE AND TRACKING OFF SITE.
- 13. SWEEP OR VACUUM ANY STREET TRACKING IMMEDIATELY AND SECURE SEDIMENT SOURCE TO PREVENT FURTHER TRACKING. NEVER HOSE DOWN STREETS TO CLEAN UP TRACKING.

EQUIPMENT MANAGEMENT & SPILL CONTROL

MAINTENANCE AND PARKING:

- DESIGNATE AN AREA, FITTED WITH APPROPRIATE BMP'S FOR VEHICLE AND EQUIPMENT PARKING AND STORAGE.
- 2. PERFORM MAJOR MAINTENANCE, REPAIR JOBS, AND VEHICLE AND EQUIPMENT WASHING OFF SITE.
- IF REFUELING OR VEHICLE MAINTENANCE MUST BE DONE ONSITE, WORK IN A BERMED AREA AWAY FROM STORM DRAINS AND OVER A DRIP PAN BIG ENOUGH TO COLLECT FLUIDS. RECYCLE OR DISPOSE OF FLUIDS AS HAZARDOUS WASTE.
- 4. IF VEHICLE OR EQUIPMENT CLEANING MUST BE DONE ONSITE,
 CLEAN WITH WATER ONLY IN A BERMED AREA THAT WILL NOT
 ALLOW RINSE WATER TO RUN INTO GUTTERS, STREETS, STORM
 DRAINS. OR SURFACE WATERS.
- DO NOT CLEAN VEHICLE OR EQUIPMENT ONSITE USING SOAPS, SOLVENTS, DEGREASERS, STEAM CLEANING EQUIPMENT, ETC.

SPILL PREVENTION AND CONTROL:

- 6. KEEP SPILL CLEANUP MATERIALS (RAGS, ABSORBENTS, ETC)
 AVAILABLE AT THE CONSTRUCTION SITE AT ALL TIMES.
- 7. INSPECT VEHICLES AND EQUIPMENT FREQUENTLY FOR AND REPAIR LEAKS PROMPTLY. USE DRIP PANS TO CATCH LEAKS UNTIL REPAIRS ARE MADE.
- 8. CLEAN UP SPILLS OR LEAKS IMMEDIATELY AND DISPOSE OF CLEANUP MATERIALS PROPERLY.
- 9. DO NOT HOSE DOWN SURFACES WHERE FLUIDS HAVE SPILLED.
 USE DRY CLEANUP METHODS (ABSORBENT MATERIALS, CAT
- LITTER, AND OR RAGS)

 10. SWEEP UP SPILLED DRY MATERIALS IMMEDIATELY. DO NOT TRY
 TO WASH THEM AWAY WITH WATER, OR BURY THEM.
- 11. CLEAN UP SPILLS ON DIRT AREAS BY DIGGING UP AND PROPERLY DISPOSING OF CONTAMINATED SOIL.
- 12. REPORT SIGNIFICANT SPILLS IMMEDIATELY. CONTRACTOR IS REQUIRED BY LAW TO REPORT ALL SIGNIFICANT RELEASES OF HAZARDOUS MATERIALS, INCLUDING OIL.

LI RESIDENCE

CAMINO REAL, 2 S.W. OF 2ND AVENUE CARMEL-BY-THE-SEA CALIFORNIA 93923



SAMUEL B. PITNICK
C - 34362
REN. 05/31/19

SAMUEL PITNICK ARG P.O. BOX 22412, CARMEL, CA 93922 PHONE: (831) 241-1895 EMAIL: SAMUELPITNICK@GMAIL.COM

REVISIONS DATE

BEST
MANAGEMENT
PRACTICES


Scale: SEE DWG.
Drawn By: SBP


Job: -


G1.2


01/07/2019


NOT FOR CONSTRUCTION

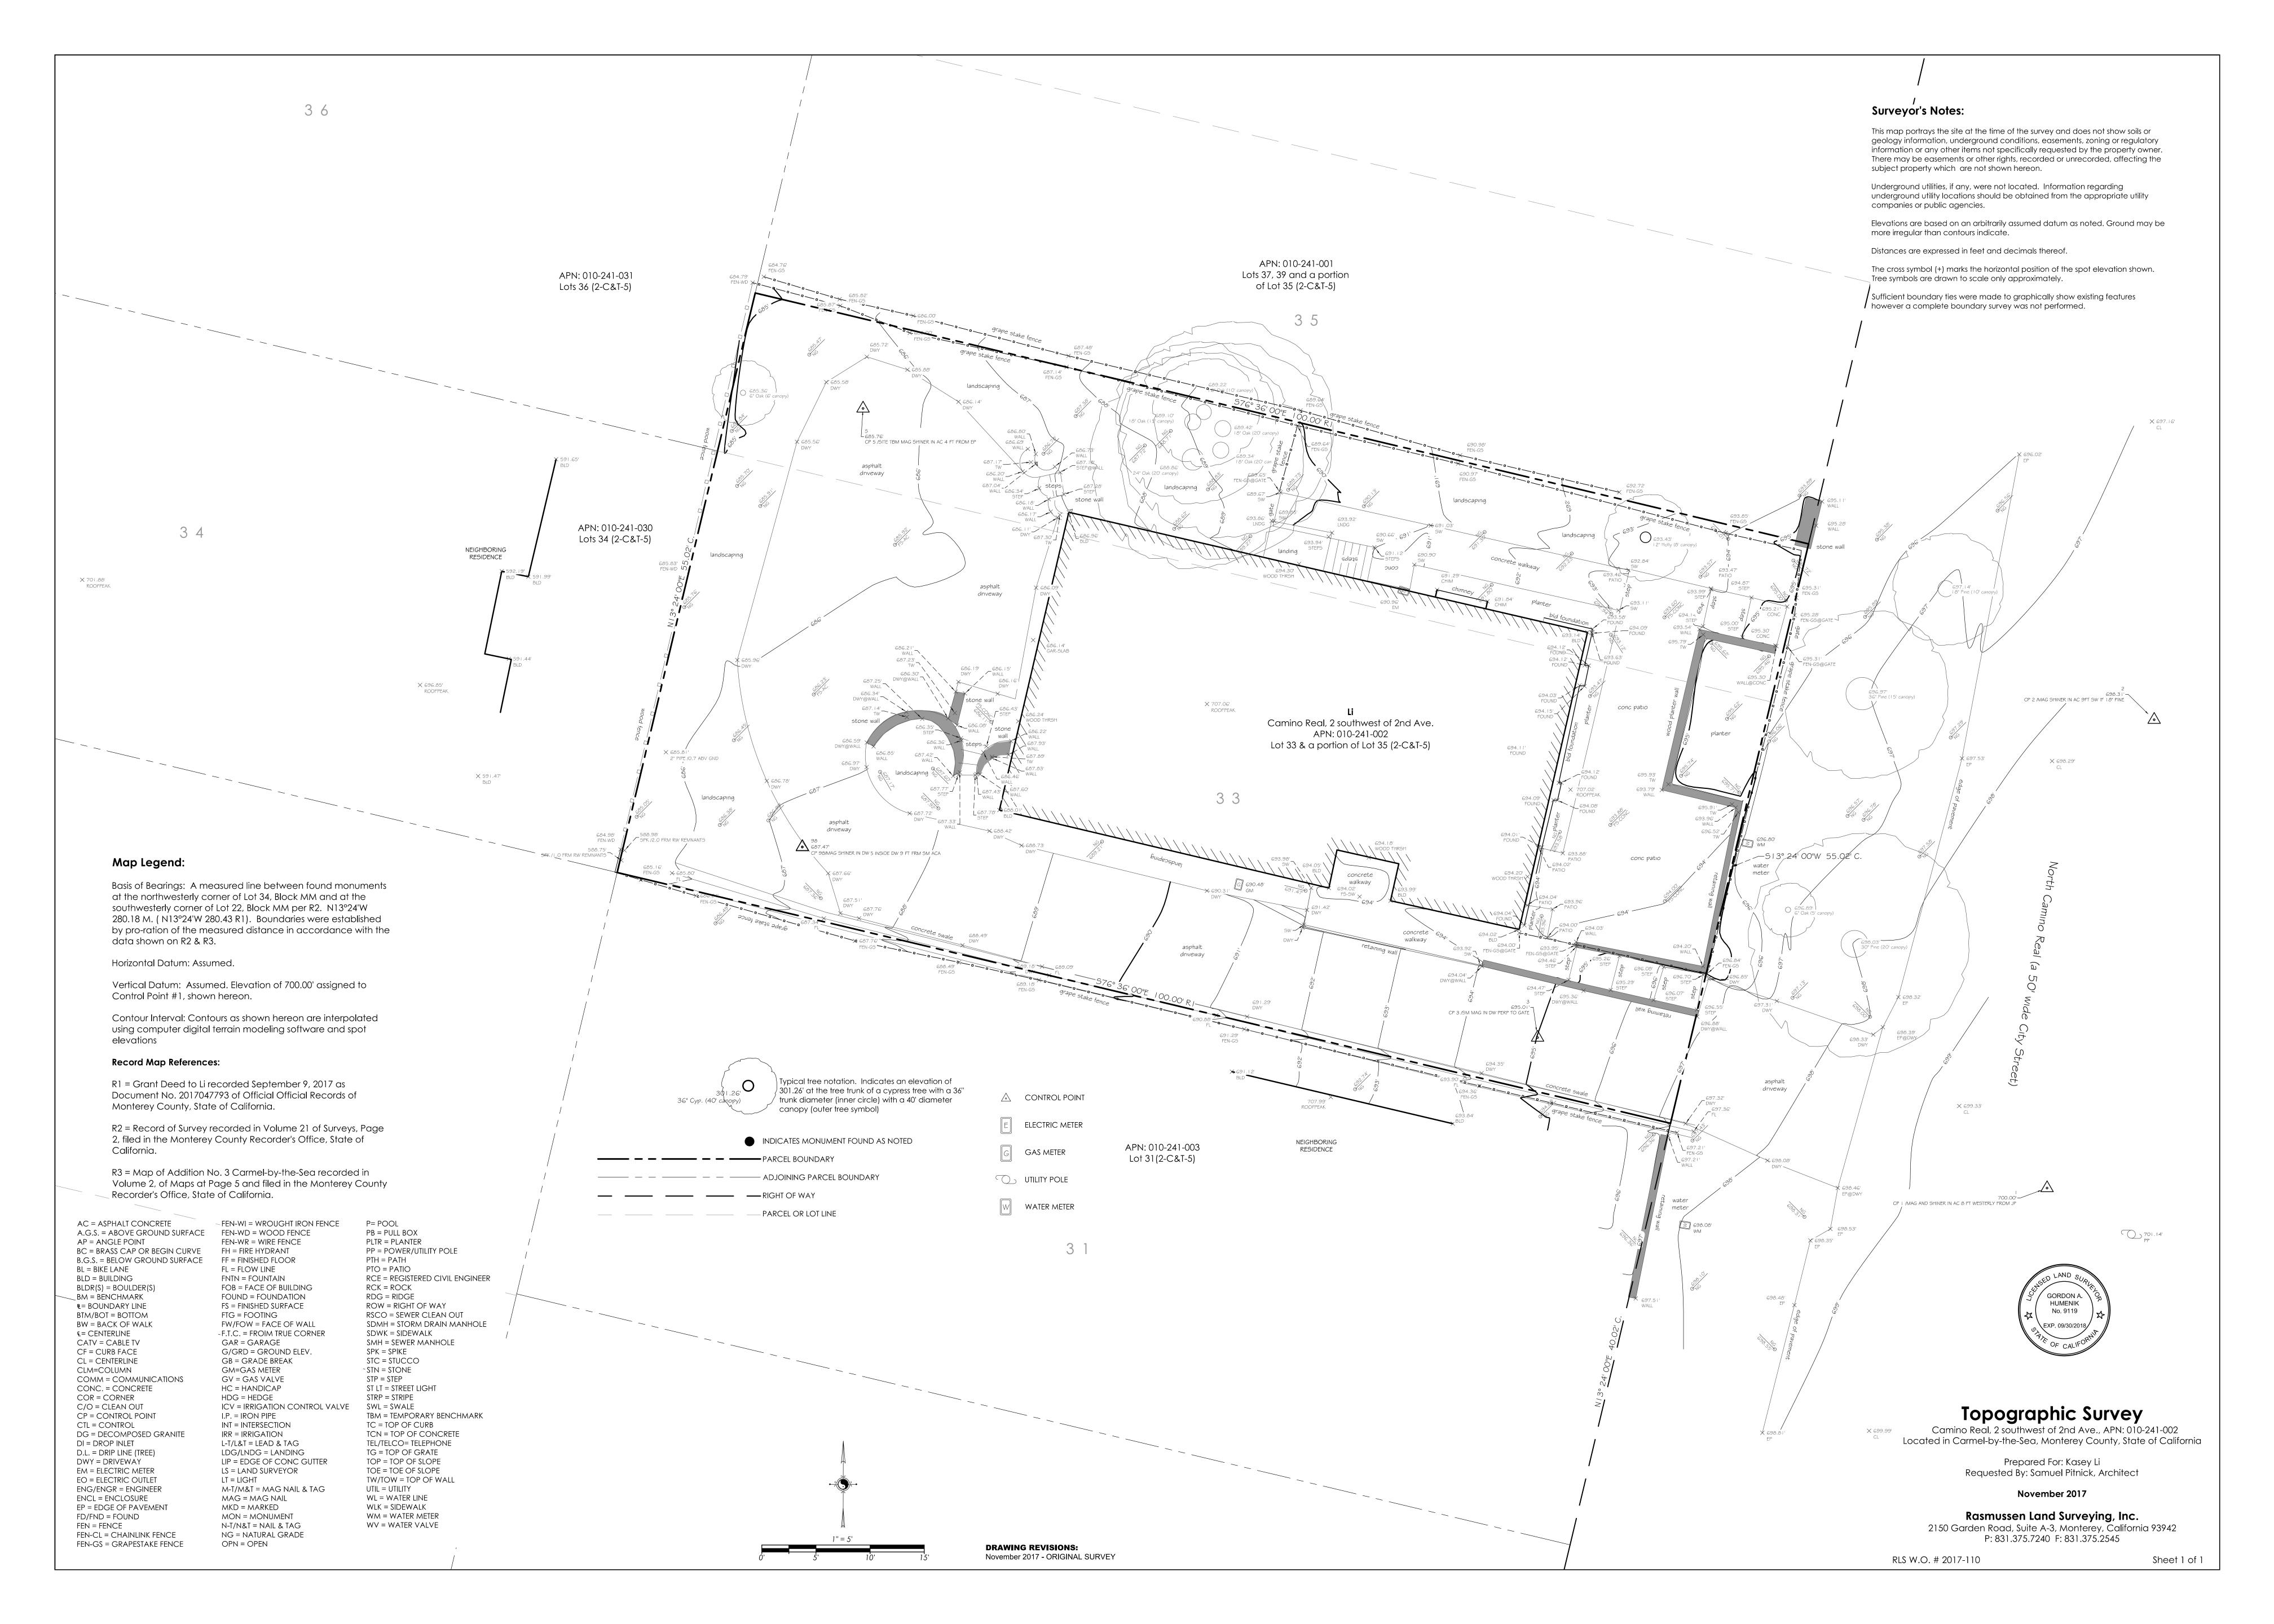


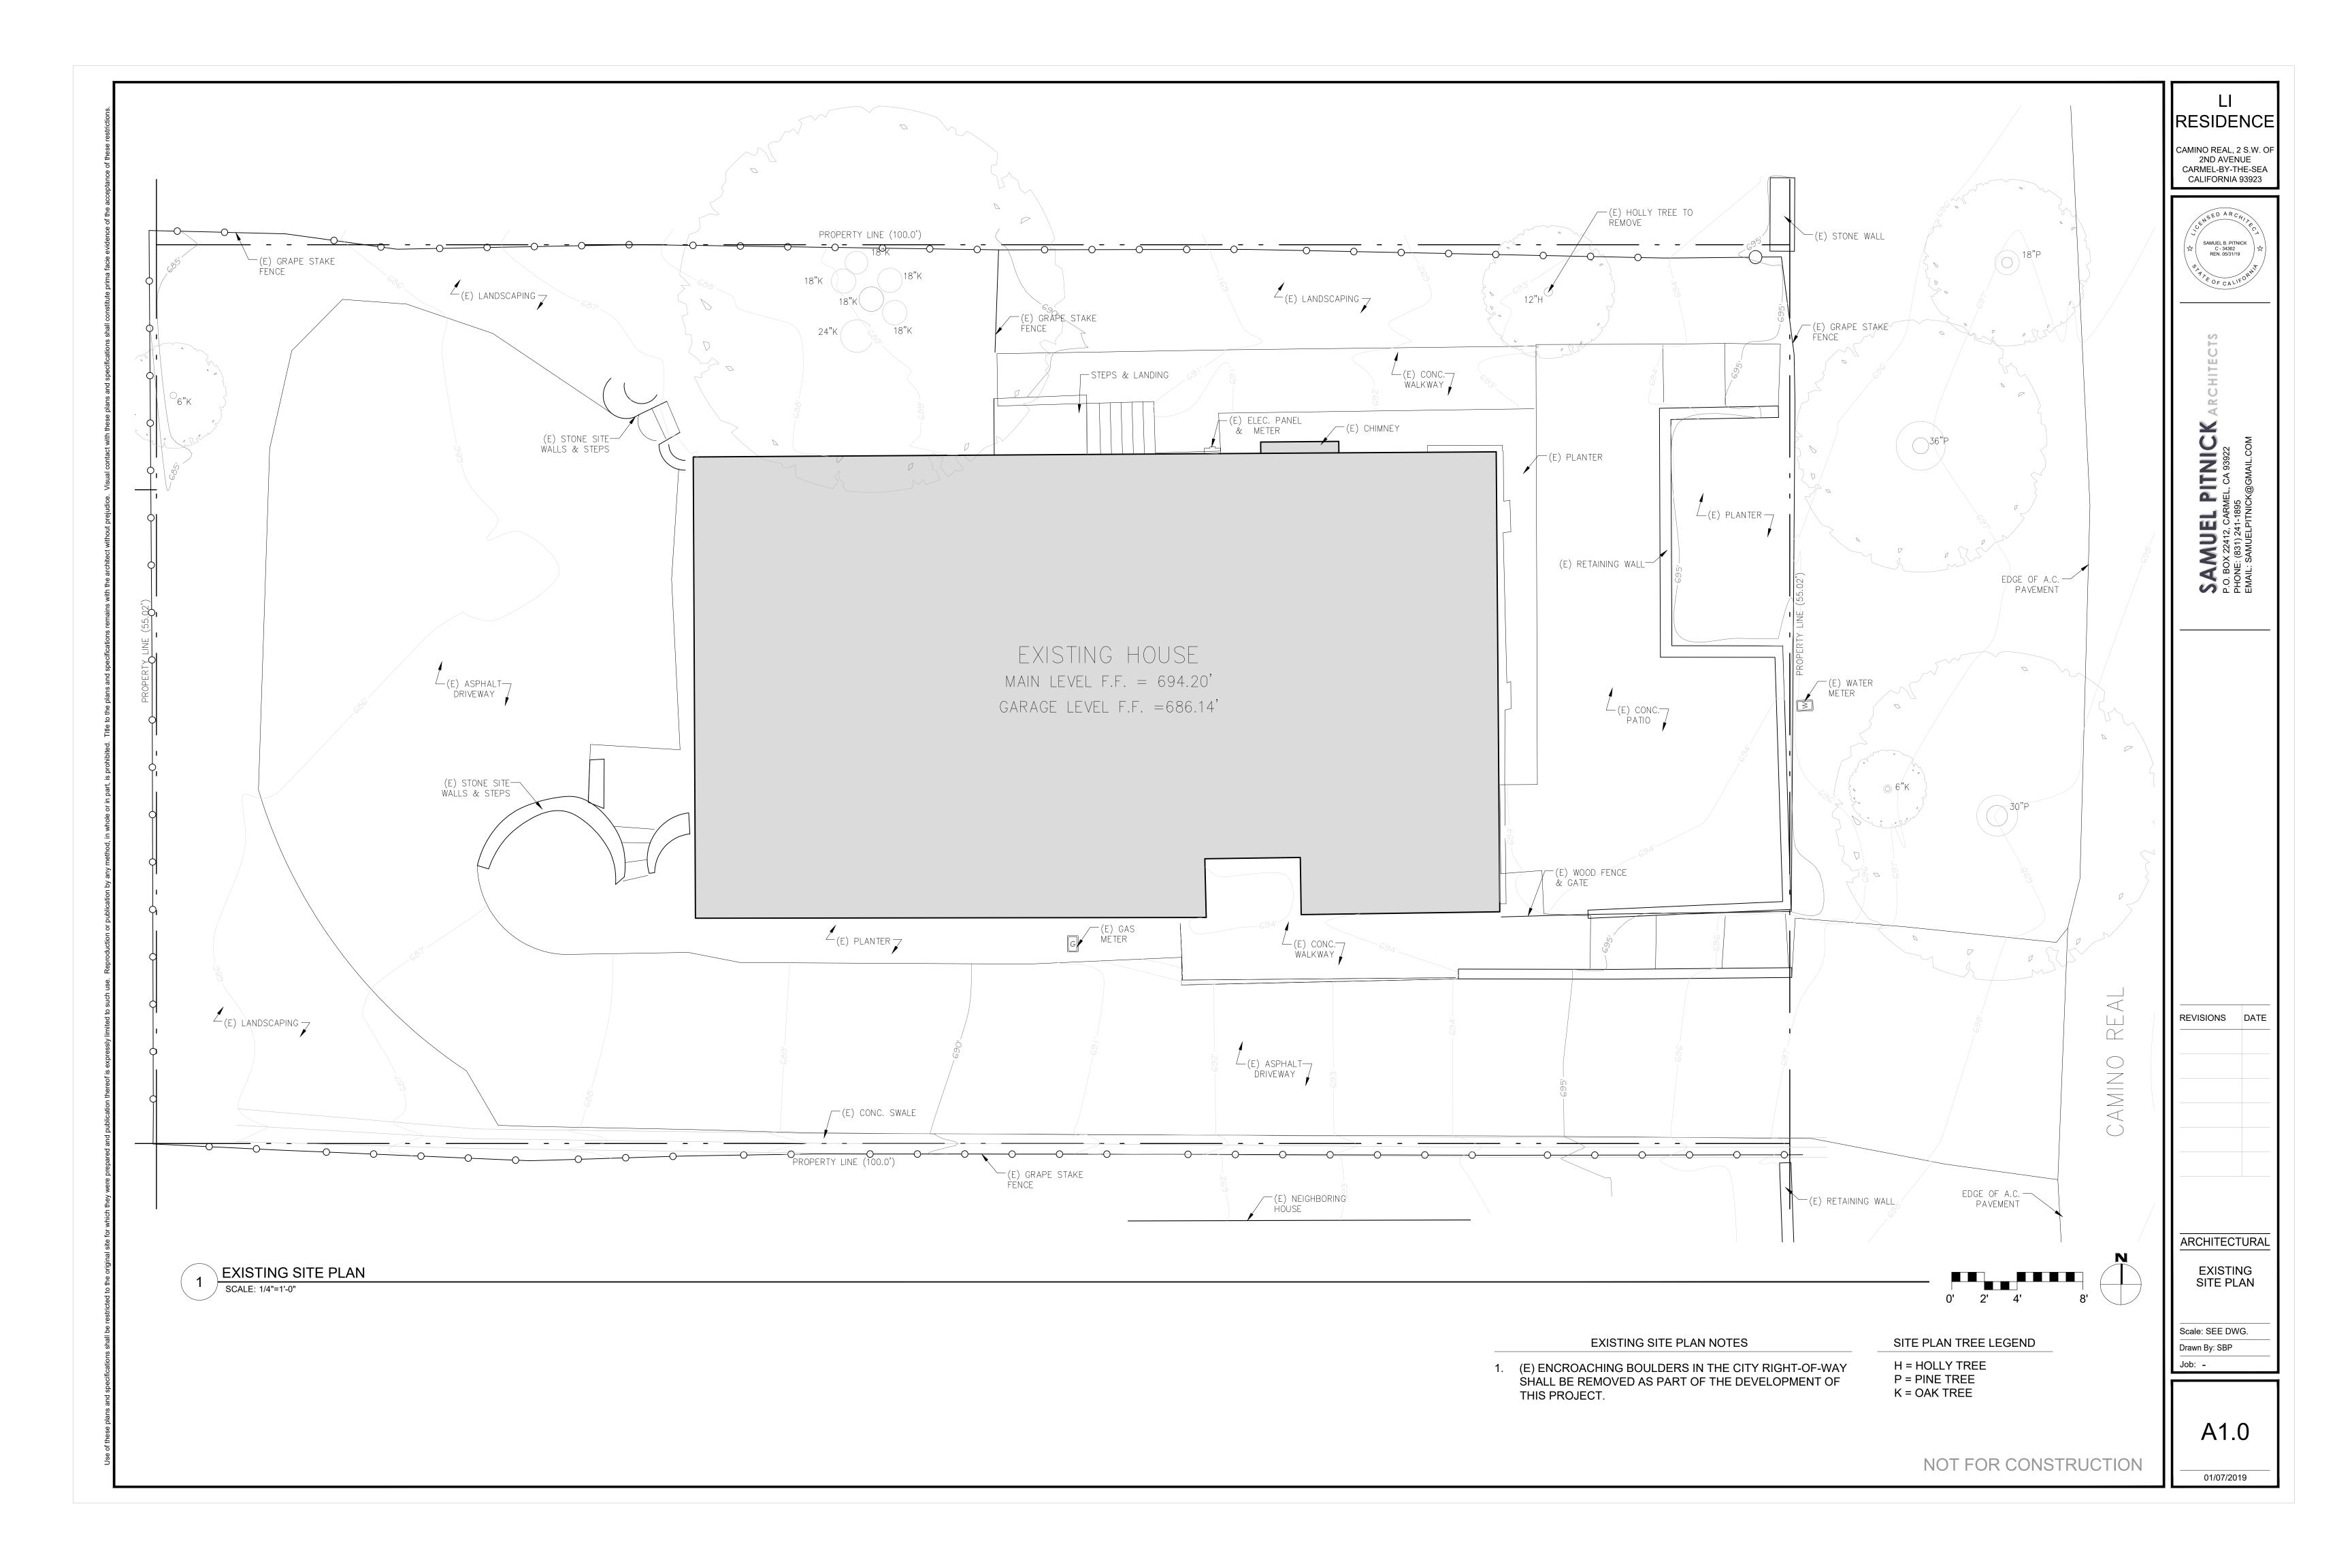


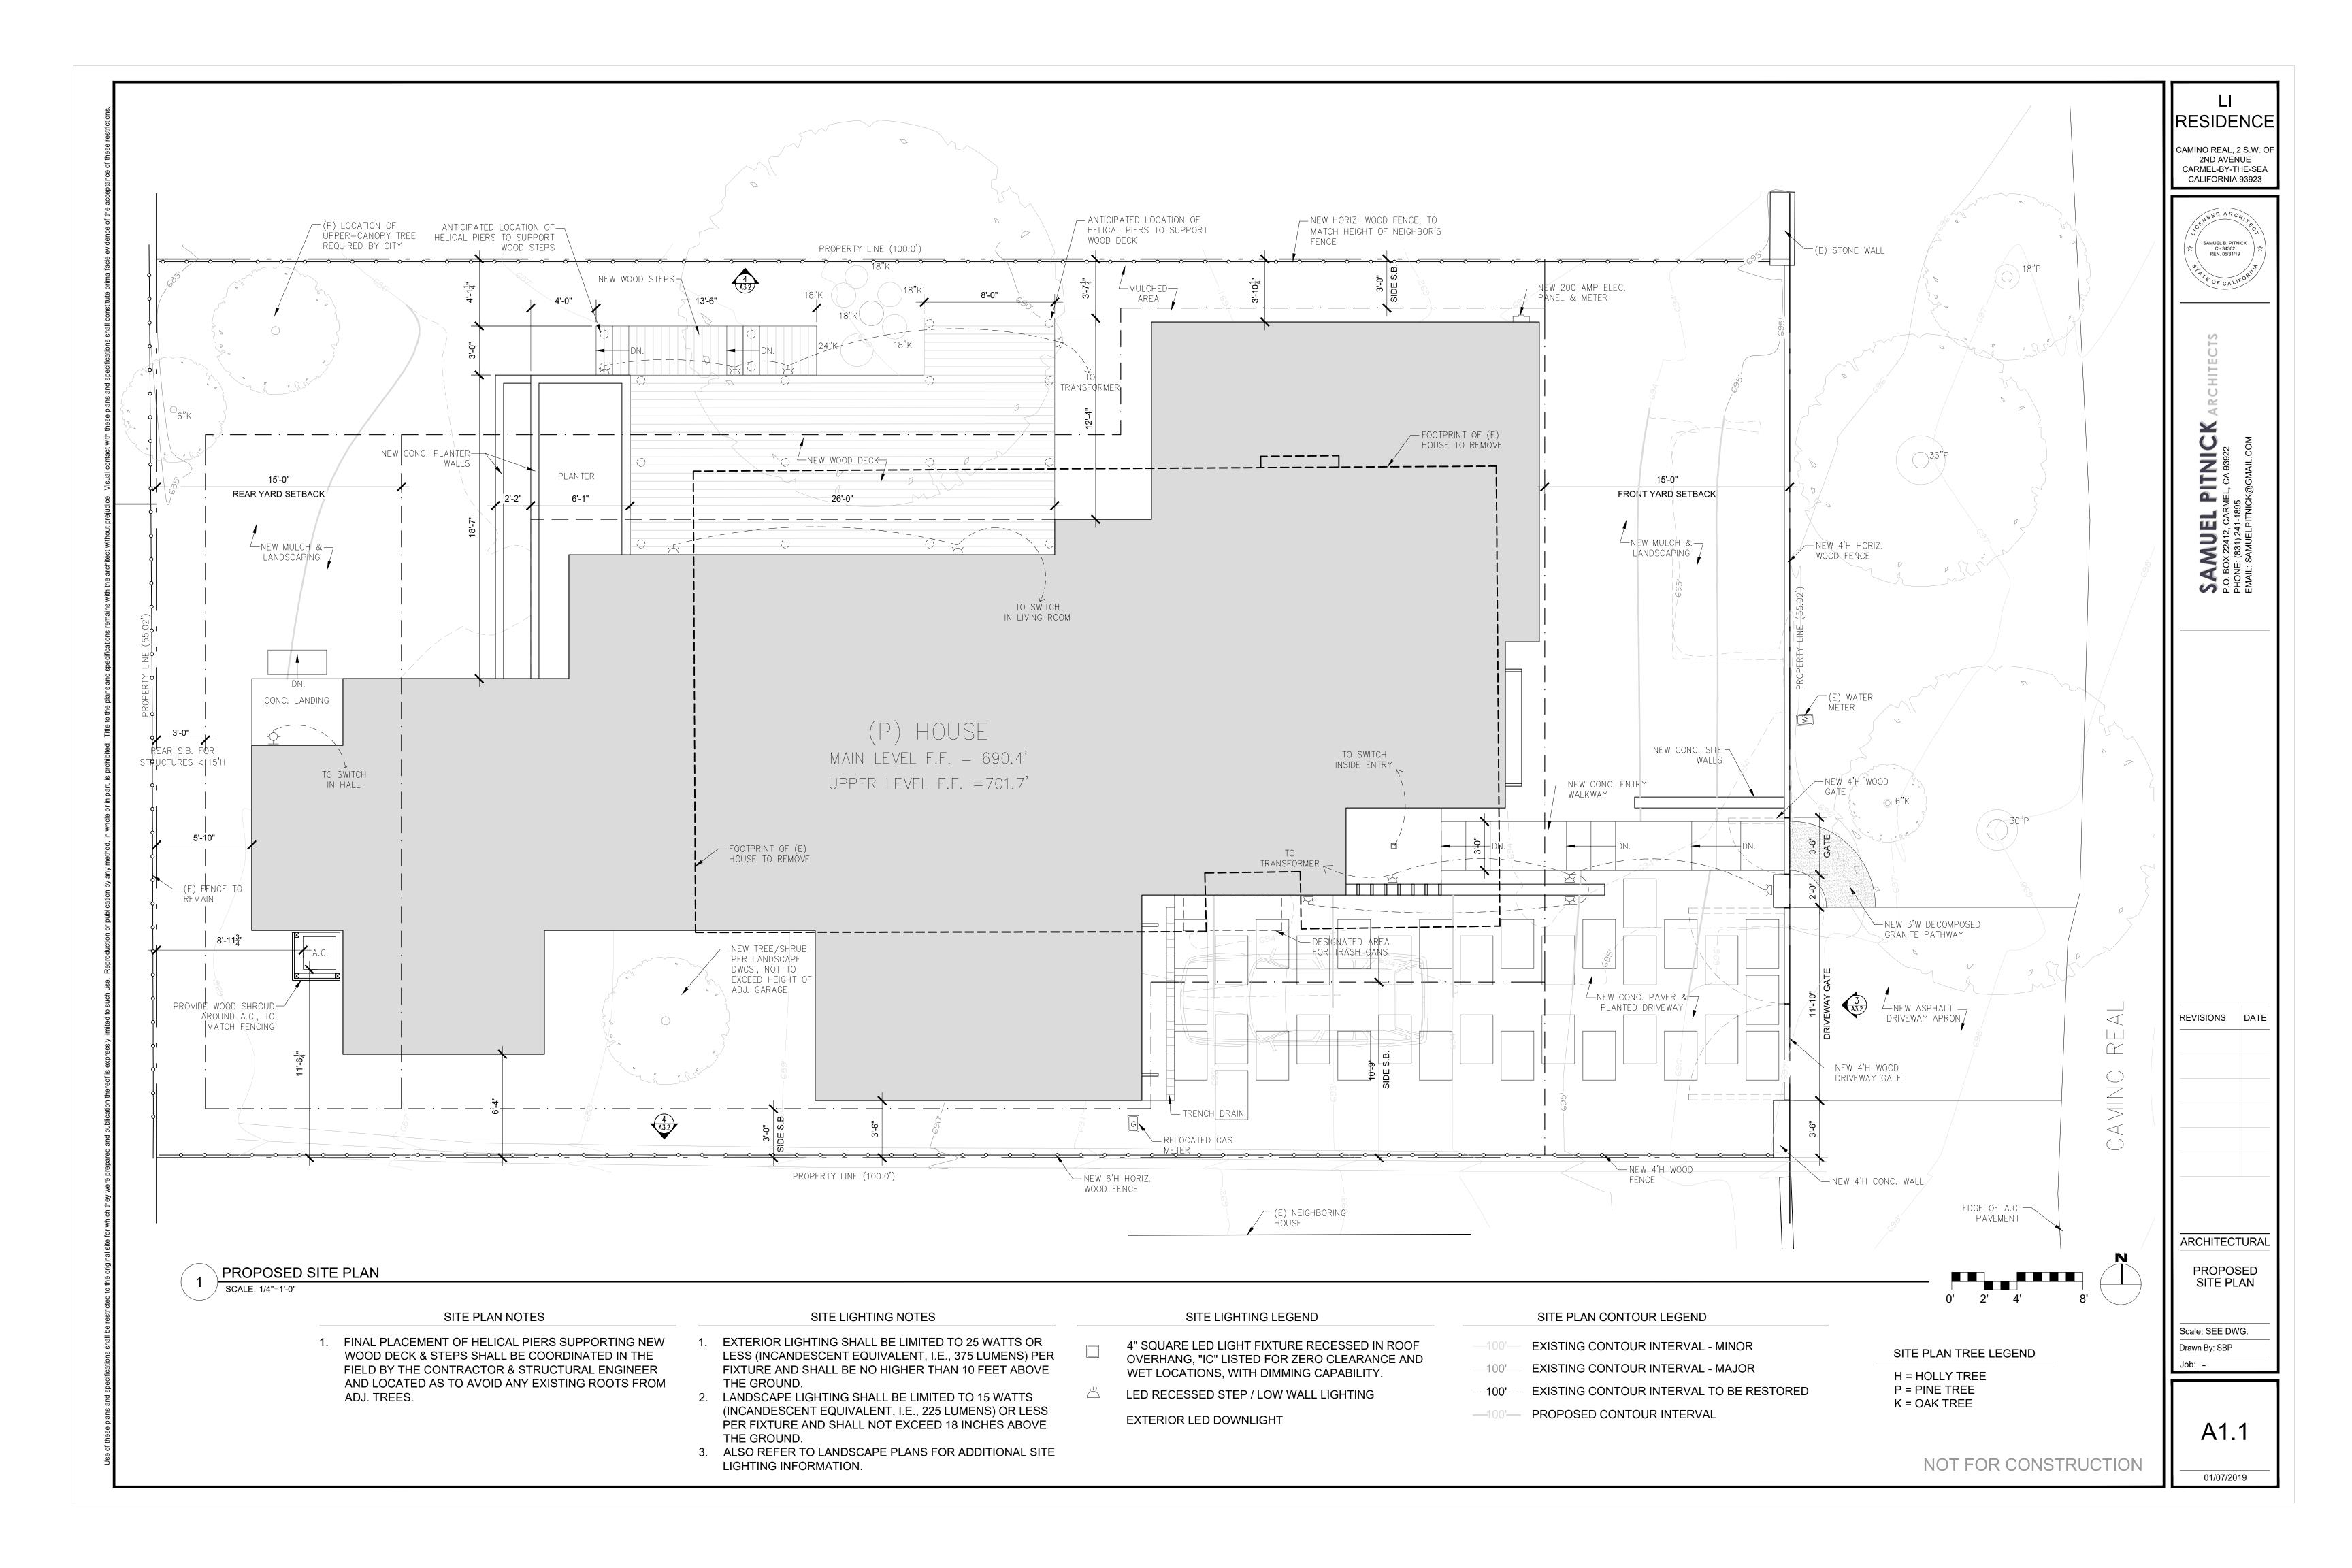


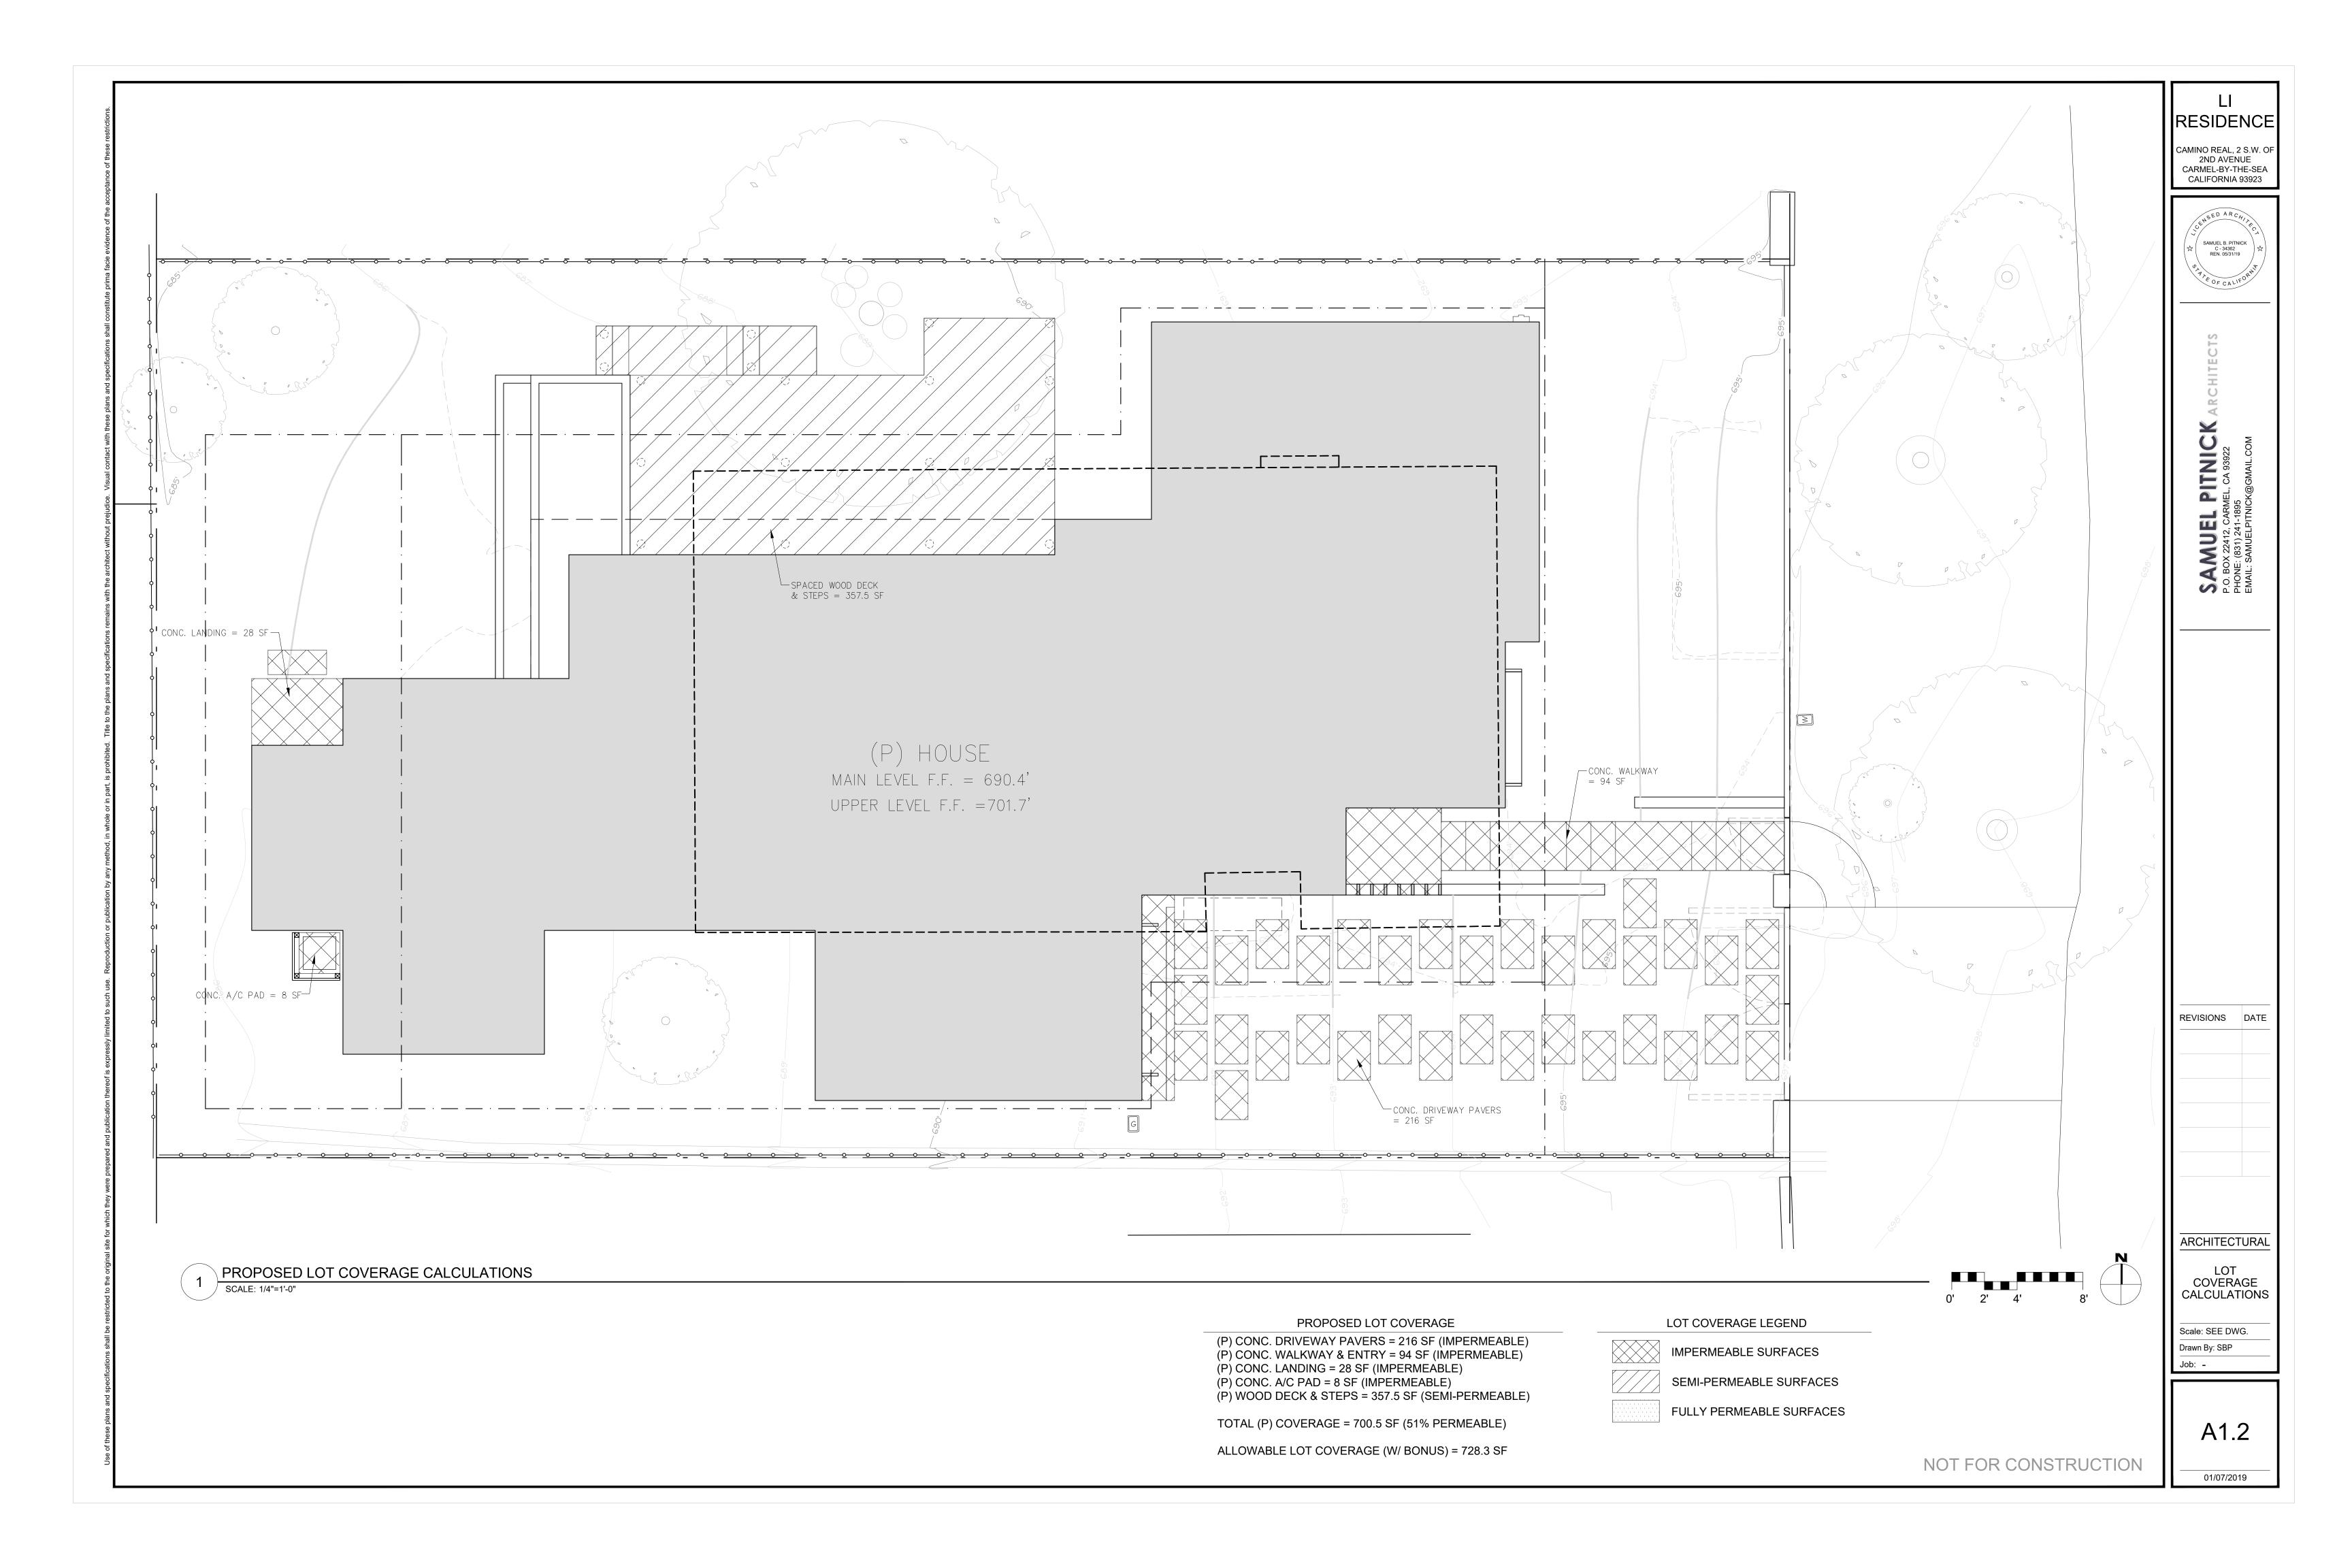


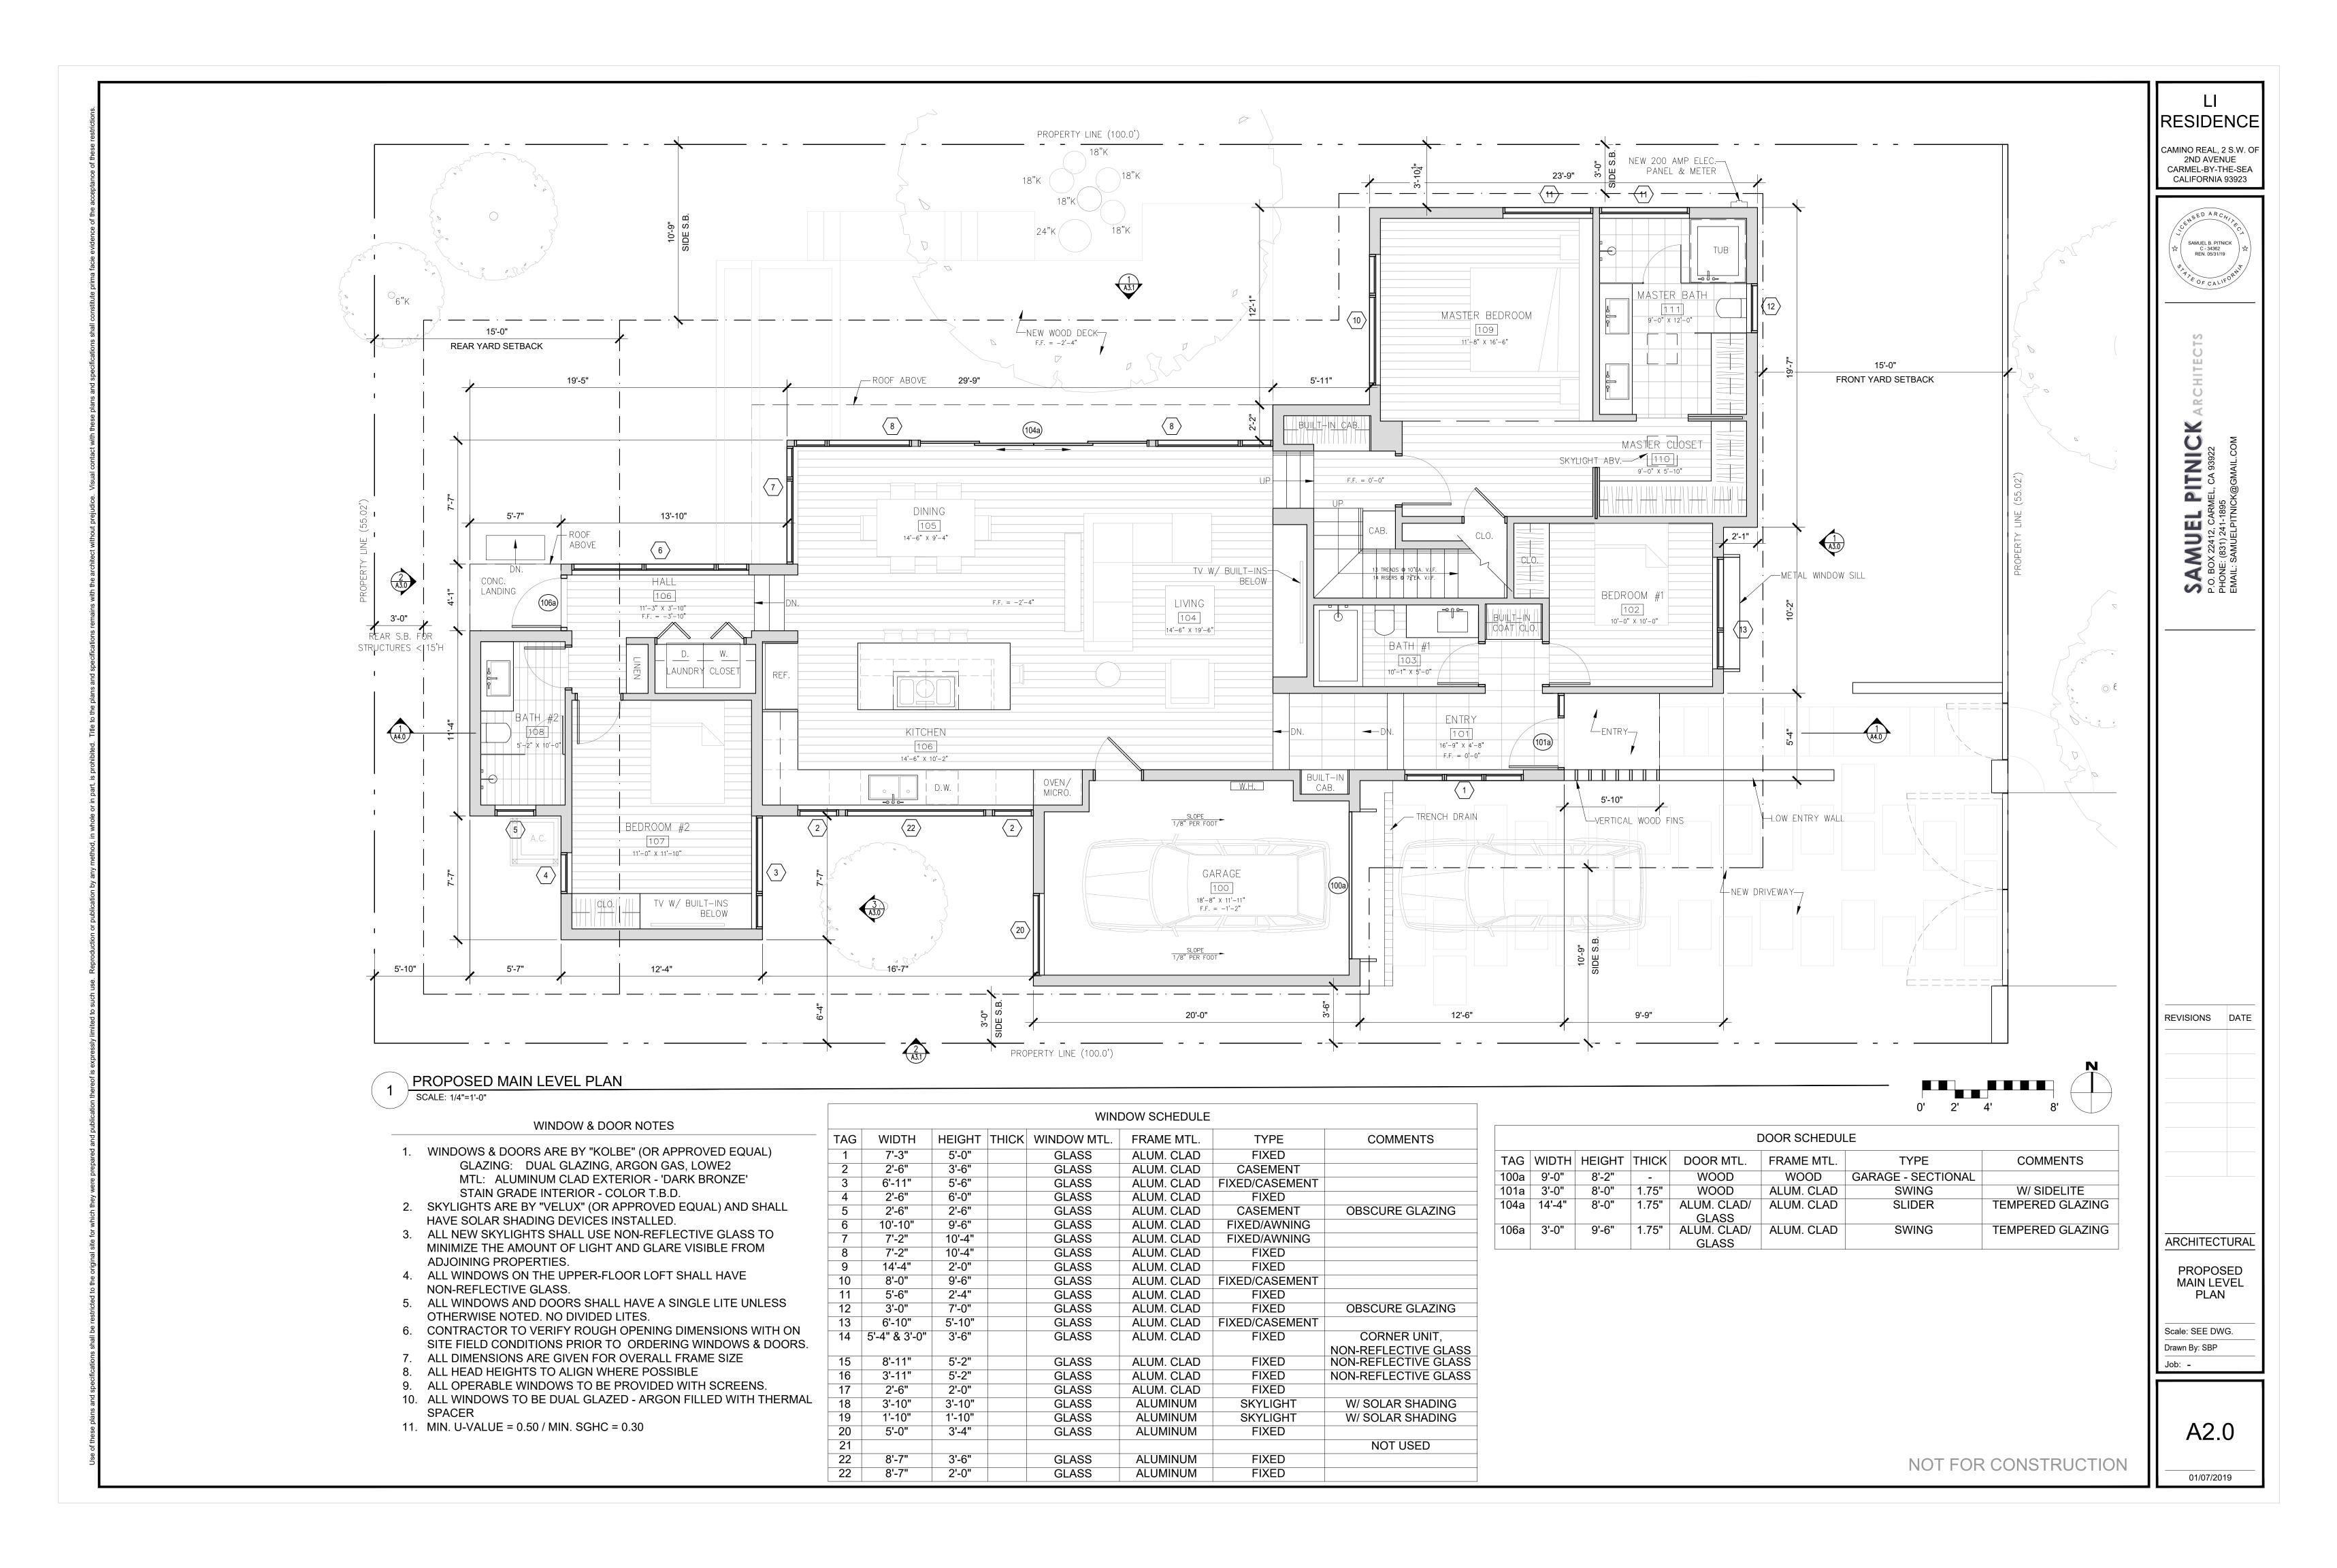

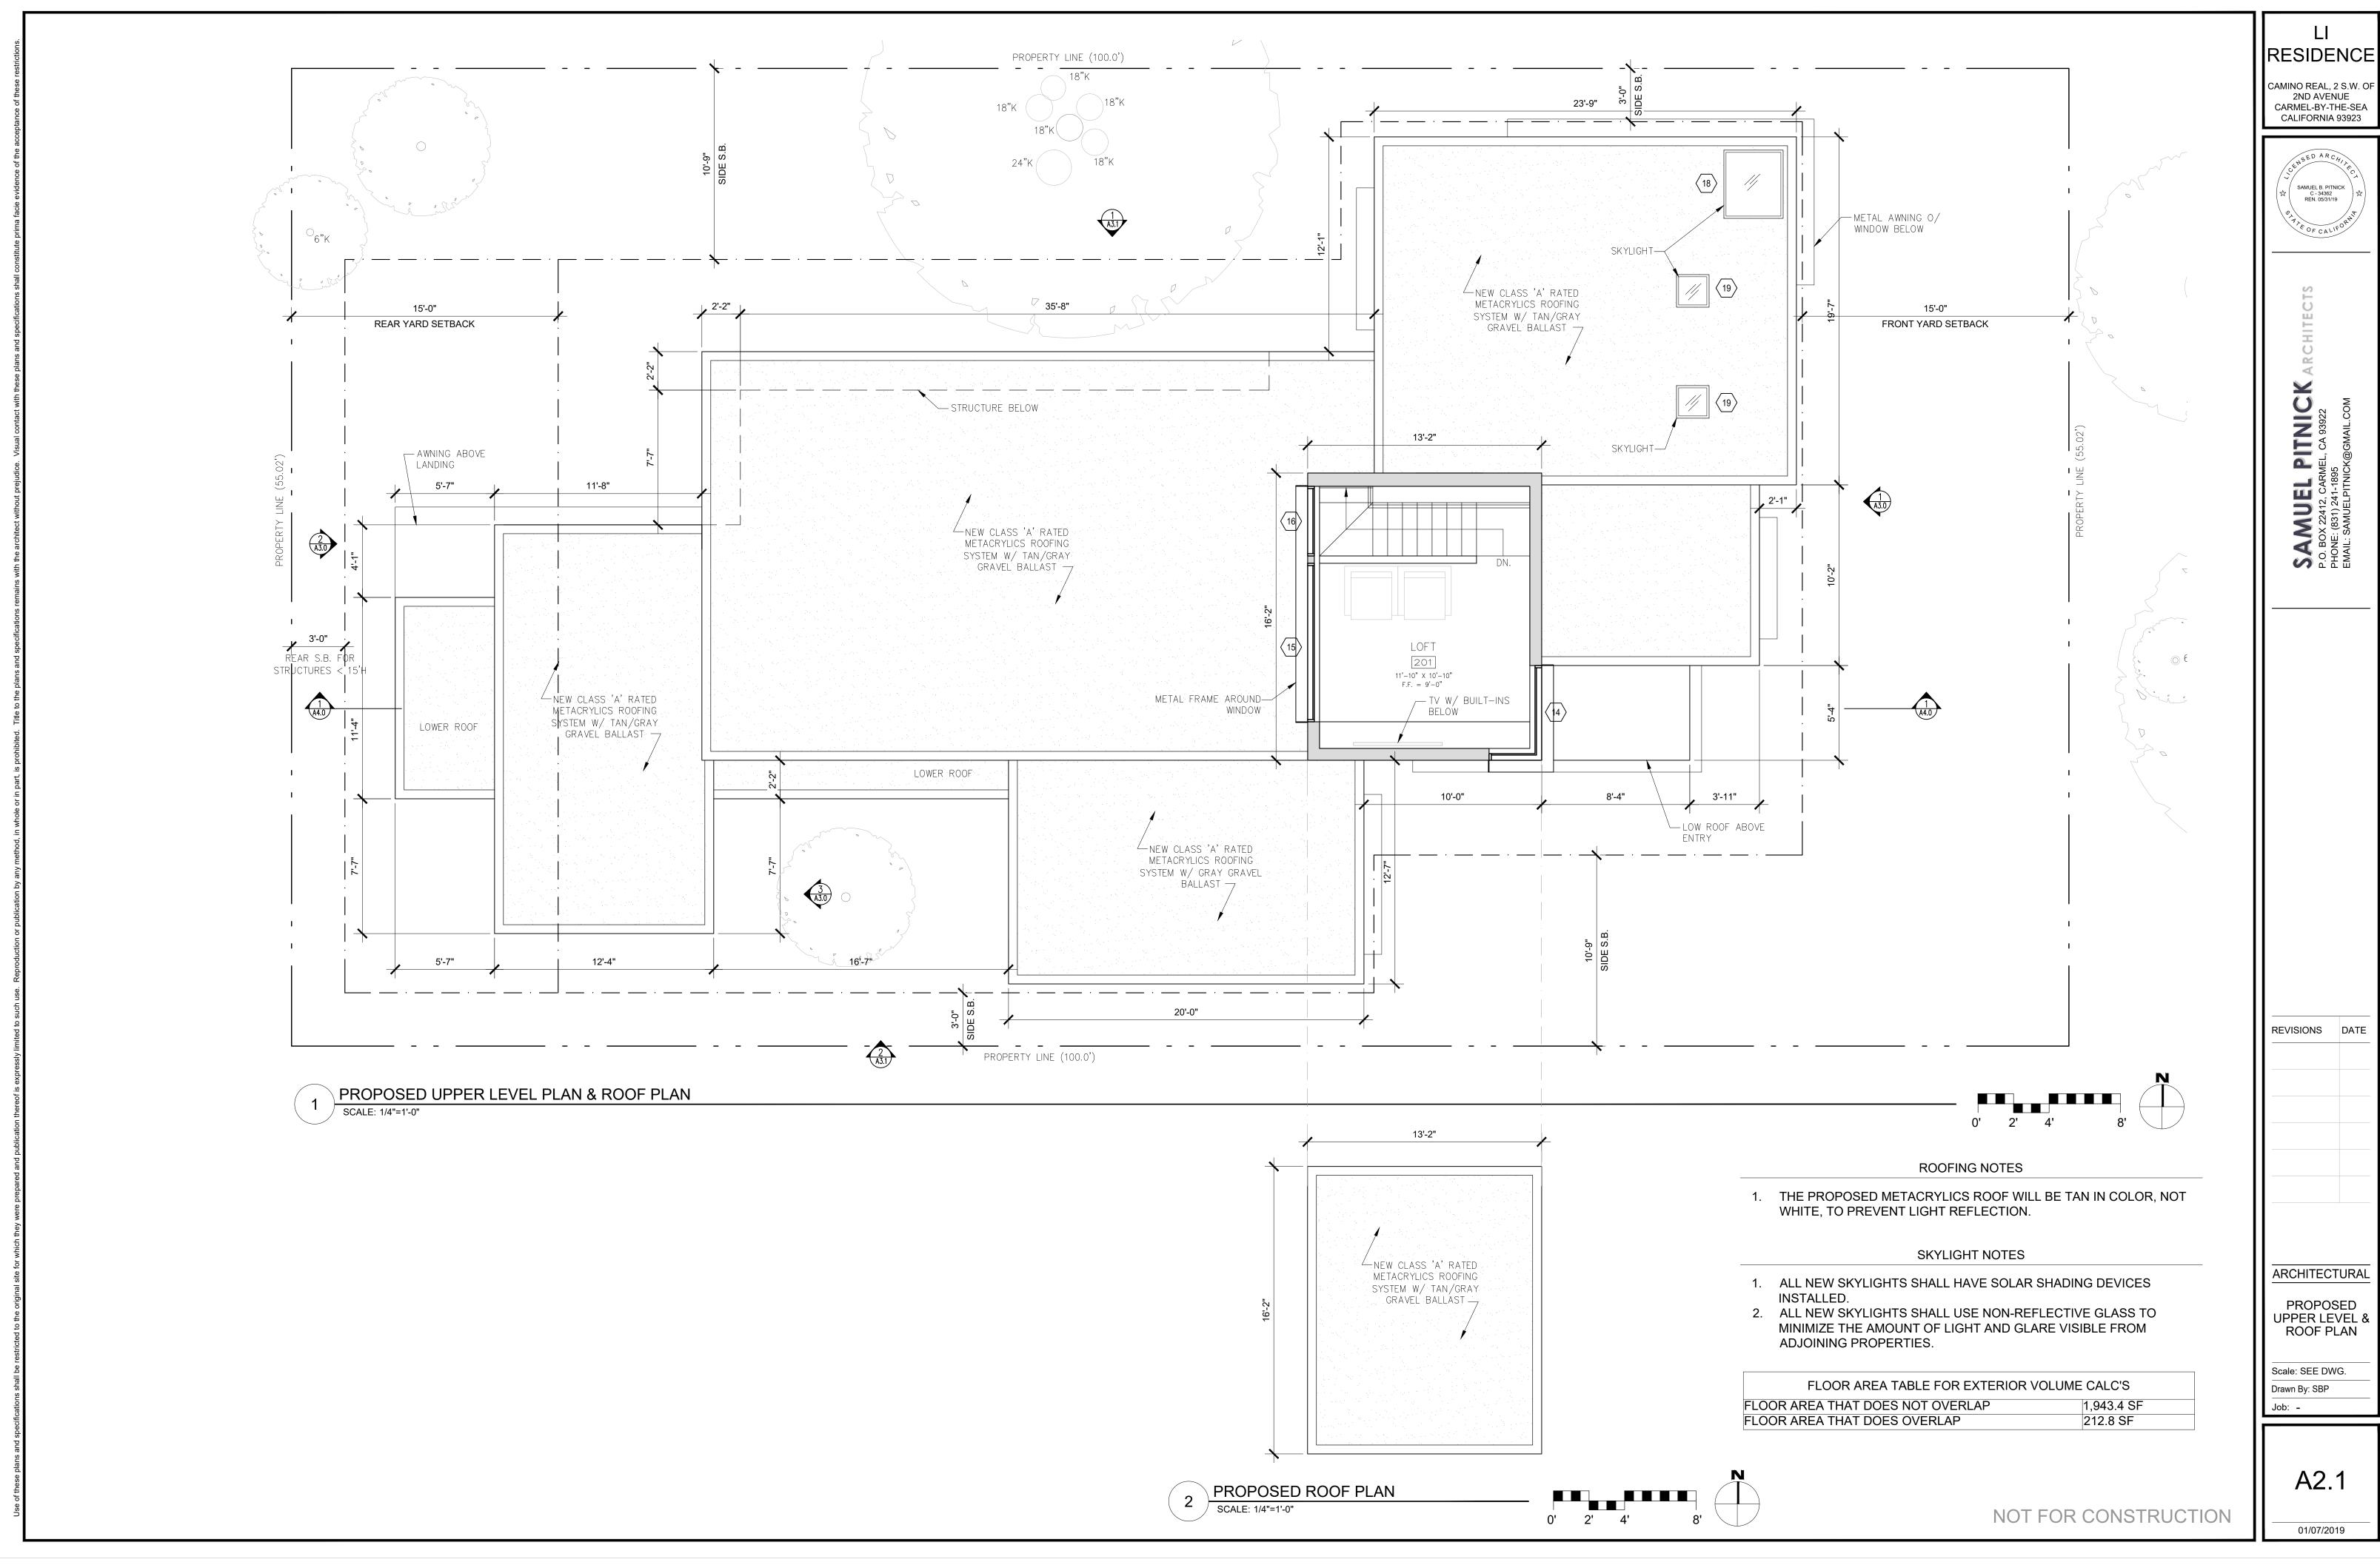

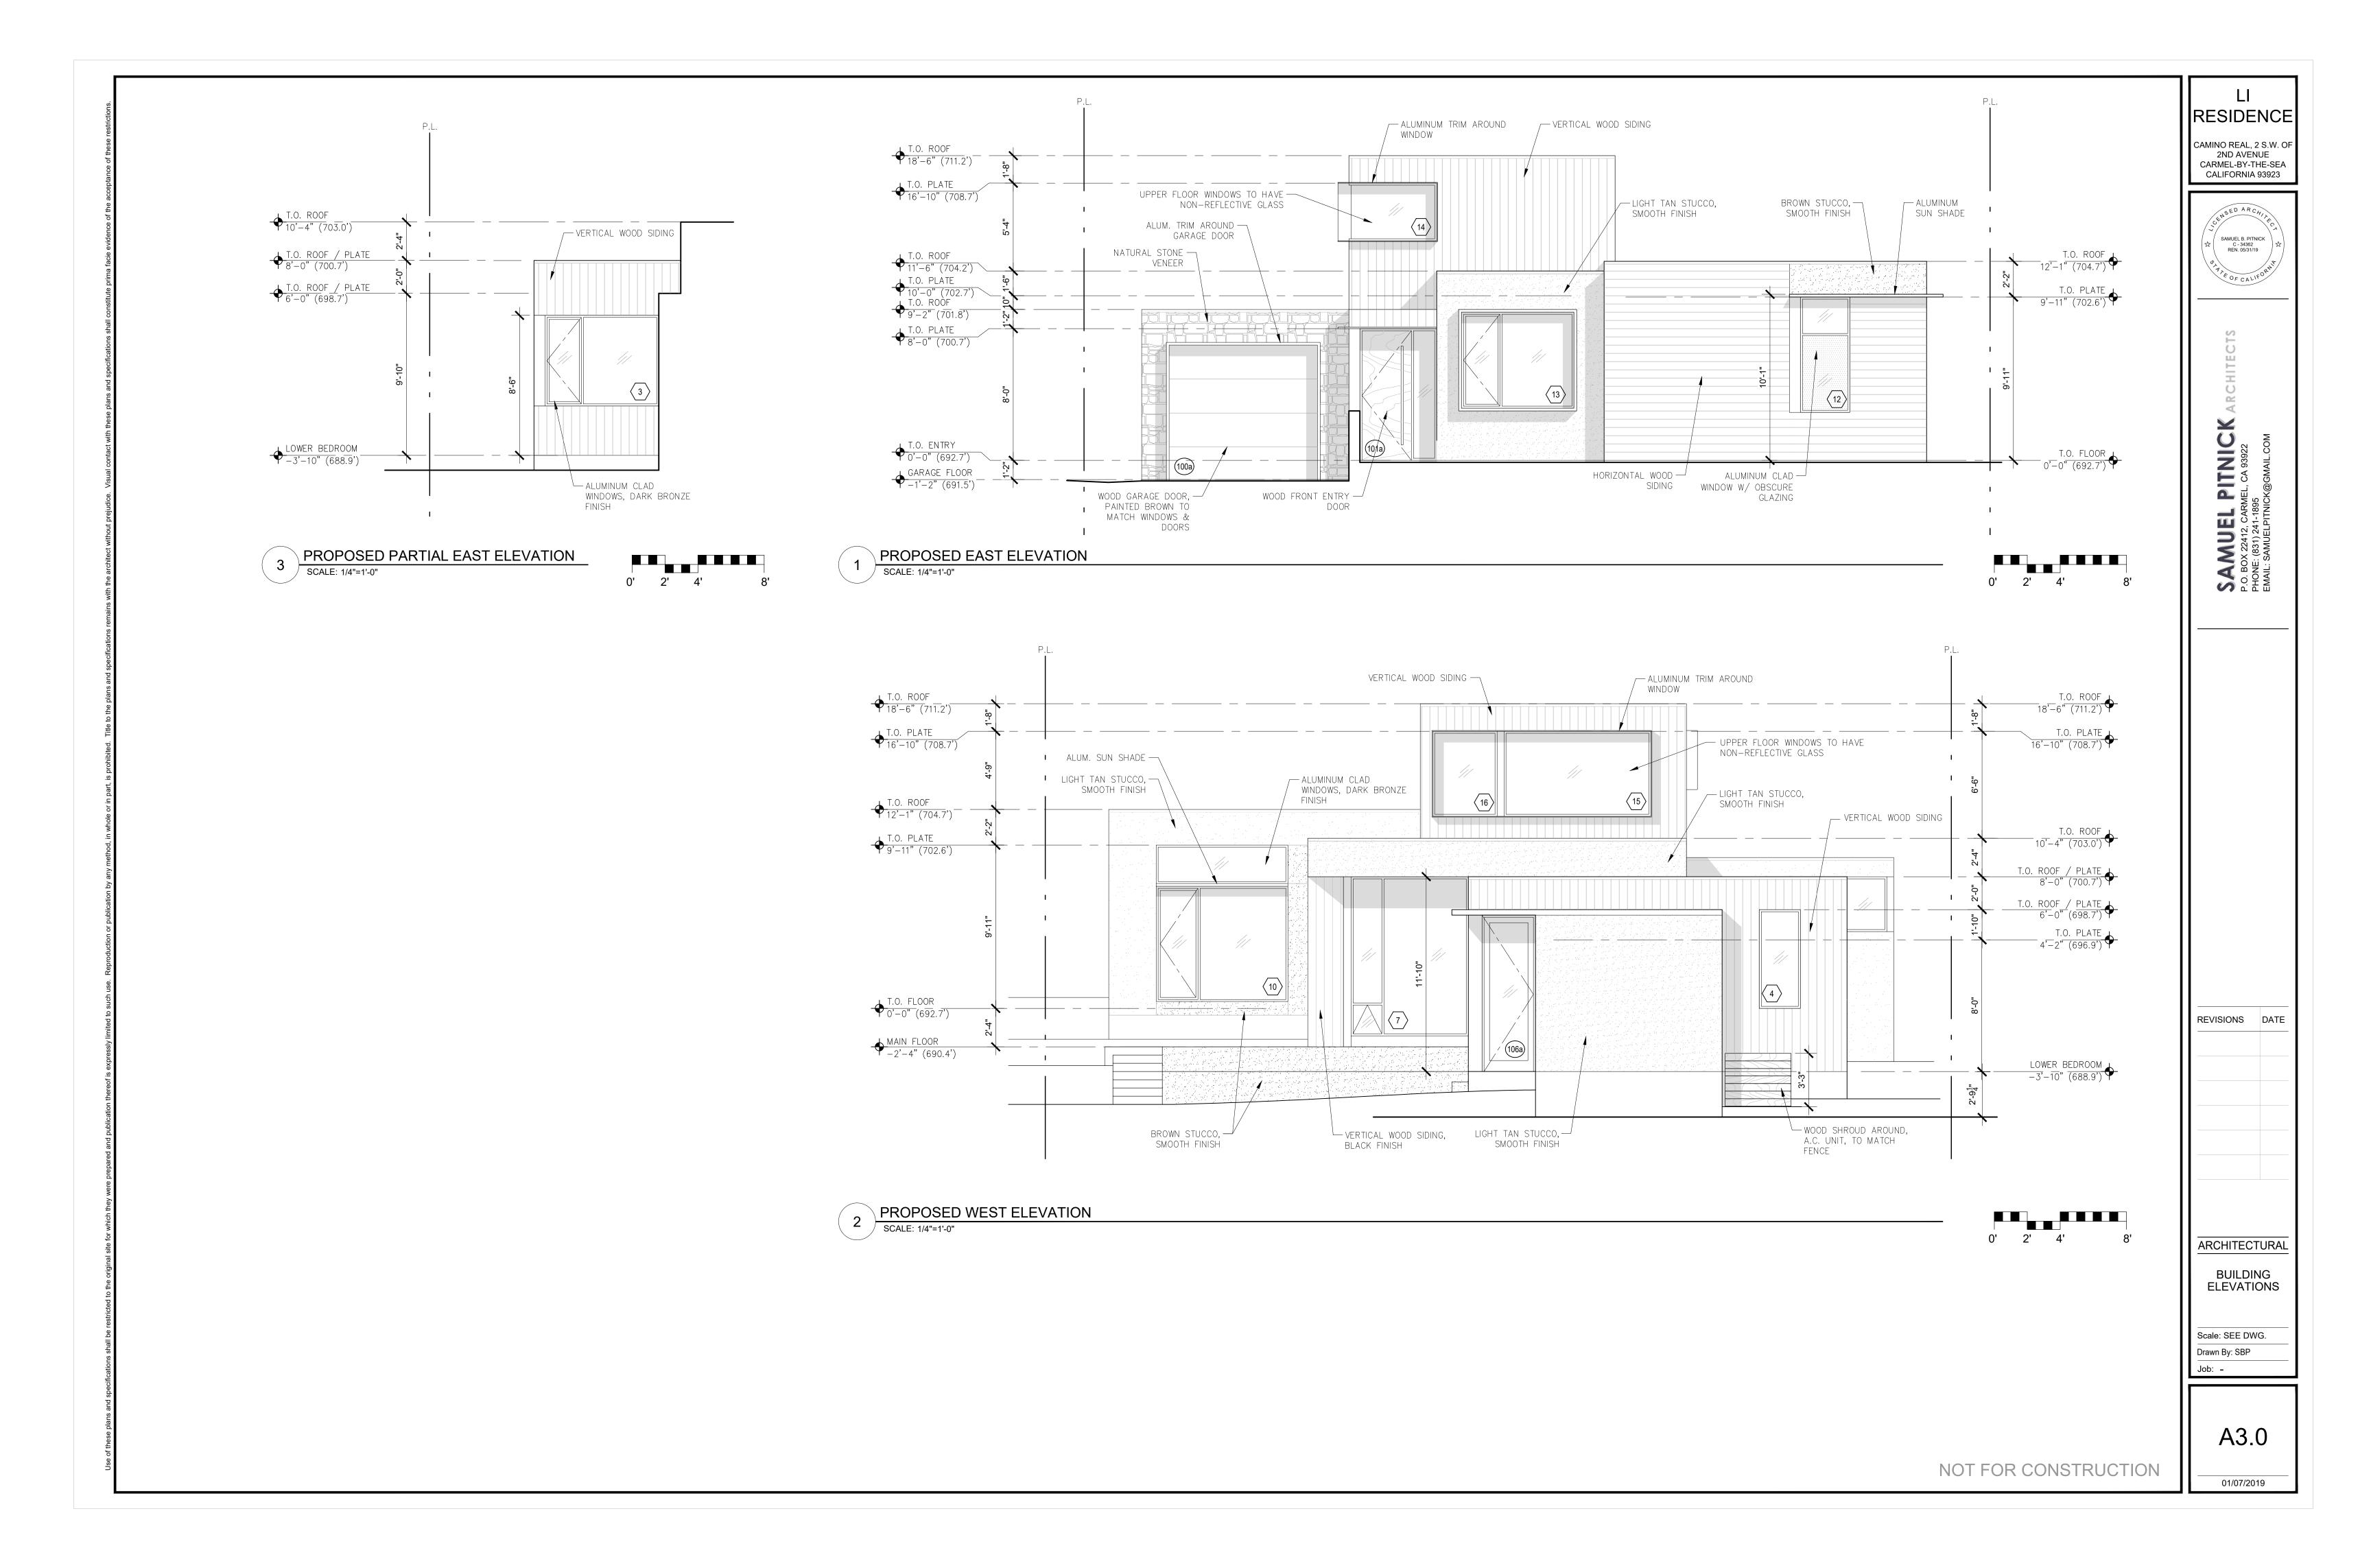

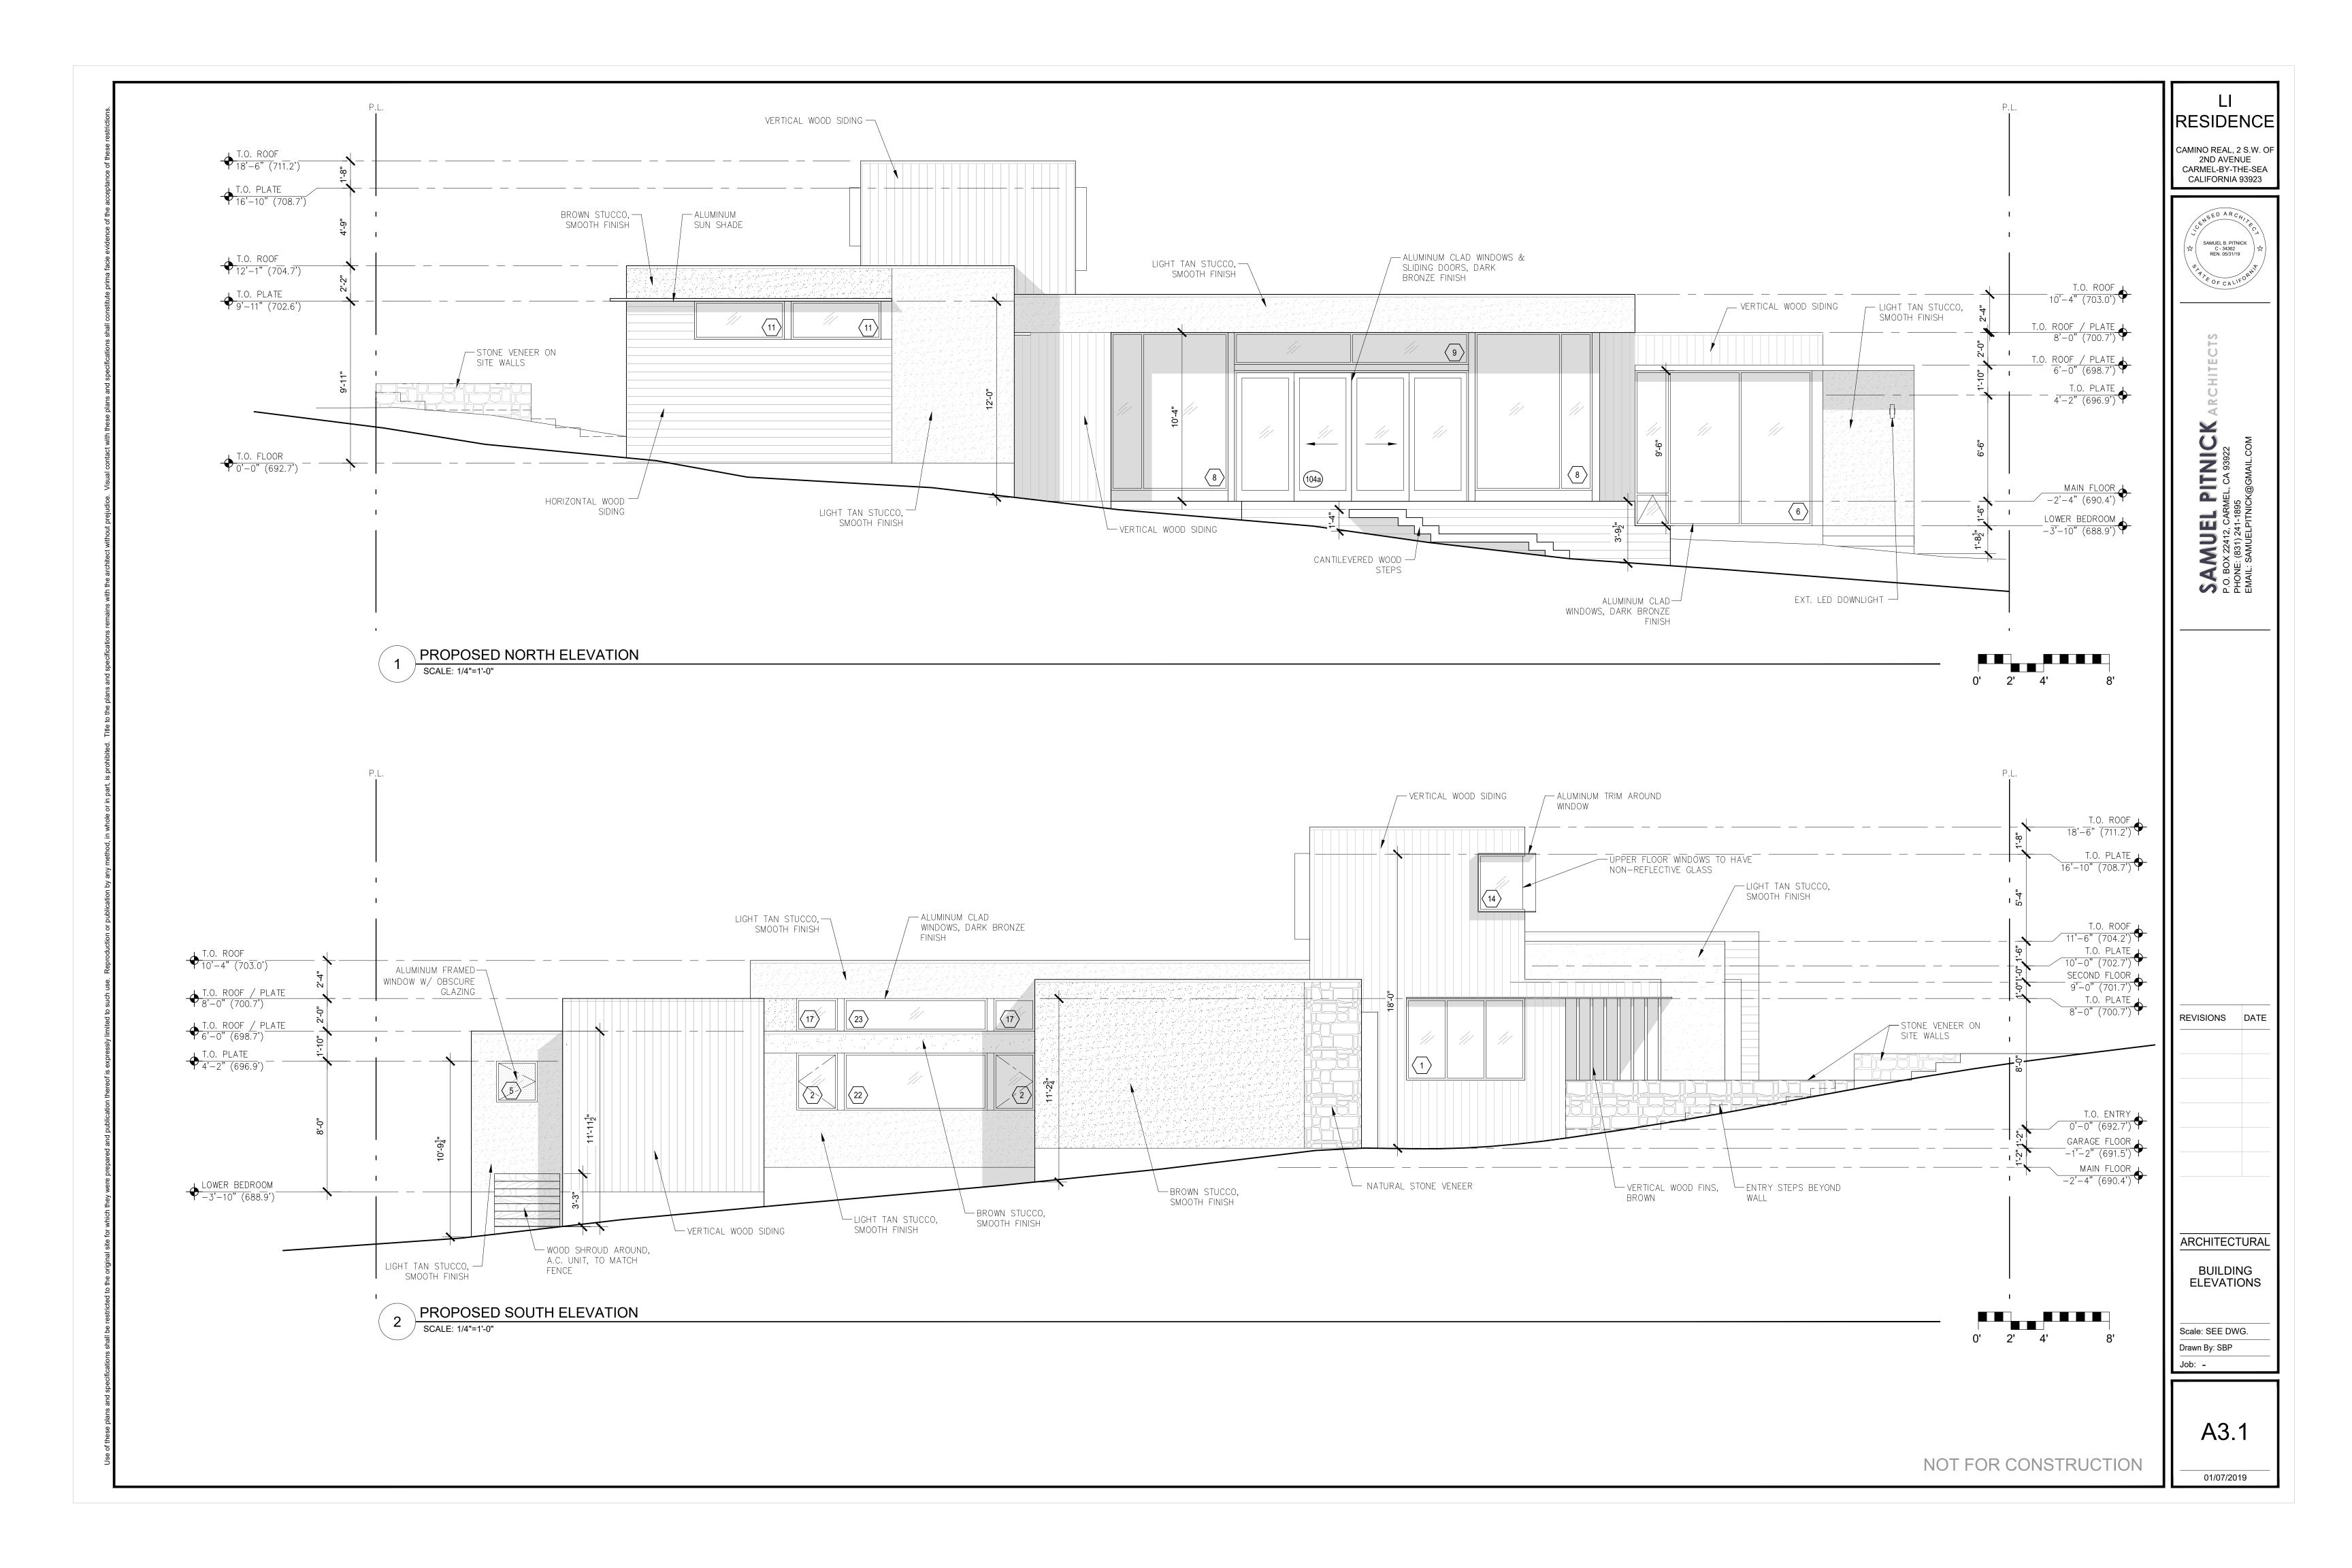


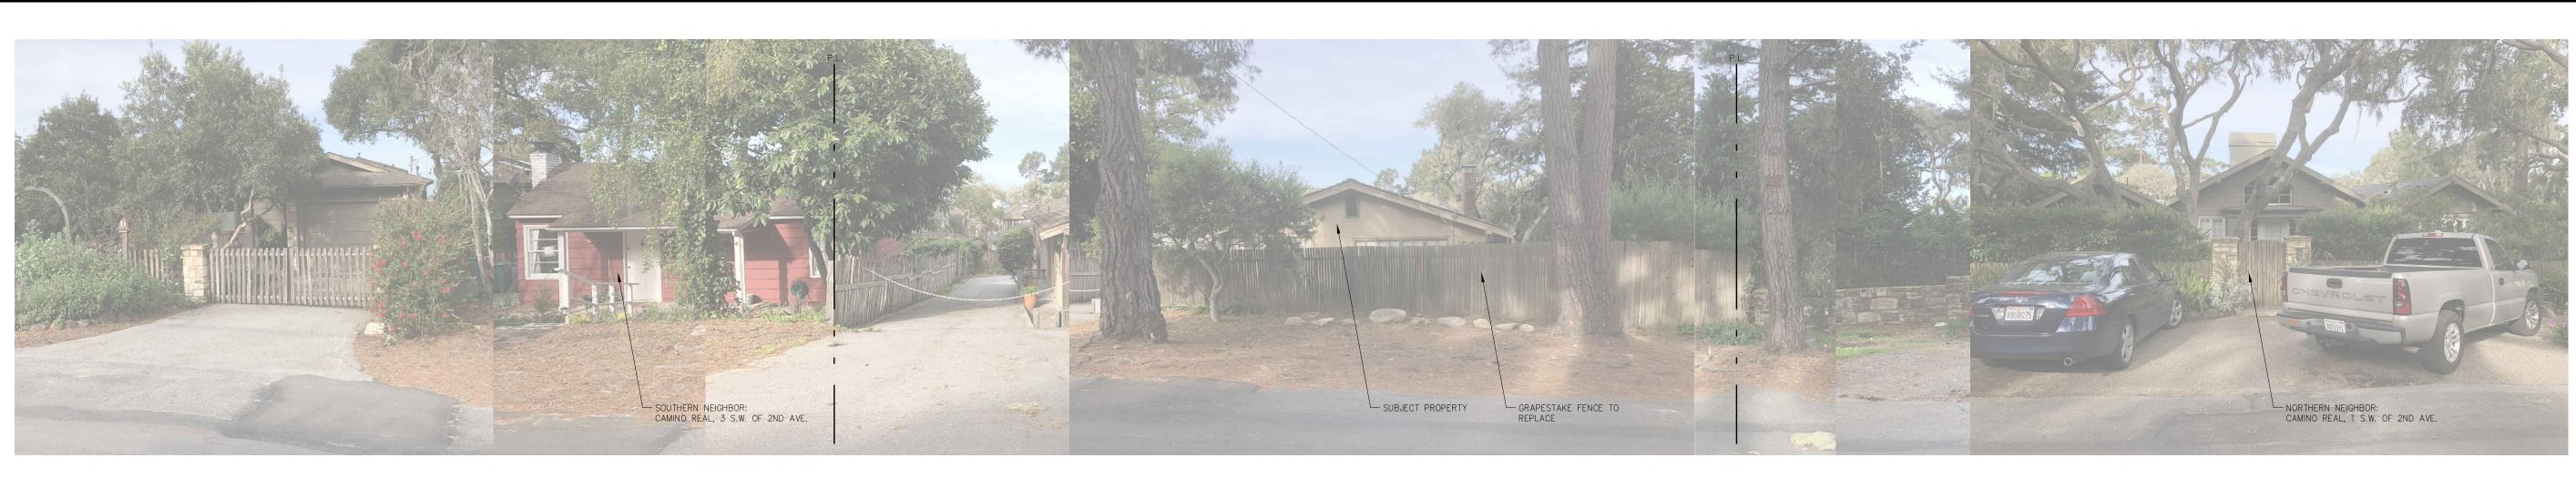



1 EXISTING STREET VIEW ELEVATION SCALE: N.T.S.




PROPOSED STREET VIEW ELEVATION
SCALE: N.T.S.

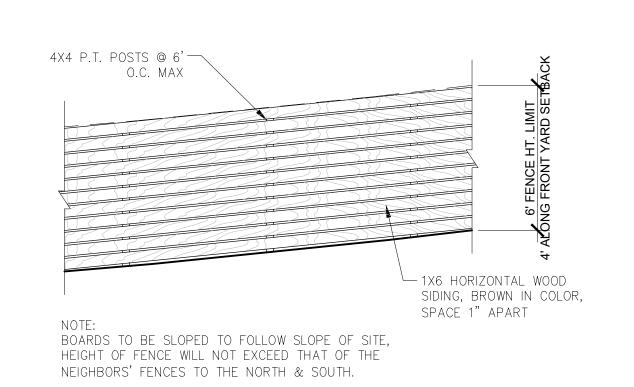

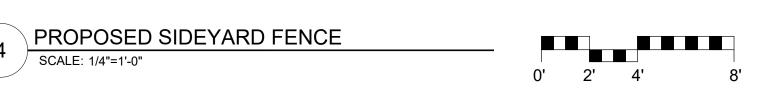

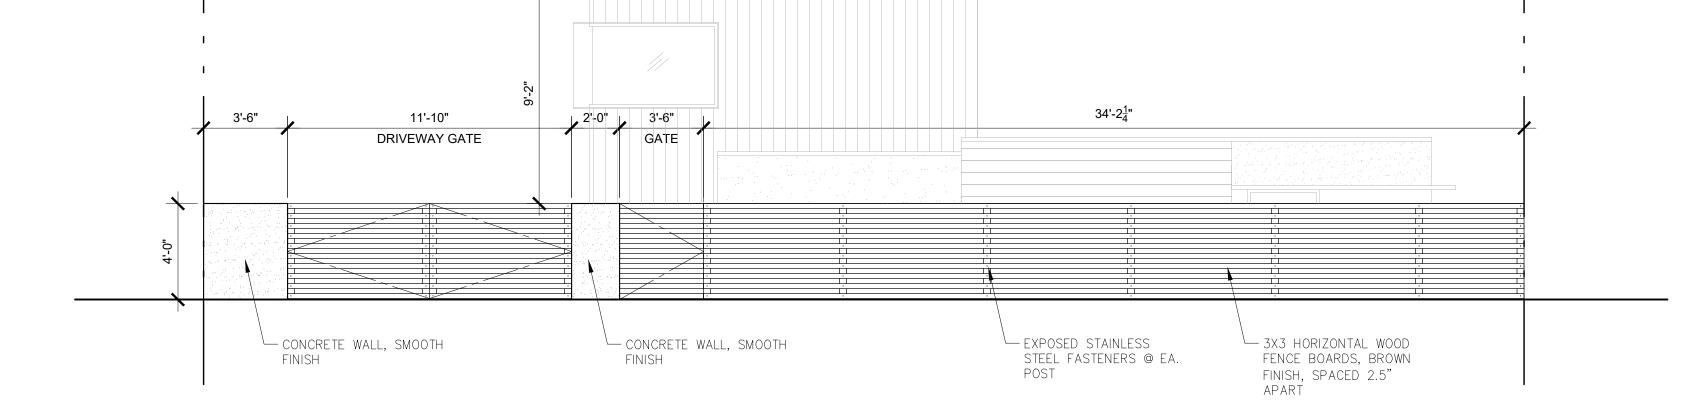



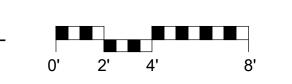

NOT FOR CONSTRUCTION

RESIDENCE

CAMINO REAL, 2 S.W. OF
2ND AVENUE
CARMEL-BY-THE-SEA
CALIFORNIA 93923

SAMUEL B. PITNICK
C-34362
REN. 05/31/19

SAMUEL PITNICK ARCHITEC P.O. BOX 22412, CARMEL, CA 93922 PHONE: (831) 241-1895 EMAIL: SAMUELPITNICK@GMAIL.COM

REVISIONS DATE

ARCHITECTURAL


STREET
VIEW
ELEVATIONS


Scale: SEE DWG.

Drawn By: SBP

Job: -

A3.2

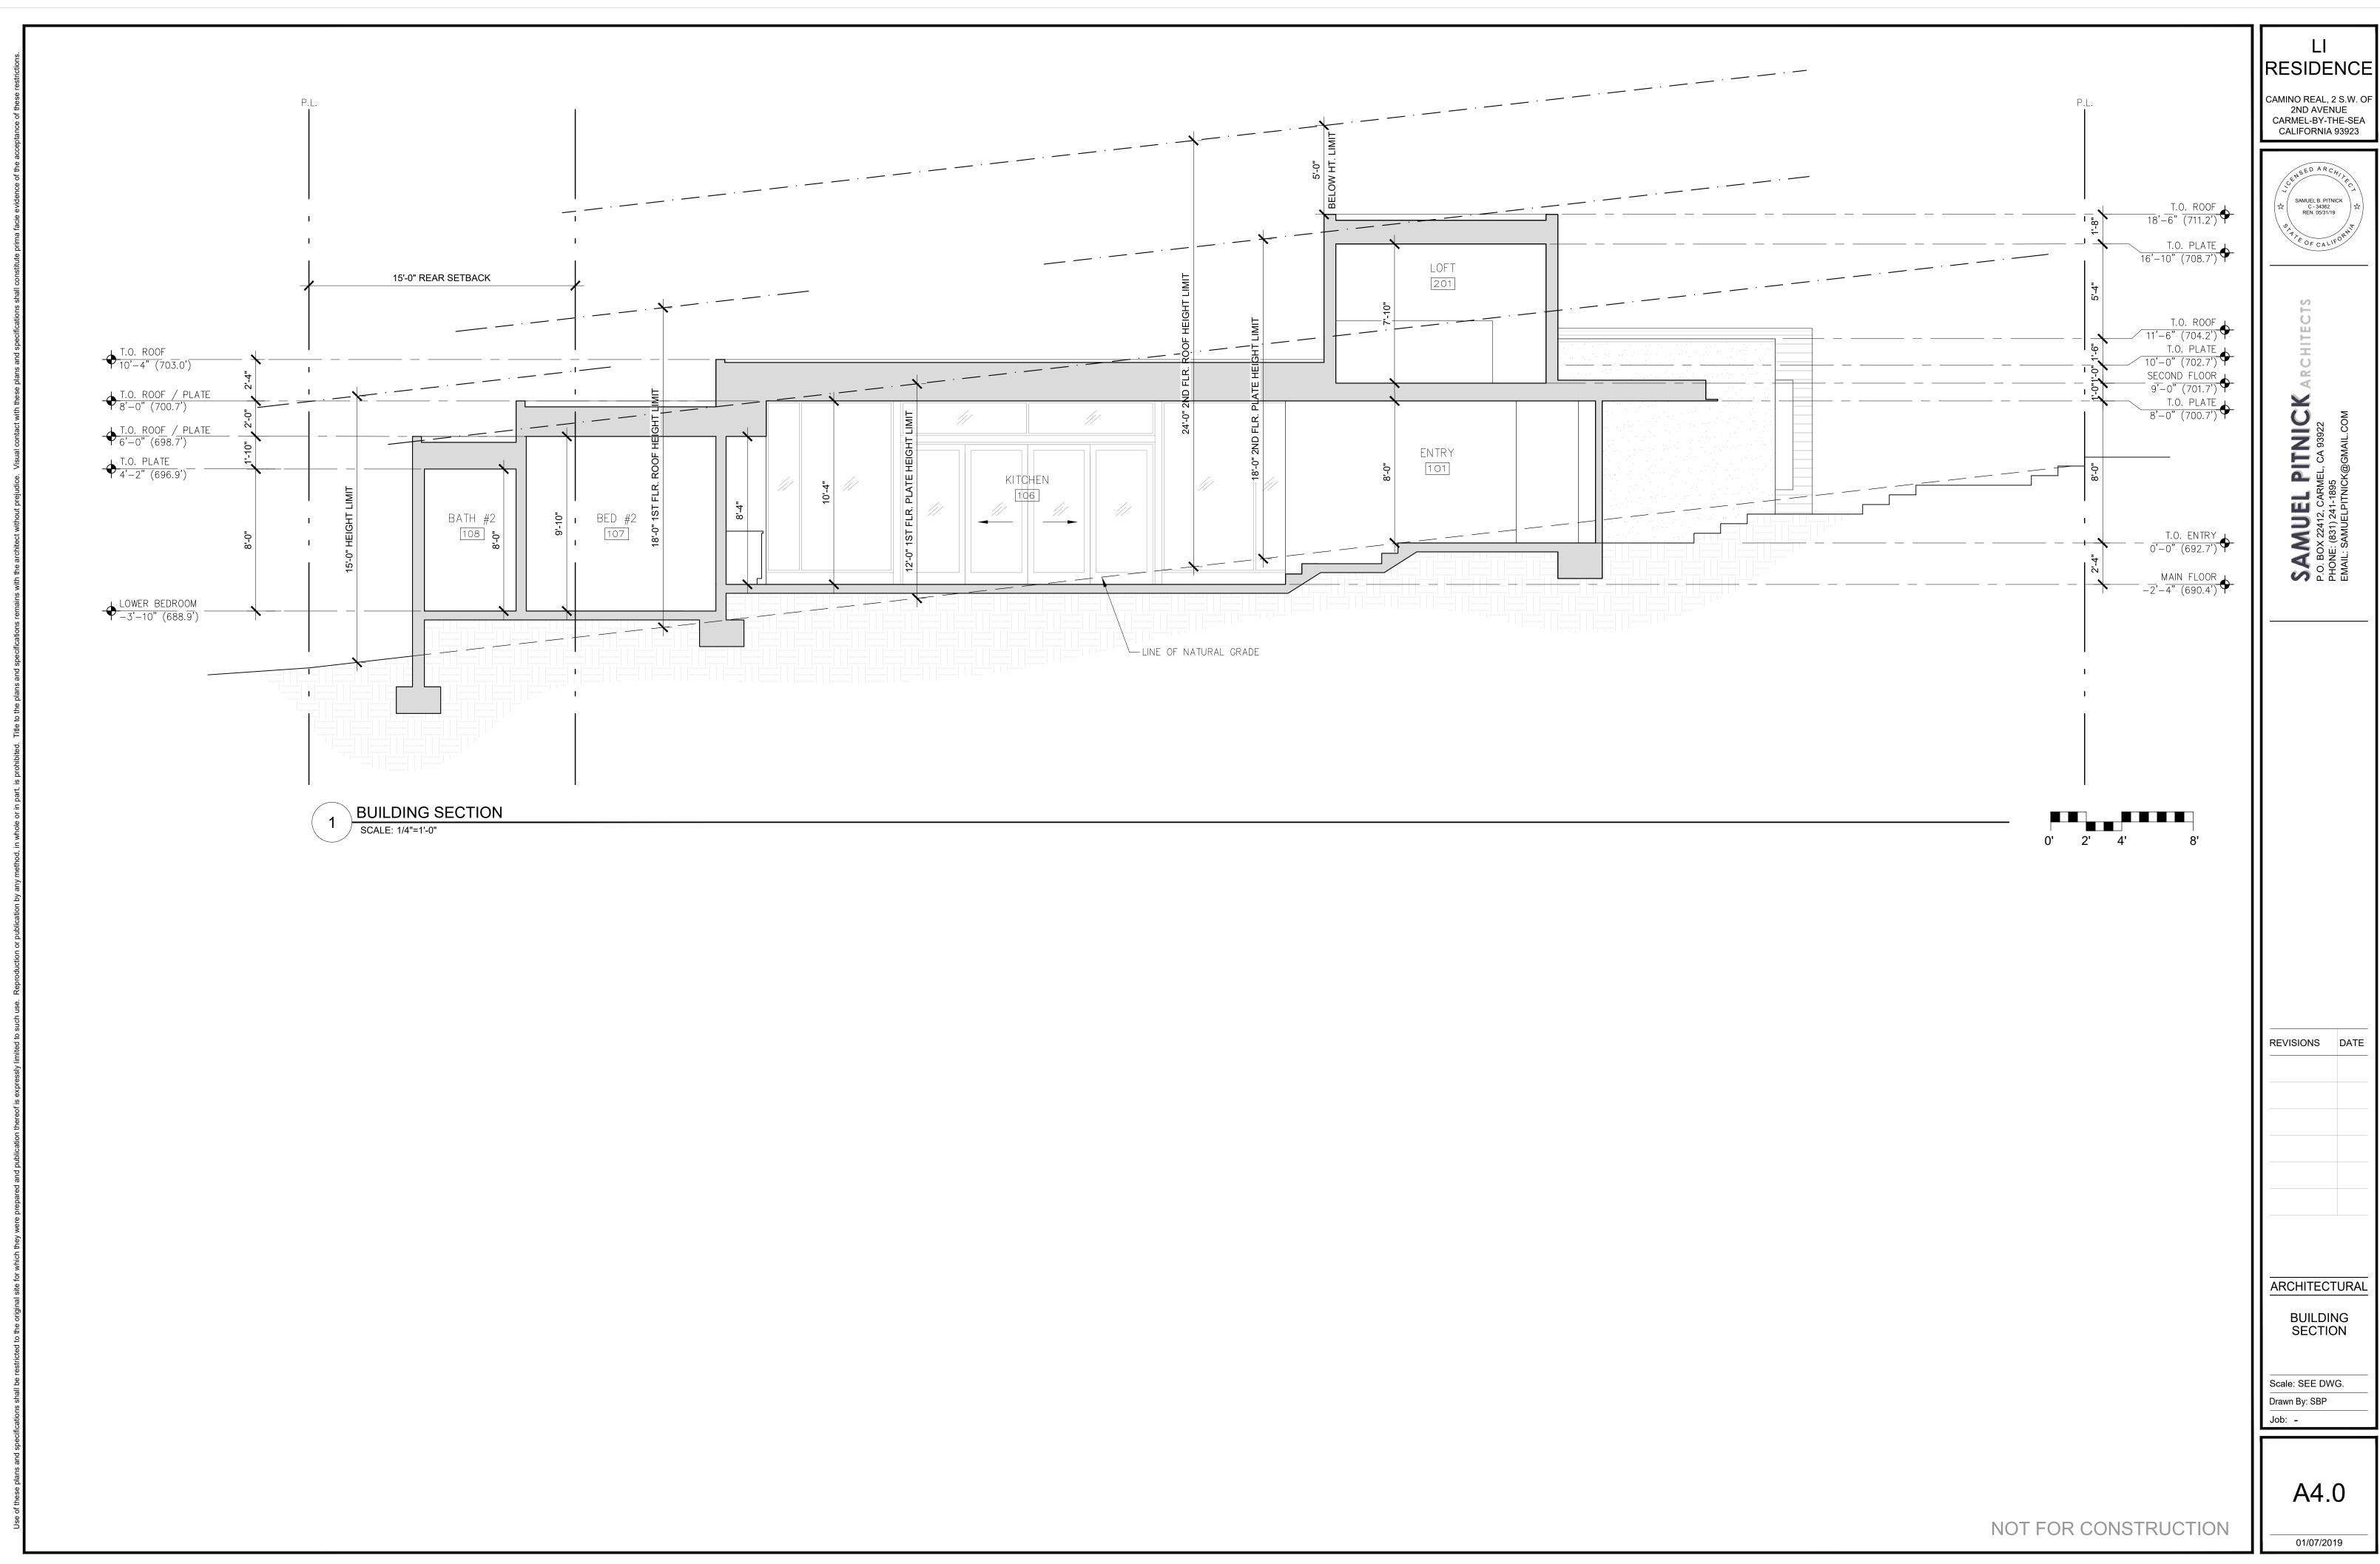

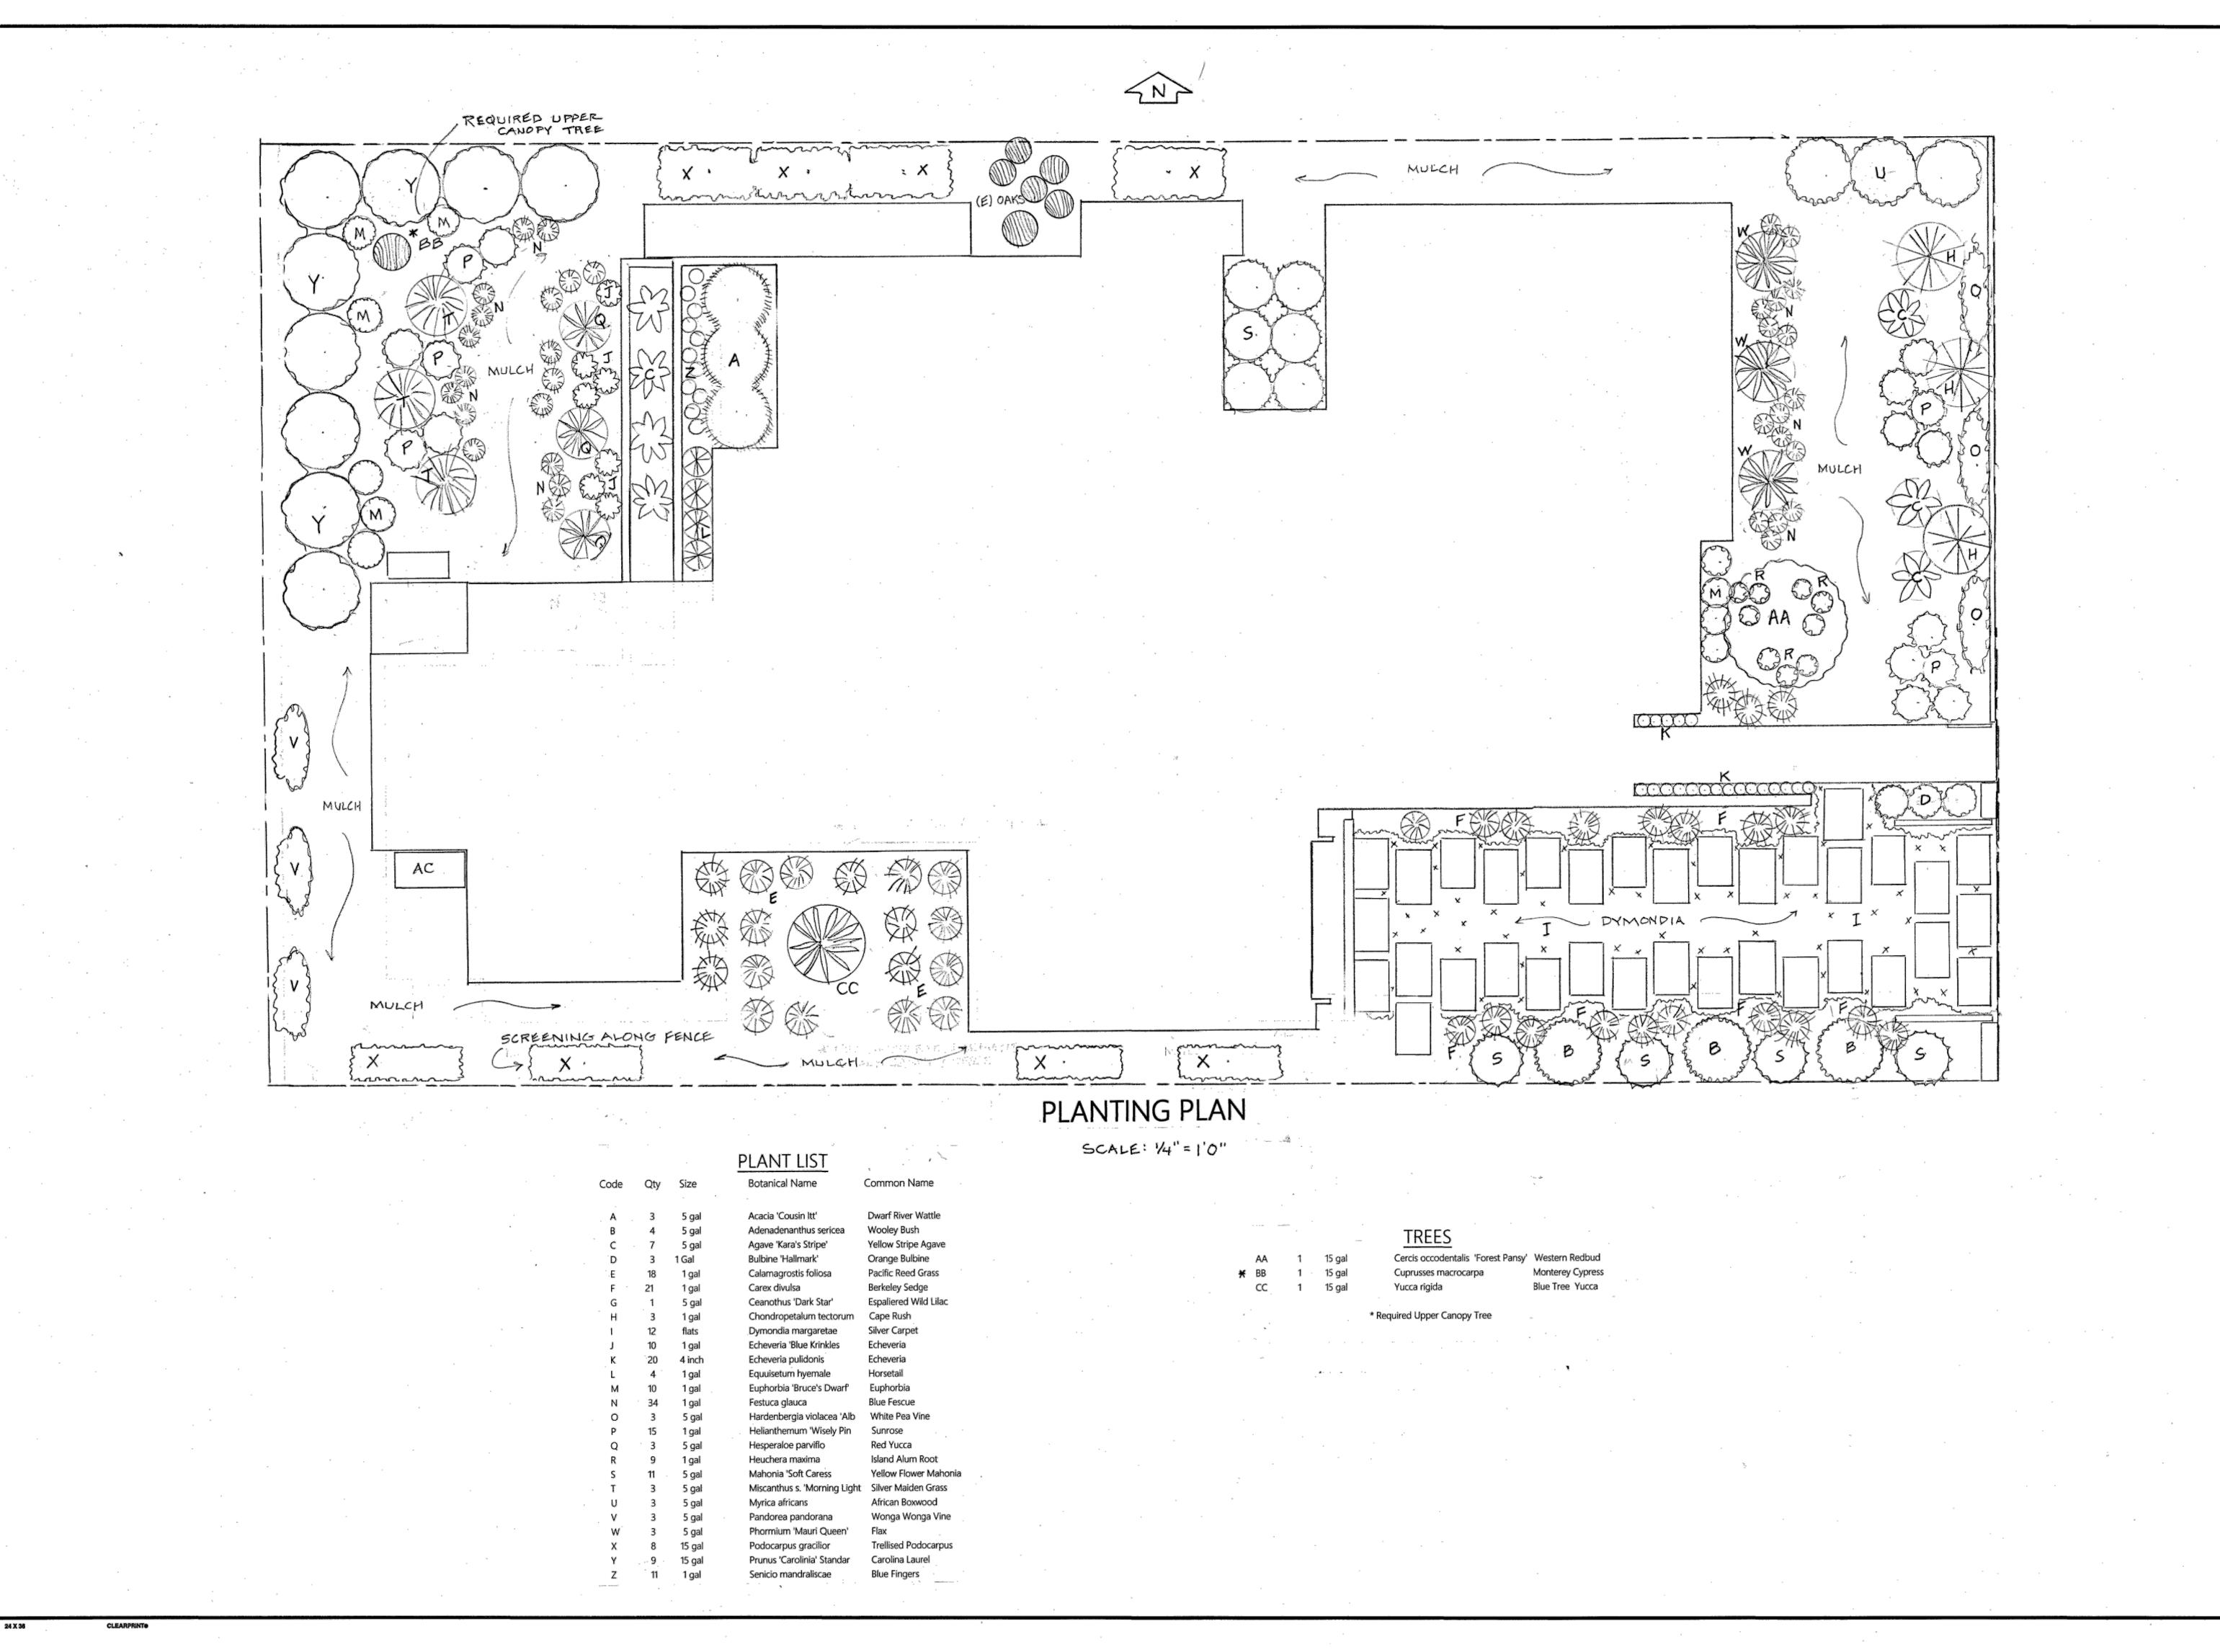

10/24/2018 RS

DESIGN 33@ATT.Net

ROBERI SHULEK DESIGI PO BOX 2152 RStoweS3@ATT.


PLANTING PLAN APN 010-241-002

Li RESIDENCE
Camino Real 2 S/W of 2nd Avenue
Carmel-by-the-Sea, CA 93921

Date 6/2/2018
Scale 1/4"=1'0"

Job K, LI

Sheet L 1

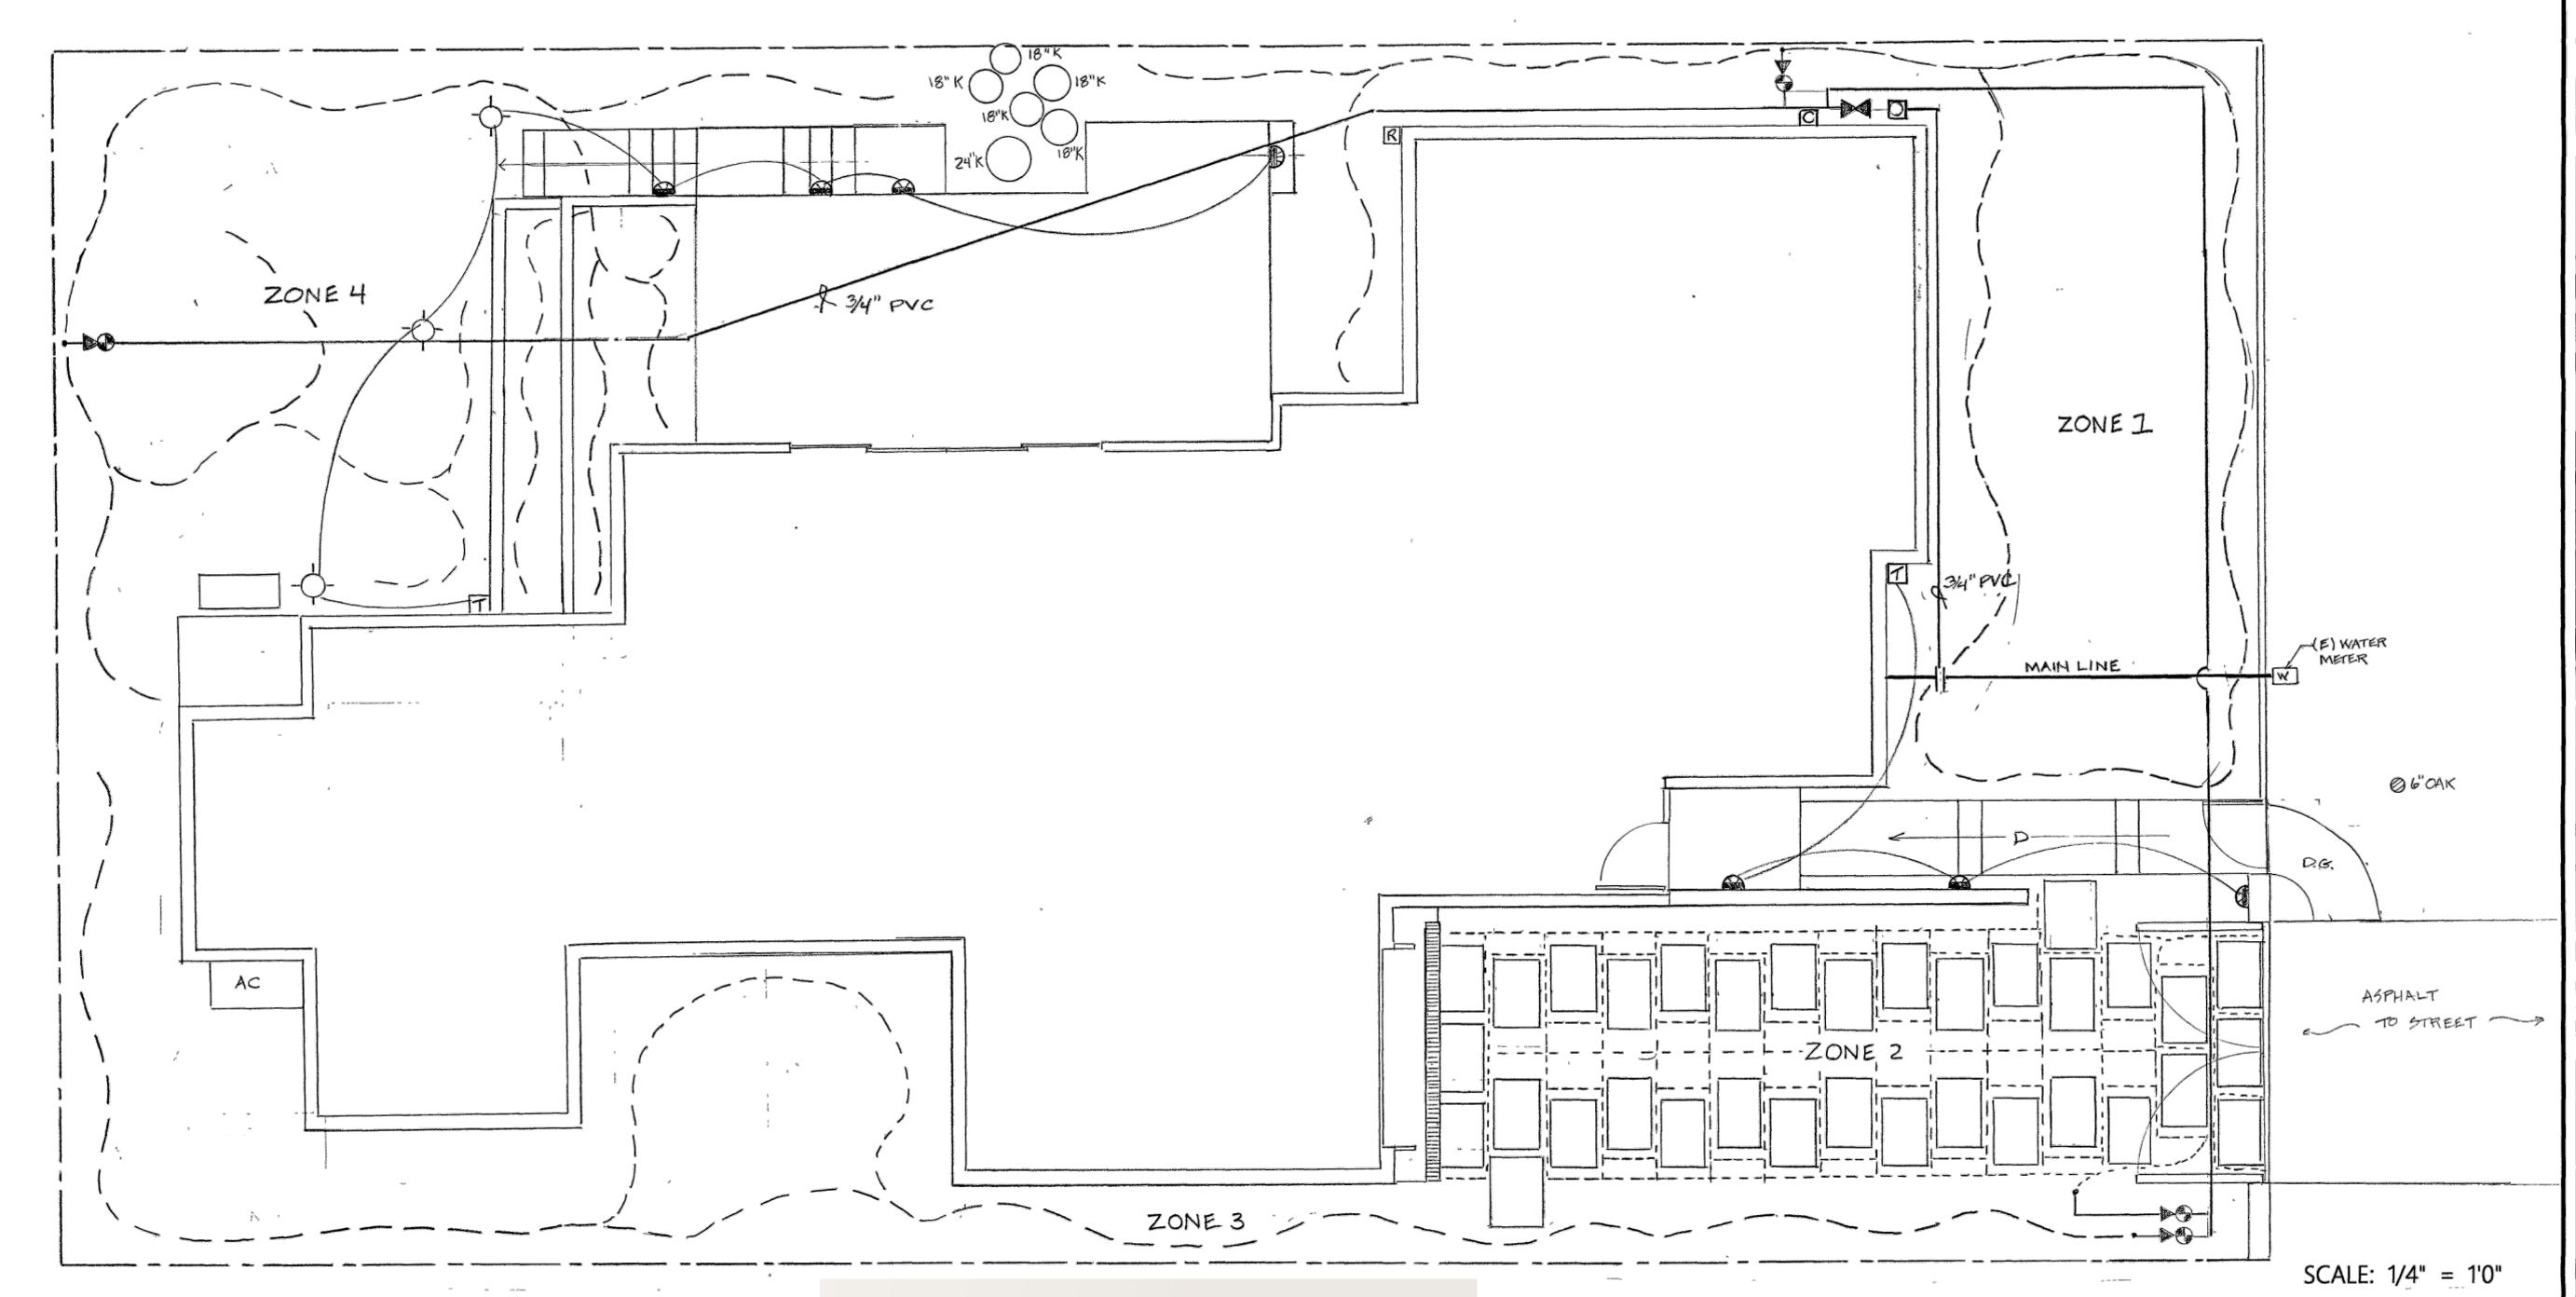

3.62"/9.19 cm

PROPOSED PATHWAY LIGHT

GENERAL IRRIGATION NOTES:

- 1 Irrigation to be run off separate mainline extension with isolation shut off valve
- 2 All drip lines to have in-line filter
- 3 Pressure for regulator for drip irrigation to be regulated to 25 -35 PSI
- 4 All valves to be sub-grade within a weatherproof valve box,
- gravel base and lined with gopher wire
- 5 Contractor shall demonstrate the operation system to the owner and provide copy of operating manual and warranty

IRRIGATION LEGEND:

─ Point of connection from mainline Gate shut off valve

▶ ■ Backflow Prevention Assembly

3/4 " pvc Schedule 40 to valves [™] Control Valve to Drip - Hunter PGV 3/4" globe valve

with 30 PSI pressure regulator and filter Drip Zone Riser from PVC to 1/2" tubing

Lateral tubing to emitters 1/2" Polyetheline

.---Netafim subsurface drip tubing C Controller - Hunter Pro C
Rain Sensor - Hunter Rain Clik




The MS pairs the popular styling of the MM with the energy efficiency and long life of LED technology. Choose brass or a variety of powder coat finishes to add contrast or subtly complement the surroundings.

MS: Wall Light

NUMBER OF LEDS:	1
HALOGEN LUMEN OUTPUT EQUIVALENT:	10 Watt
USEFUL LED LIFE (L70):	50,000 hrs avg
INPUT VOLTAGE:	10 to 15V
VA TOTAL: (Use this number to size the transformer)	2.4
WATTS USED:	2.0
LUMENS PER WATT (EFFICACY)	25
MAX LUMENS:	52
CCT (Ra)	78.5

SCALE: N.T.S.

PROPOSED STEP & LOW WALL LIGHT

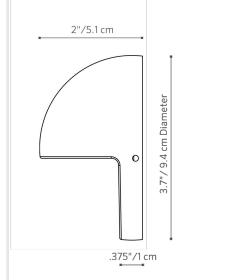

ZONES 1-4 All Mediterranean climate drought tolerant plant material

GENERAL LIGHTING NOTES:

- 1 All lighting shall comply with the requirements of the CA Energy Code, Title 24
- 2 Installing contractor shall verify all dimensions and areas before start of job
- 3 All direct burial 12 gauge low volt wiring shall be 6" below grade and
- adjacent to hardscape where possible
- 4 All materials shall be new and in perfect condition
- 5 Contractor shall demonstrate the operation system to the owner and provide copy of operating manual and warranty.

LIGHTING LEGEND

- T FX Luminaire 150 Watt LX Transformer Watts Stainless Steel Finish
- -O- FX Luminaire HC Path Light
- FX Luminaire MS Wall Light
- 12 gauge direct burial low voltage wiring

Date 6/2/2018 Scale 1/4"=1'0" Drawn 1895

AND

IRRIGATION

RESIDEN

^c 2nd Avenue CA 93921

11/23/2018 RS

JOBK. LI

CAMINO REAL, 2 S.W. OF 2ND AVENUE CARMEL-BY-THE-SEA CALIFORNIA 93923

AMUEL PIINICK ARCHITECT:
BOX 22412, CARMEL, CA 93922
NE: (831) 241-1895
IL: SAMUELPITNICK@GMAIL.COM

REVISIONS DATE

ARCHITECTURAL

PROJECT RENDERINGS

Scale: SEE DWG.

Scale: SEE DWG

Drawn By: SBP

Job: -

1



OCUITE CTUDAL

PROJECT RENDERINGS

Scale: SEE DWG.
Drawn By: SBP

2

01/07/2019

NOT FOR CONSTRUCTION



ARCHITECTURAL

PROJECT RENDERINGS

Scale: SEE DWG.



ARCHITECTURAL

PROJECT RENDERINGS

Scale: SEE DWG.

01/07/2019

NOT FOR CONSTRUCTION



CAMINO REAL, 2 S.W. OF 2ND AVENUE CARMEL-BY-THE-SEA CALIFORNIA 93923

AMUEL PITNICK ARCHITECTS
. BOX 22412, CARMEL, CA 93922
DNE: (831) 241-1895
AIL: SAMUELPITNICK@GMAIL.COM

REVISIONS DATE

ARCHITECTURAL

PROJECT RENDERINGS

Scale: SEE DWG.

Drawn By: SBP

Job: -



SAMUEL PITNICK ARCHITECTS
P.O. BOX 22412, CARMEL, CA 93922
PHONE: (831) 241-1895
EMAIL: SAMUELPITNICK@GMAIL.COM

REVISIONS DATE

ARCHITECTURAL

PROJECT RENDERINGS

Scale: SEE DWG.

Drawn By: SBP

01/07/2019

NOT FOR CONSTRUCTION



1 RENDERING 6 - SIDE OF HOUSE LOOKING NORTH SCALE: N.T.S.